



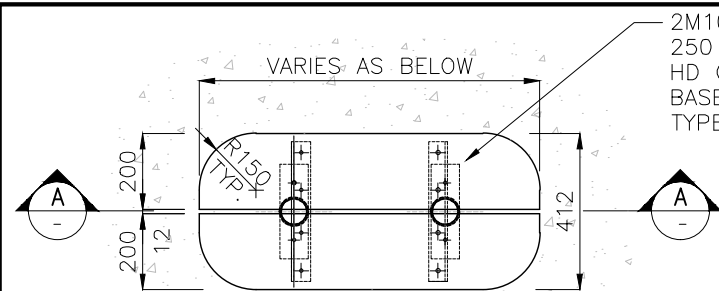
GENERAL NOTES

- ENSURE PARK ELEMENTS ARE LOCATED AND CONSTRUCTED IN ACCORDANCE WITH DETAILED LANDSCAPE PLAN AND PARKS CHAPTER OF INFRASTRUCTURE DESIGN PLANNING SCHEME POLICY.
- MATERIAL CHOICES ARE TO BE DETERMINED ON THE GROUNDS OF SUSTAINABILITY, LOW MAINTENANCE, VANDAL RESISTANCE, PRODUCT AVAILABILITY AND SUITABILITY TO THE CLIMATIC CONDITIONS. MATERIALS ARE TO BE LOCALLY SOUCED.
- WHERE SPECIFIED - SITE FURNITURE IS TO BE INCORPORATED AS PART OF INTEGRATED PICNIC SETTING NODE. REFER BSD-10003 FOR SUPPLIERS.
- ENSURE MOWN HEIGHT OF GRASS (TURF) AREAS FINISHES FLUSH WITH PAVEMENT AREAS.
- ENSURE GARDEN AREAS (MULCH) FINISH 25mm BELOW ADJACENT F.S.L's OF PAVEMENT AREAS.
- PICNIC NODES TO COMPLY WITH AUSTRALIAN STANDARDS AND COUNCIL REQUIREMENTS FOR ACCESS & MOBILITY (AS 1428).
- ENSURE PARK ELEMENTS ARE CLEANED OF CONCRETE SLURRY OR SPRAY WHEN INSTALLED TO PREVENT STAINING OR DAMAGE TO APPLIED FINISHES.
- COLOUR SELECTION IN ACCORDANCE WITH STANDARD BCC CORPORATE COLOUR PALETTE.
- REFER TO THE BRISBANE ACCESS AND INCLUSION PLAN 2012-2017 FOR FURTHER INFORMATION WHEN PLANNING AND DESIGNING THE BUILT ENVIRONMENT TO REASONABLY CONSIDER ACCESS AND INCLUSION FOR ALL WHERE APPROPRIATE.
- ALL DIMENSION IN MILLIMETRES (U.N.O.).

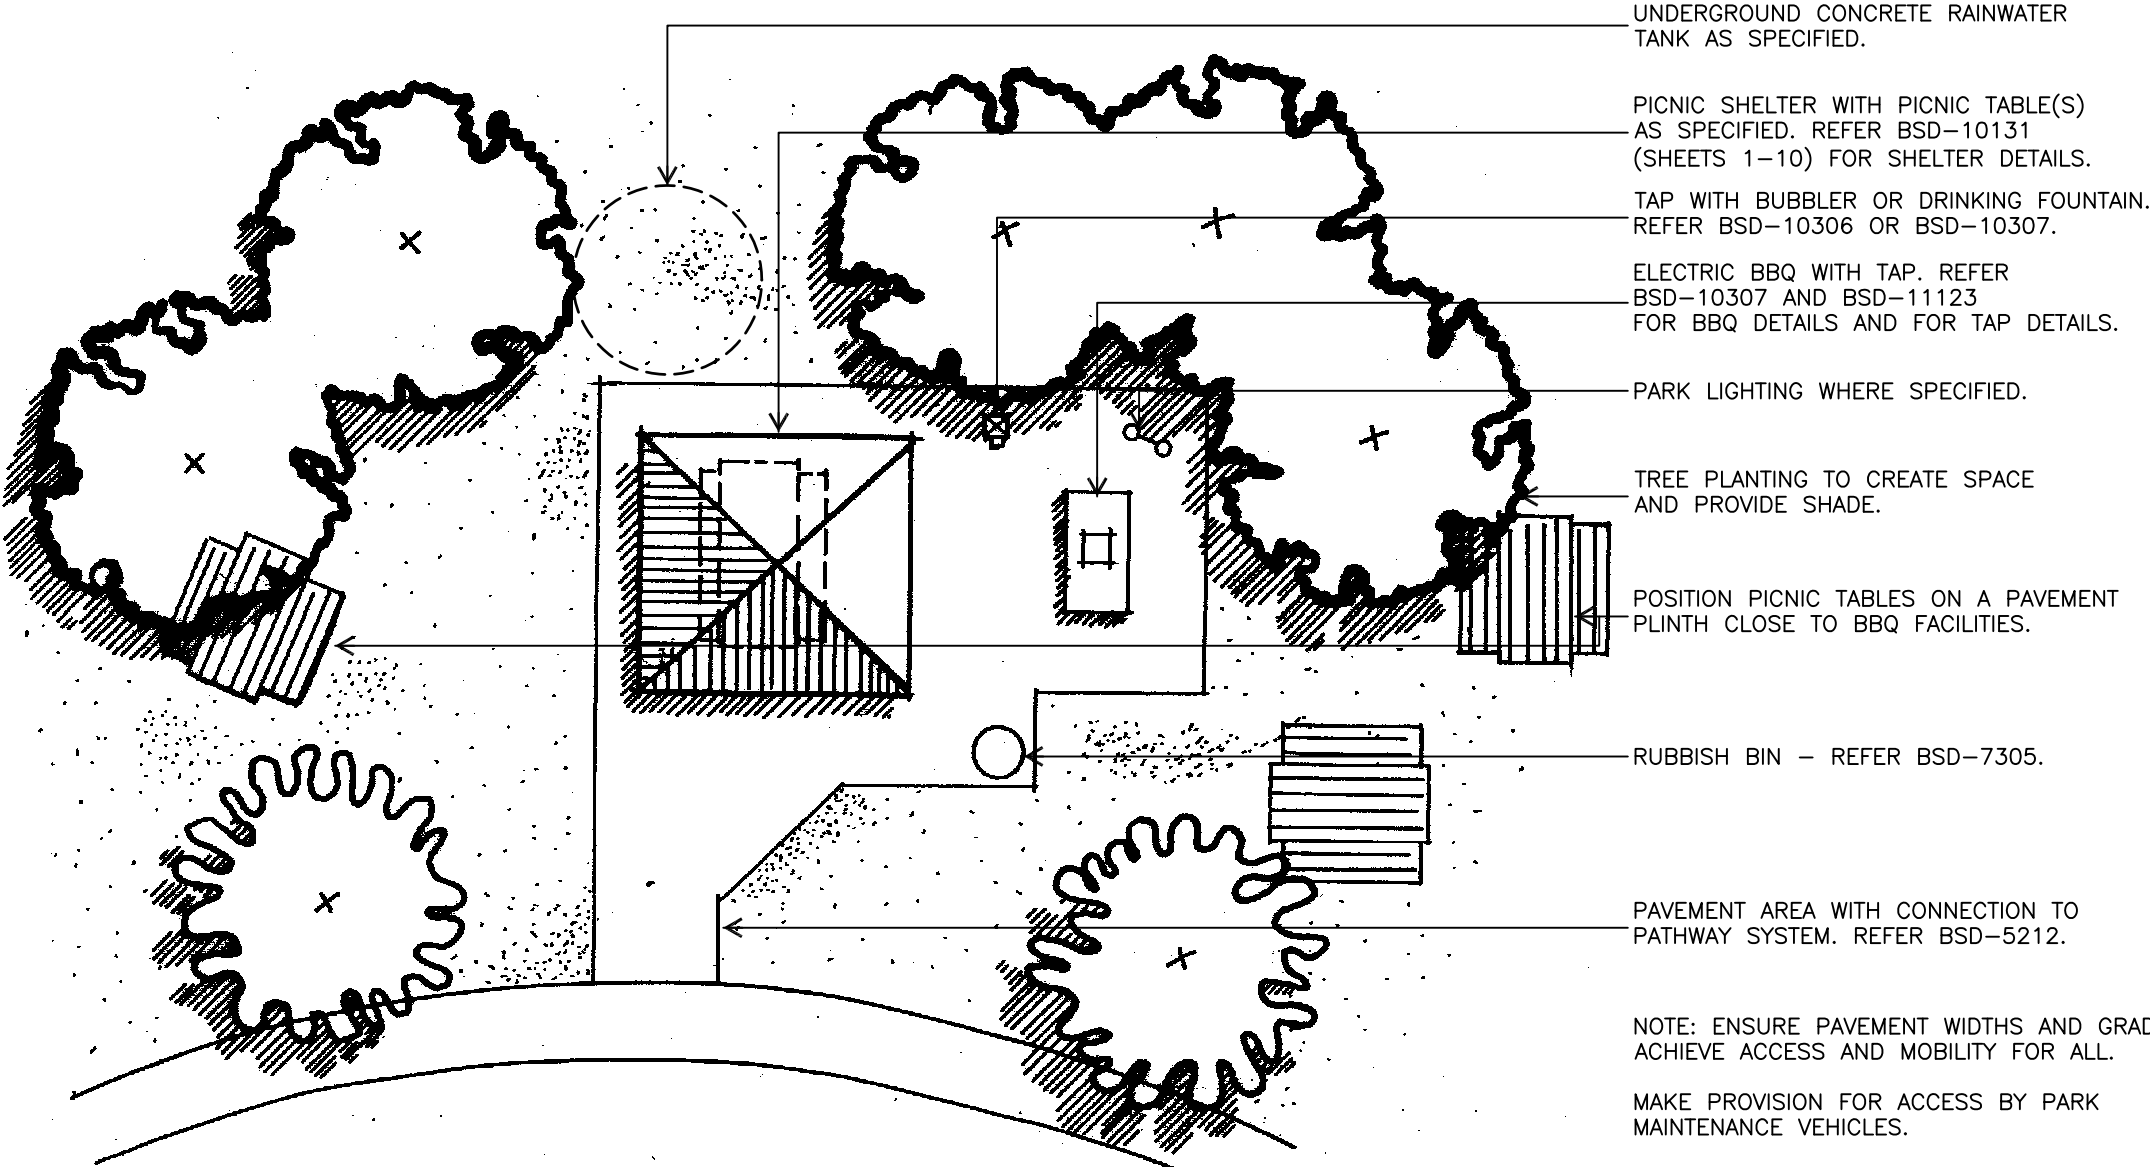


PICNIC NODE - PLAN


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| | | | | | | DRAWN | CP0 - P&D | DATE | OCT '13 | | | | |
| | | | | | | CHECKED | UMD - E&P & IMB | DATE | OCT '13 | | | | |
| | | | | | | DRAWING FILENAME | BSD-10101_2of2.dwg | | | | | | |
| A | Drawing Converted From UMS Series April 2014 | | | APR '14 | APR '14 | APR '14 | ASSOCIATED PLANS | | | PICNIC SITING NODE PLAN | | | |
| ISSUE | AMENDMENT | | | DRAWN DATE | CHK'D DATE | APPR'D DATE | PRICIPAL PROGRAM OFFICER PARKS | | | | | | |
| | | | | | | | | | | SCALE 1:100 | | | |
| | | | | | | | | | | Dwg No. BSD-10101 | | | |
| | | | | | | | | | | ORIGINAL SIZE A3 | | | |
| | | | | | | | | | | REVISION A | | | |




INDICATIVE PLAN
BENCH SEAT TYPE 1 DETAIL
SCALE 1:20

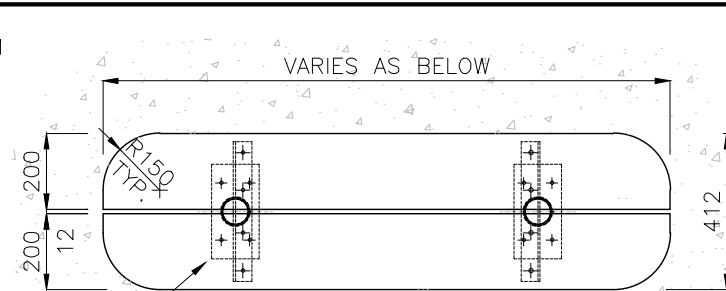


INDICATIVE PLAN
BENCH SEAT TYPE 2 DETAIL
SCALE 1:20

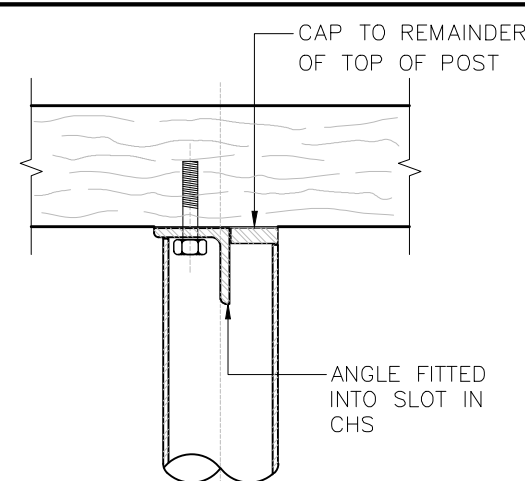


DETAIL A
SCALE: 1:5

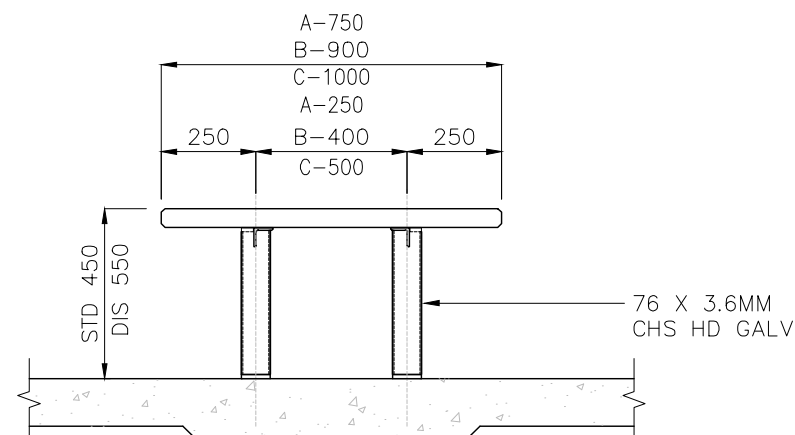


ELEVATION
SCALE 1:20

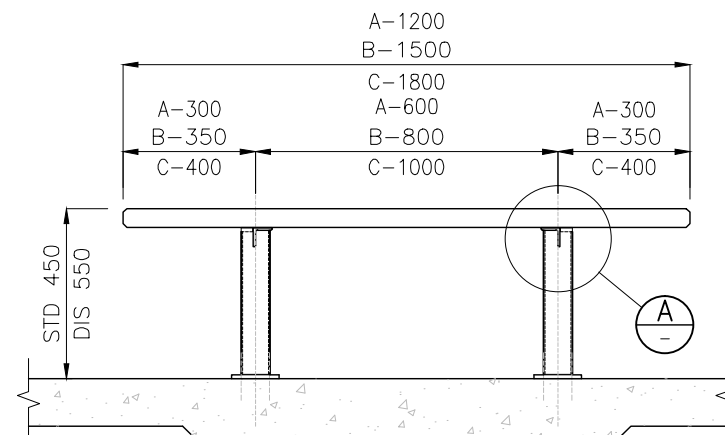


ELEVATION
SCALE 1:20

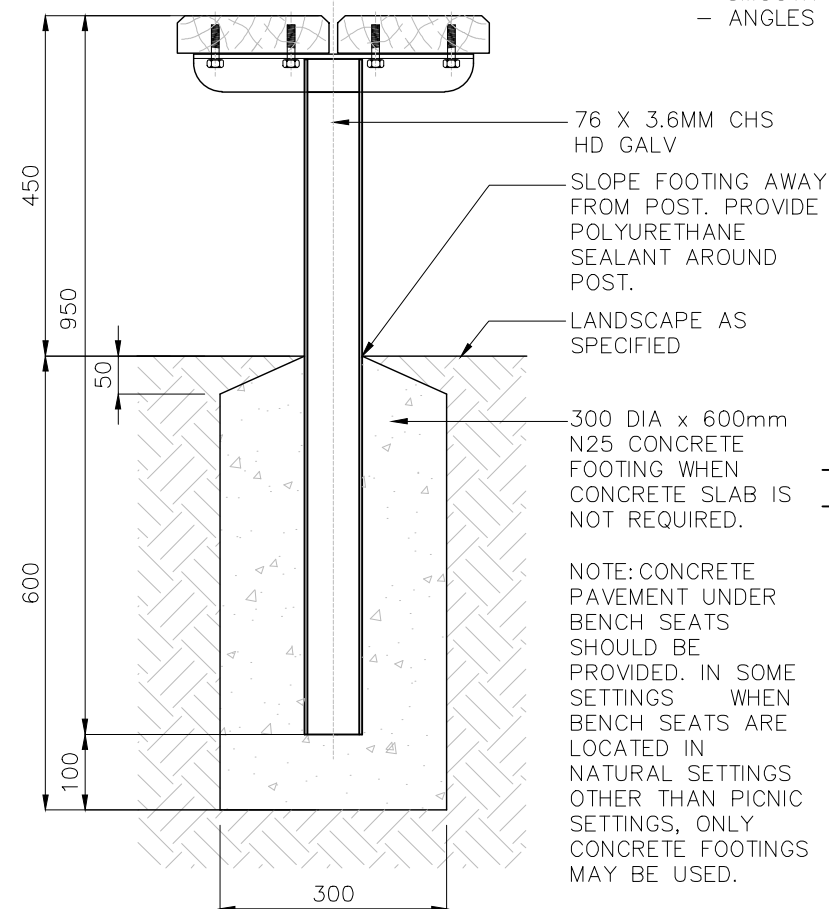


ALTERNATIVE
FOOTING DETAIL
SCALE: 1:10

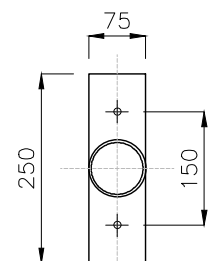


TYPE 1 BASE DETAIL
SCALE: 1:10

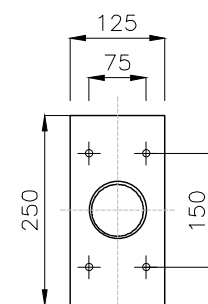

TYPE 2 BASE DETAIL
SCALE: 1:10

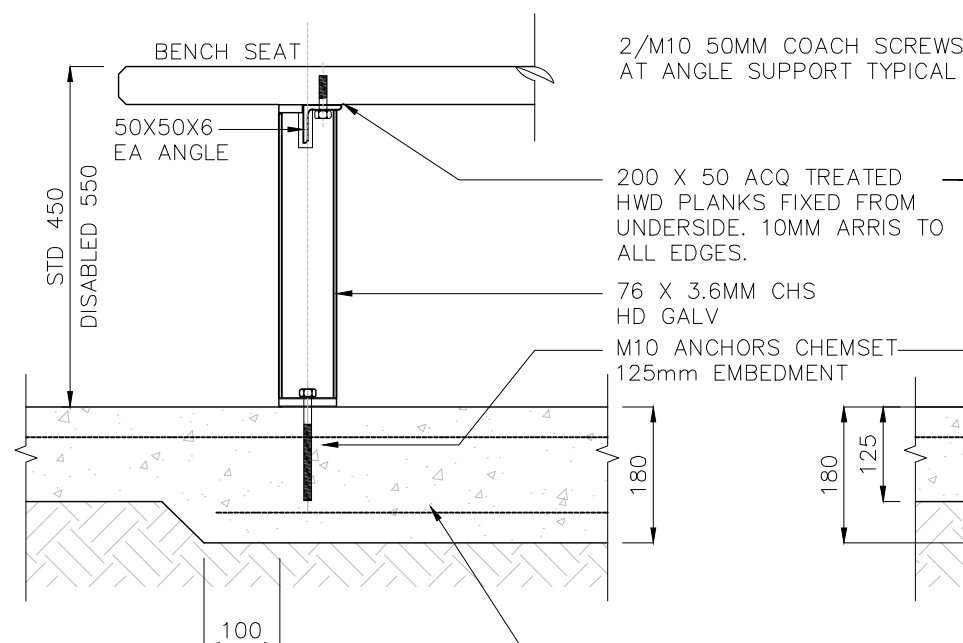

SECTION A-A
SCALE: 1:10

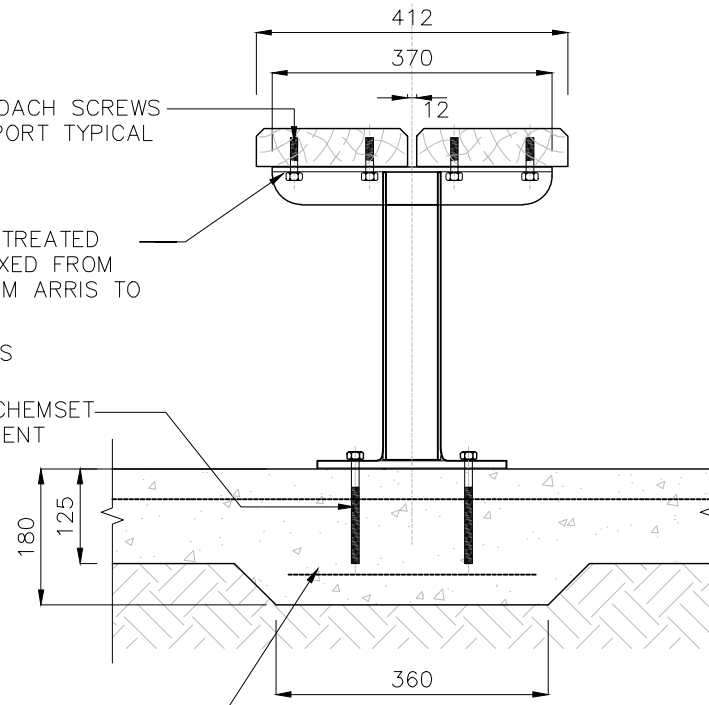

TYPICAL SECTION
SCALE: 1:10

NOTES

- SITE SETOUT TO BE VERIFIED BY SUPERINTENDENT OR LANDSCAPE ARCHITECT PRIOR TO THE COMMENCEMENT OF CONSTRUCTION WORKS.
- VERIFY LOCATION OF ALL SERVICES AND EASEMENTS PRIOR TO THE COMMENCEMENT OF WORKS.
- ALL FOOTINGS ARE TO BE FOUNDED IN THE NATURAL UNDISTURBED SOIL PROFILE WITH A MINIMUM ALLOWABLE SOIL BEARING CAPACITY OF 100kPa UNLESS NOTED OTHERWISE. IF SITE CONDITION IS DIFFERENT, CONSULT A STRUCTURAL ENGINEER
- ALL DIMENSIONS ARE IN MILLIMETRES UNLESS SHOWN OTHERWISE U.N.O
- DIMENSIONS SHALL NOT BE OBTAINED BY SCALING OFF DRAWINGS
- REFER TO BSD-10124 FOR SETOUT OF BENCH SEATS IN PICNIC SETTINGS.
- ALL METALWORK TO BE HD GALVANISED AFTER FABRICATION UNLESS OTHERWISE NOTED
- ALL WELDS TO BE CONTINUOUS, GROUND OFF SMOOTH AND FLUSH
- ANGLES TO BE 50X50X6 MS ROUNDED AT EDGES

76 X 3.6MM CHS
HD GALV

SLOPE FOOTING AWAY
FROM POST. PROVIDE
POLYURETHANE
SEALANT AROUND
POST.

LANDSCAPE AS
SPECIFIED

300 DIA x 600mm
N25 CONCRETE
FOOTING WHEN
CONCRETE SLAB IS
NOT REQUIRED.

NOTE: CONCRETE
PAVEMENT UNDER
BENCH SEATS
SHOULD BE
PROVIDED. IN SOME
SETTINGS WHEN
BENCH SEATS ARE
LOCATED IN
NATURAL SETTINGS
OTHER THAN PICNIC
SETTINGS, ONLY
CONCRETE FOOTINGS
MAY BE USED.

| ISSUE | AMENDMENT | DRAWN DATE | CHK'D DATE | APPR'D DATE |
|-------|----------------|---------------|---------------|----------------|
| A | ORIGINAL ISSUE | DEC '14 | DEC '14 | DEC '14 |

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| DRAWING AUTHORISED FOR PUBLICATION |
| Inga Cendric 2015.06.04 14:43:44+10'00' |
| for ASSET ENGINEERING MANAGER STRATEGIC ASSET MANAGEMENT DESIGN APPROVED |
| C.Wood SENIOR CO-ORDINATOR NATURAL ENVIRONMENT ASSET SERVICES/BRISBANE INFRASTRUCTURE |






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| DRAWN | CP0 - P&D | DATE | DEC '14 |
| CHECKED | BI - FSG - AS | DATE | DEC '14 |
| DRAWING FILENAME | BSD-10116 (A) Bench seat - Natural area.dwg | | |
| ASSOCIATED PLANS | | | |



BRISBANE CITY COUNCIL STANDARD DRAWING


BENCH SEAT
NATURAL AREA





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| SCALE | AS SHOWN |
| DWG No. | BSD - 10116 |
| ORIGINAL SIZE | A3 |
| REVISION | A |

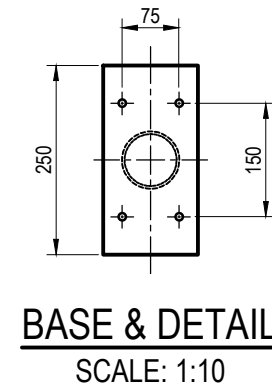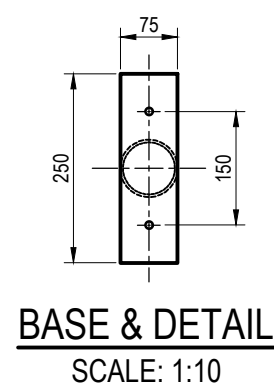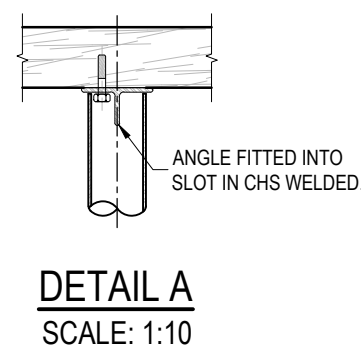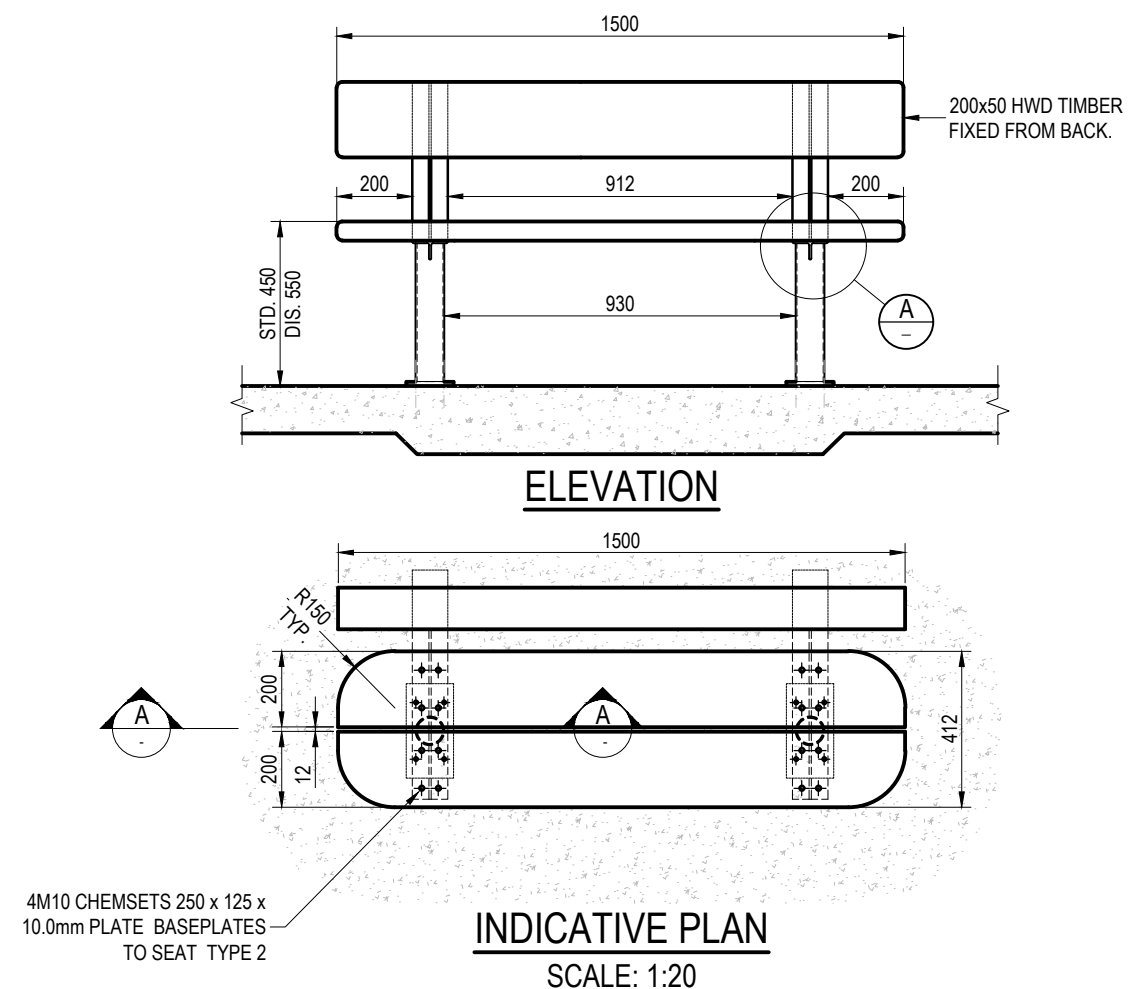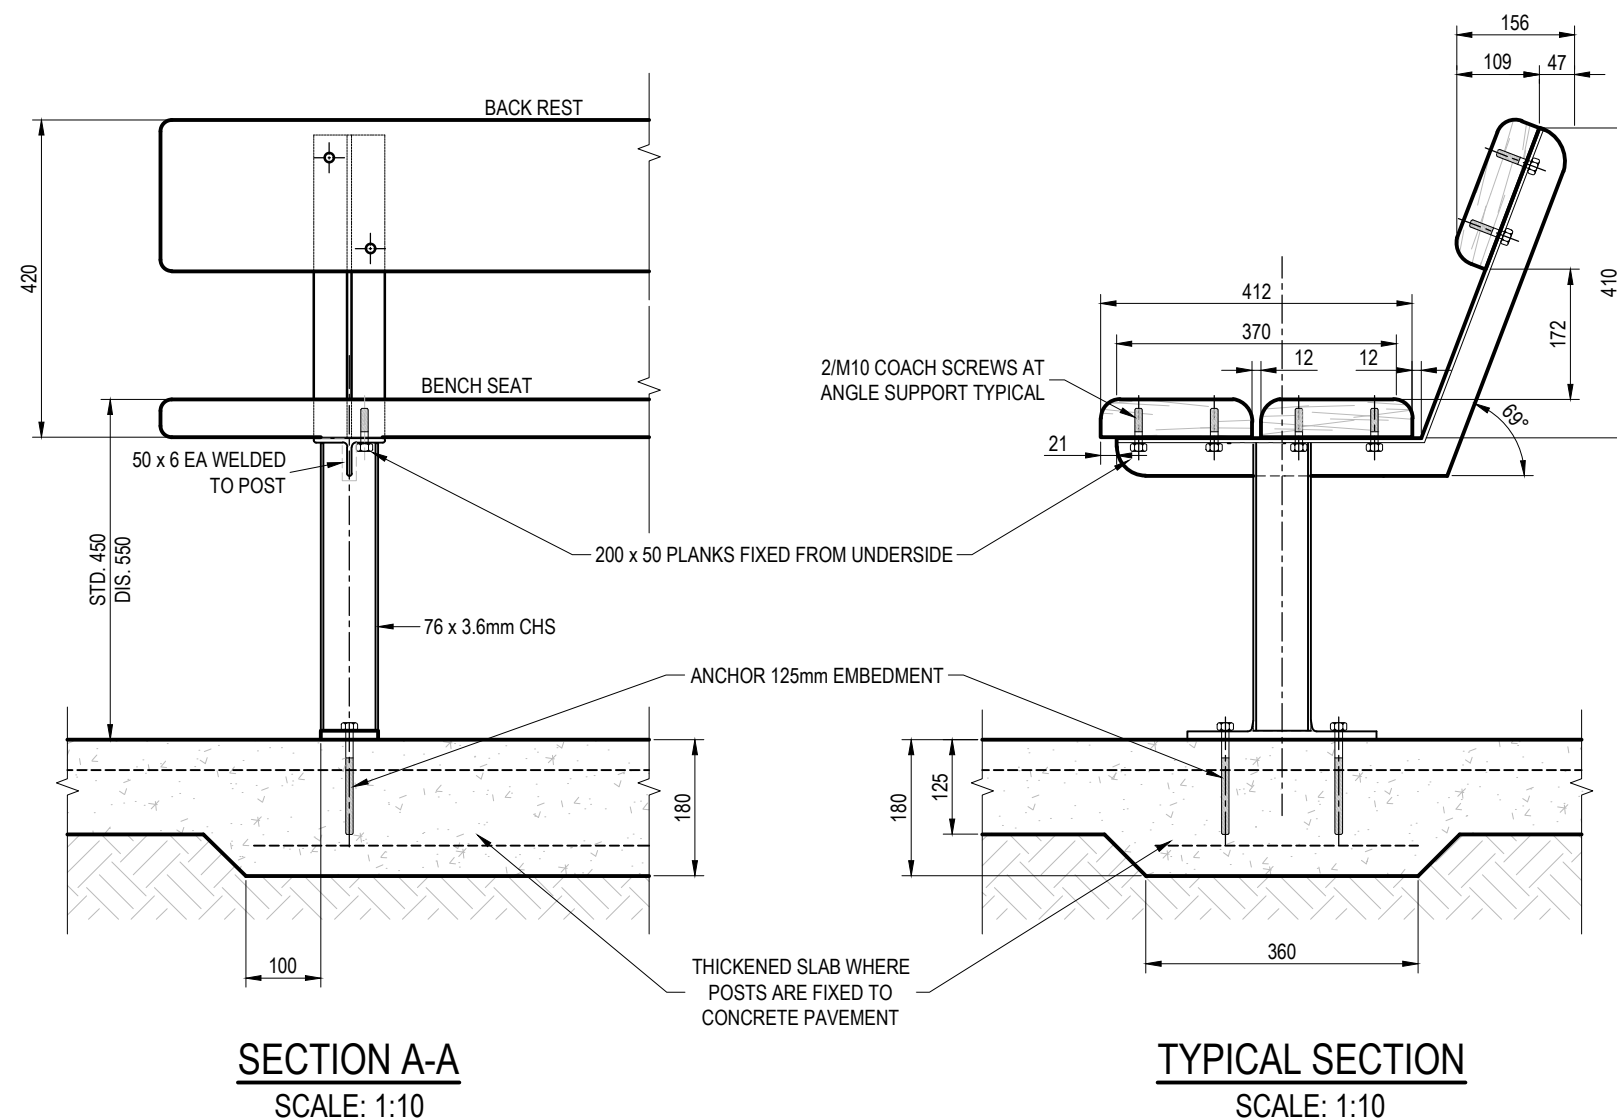

- ## NOTES



1. ENSURE THAT WORK IS IN ACCORDANCE WITH BRISBANE CITY COUNCIL ENVIRONMENTAL BEST PRACTICE NOTES.
2. SITE SETOUT TO BE VERIFIED BY SUPERINTENDENT OR LANDSCAPE ARCHITECT PRIOR TO THE COMMENCEMENT OF CONSTRUCTION WORKS.
3. VERIFY LOCATION OF ALL SERVICES AND EASEMENTS PRIOR TO THE COMMENCEMENT OF WORKS.
4. WRITTEN DIMENSIONS TAKE PRECEDENCE OVER SCALED DISTANCES.
5. VERIFY ALL DIMENSIONS ON SITE PRIOR TO CONSTRUCTION.
6. STRUCTURES HAVE BEEN DESIGNED FOR STANDARD SOIL AND TERRAIN CATEGORY CONDITIONS. TERRAIN CATEGORY = 2.5 AND MINIMUM ALLOWABLE BEARING CAPACITY = 100KPA.
7. IN EACH CASE ENGINEERING CERTIFICATION AND MODIFICATION AS NECESSARY WILL BE REQUIRED FOR PARTICULAR SOIL AND SITE CONDITIONS.
8. THE COPYRIGHT OF THIS DRAWING REMAINS THE PROPERTY OF THE BRISBANE CITY COUNCIL.


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| | | | | | <div><div>DRAWING AUTHORISED FOR PUBLICATION</div><div>Ingo Condric 2015.06.04 14:44:33+10'00'</div><div>for ASSET ENGINEERING MANAGER STRATEGIC ASSET MANAGEMENT</div><div>DESIGN APPROVED</div><div>C.Wood</div><div>SENIOR CO-ORDINATOR NATURAL ENVIRONMENT ASSET SERVICES/BRISBANE INFRASTRUCTURE</div></div> | DESIGN | CP0 - P&D | DATE | DEC '14 | <div></div> | BRISBANE CITY COUNCIL STANDARD DRAWING | | | |
| | | | | | | DRAWN | CP0 - P&D | DATE | DEC '14 | | BENCH SEAT WITH BACKREST NATURAL AREA | | SCALE AS SHOWN | |
| | | | | | | CHECKED | BI - FSG - AS | DATE | DEC '14 | | | | Dwg No. BSD-10117 | |
| B | Redundant Note Removed From Drawing (Note 9) | DEC '18 | APR '19 | APR '19 | | DRAWING FILENAME | BSD-10117 (A) Bench seat with backrest - Natural area.dwg | | | | ORIGINAL SIZE A3 | REVISION B | | |
| A | ORIGINAL ISSUE | DEC '14 | DEC '14 | DEC '14 | | ASSOCIATED PLANS | | | | | | | | |
| ISSUE | AMENDMENT | DRAWN DATE | CHK'D DATE | APPR'D DATE | | | | | | | | | | |

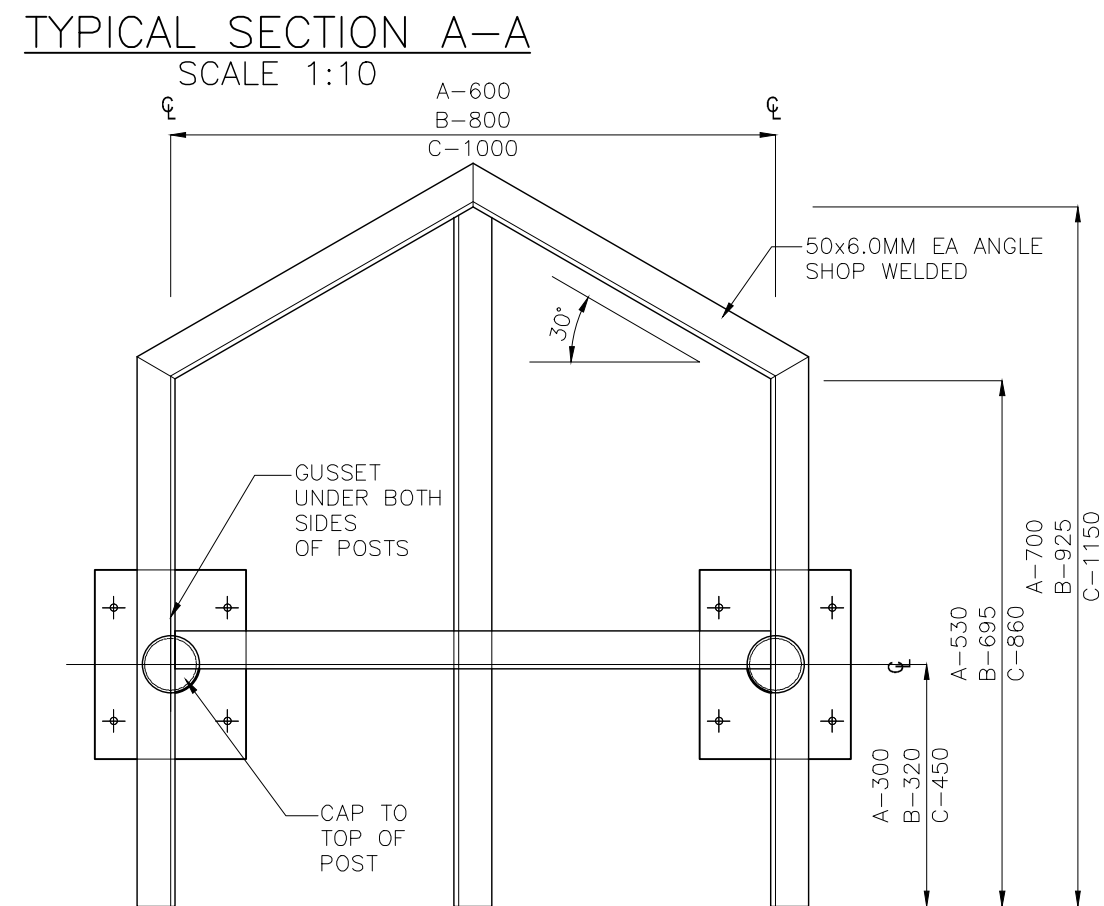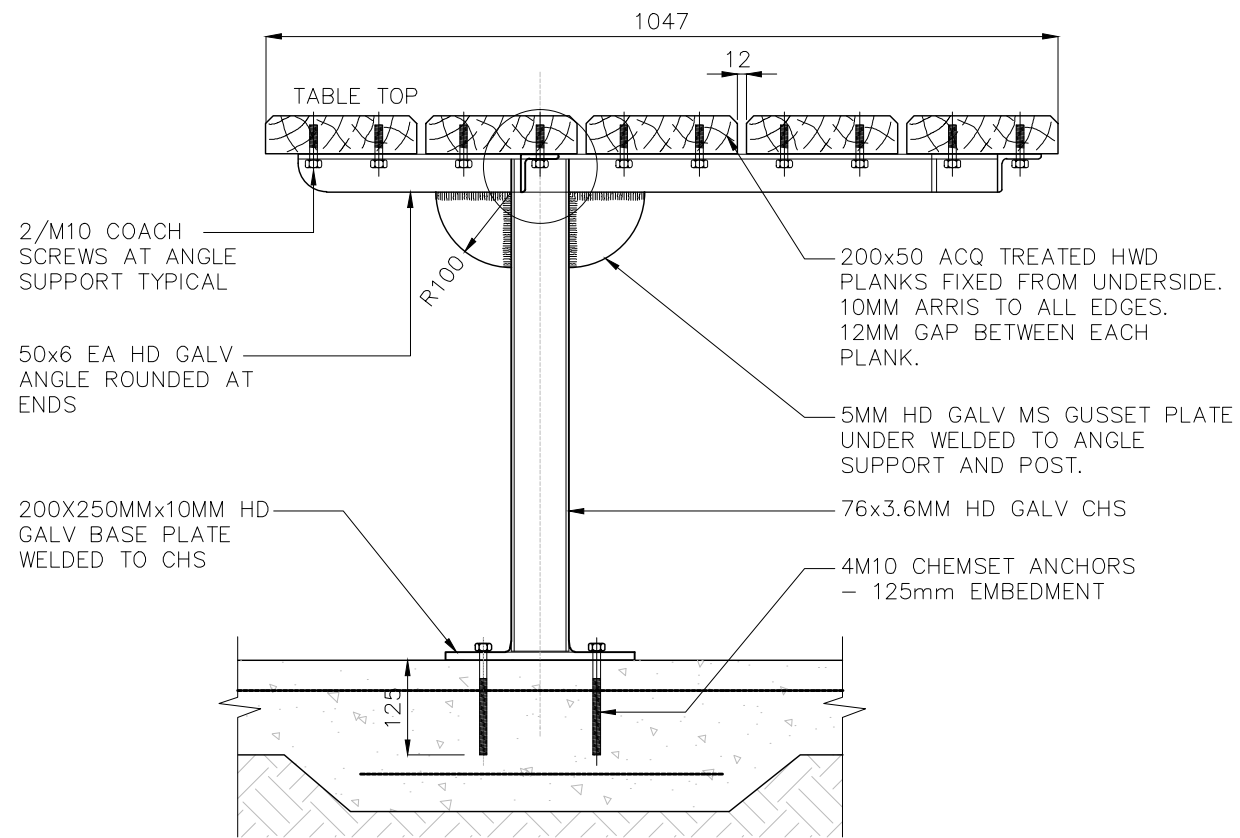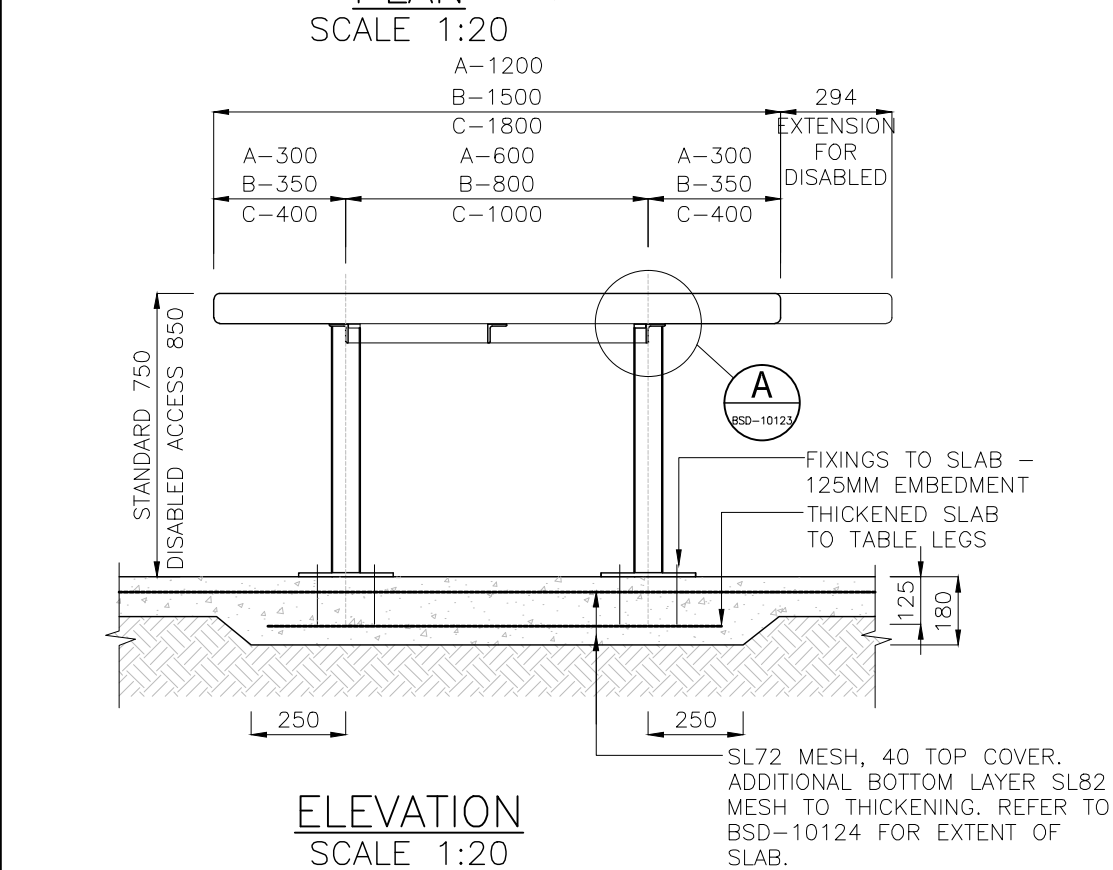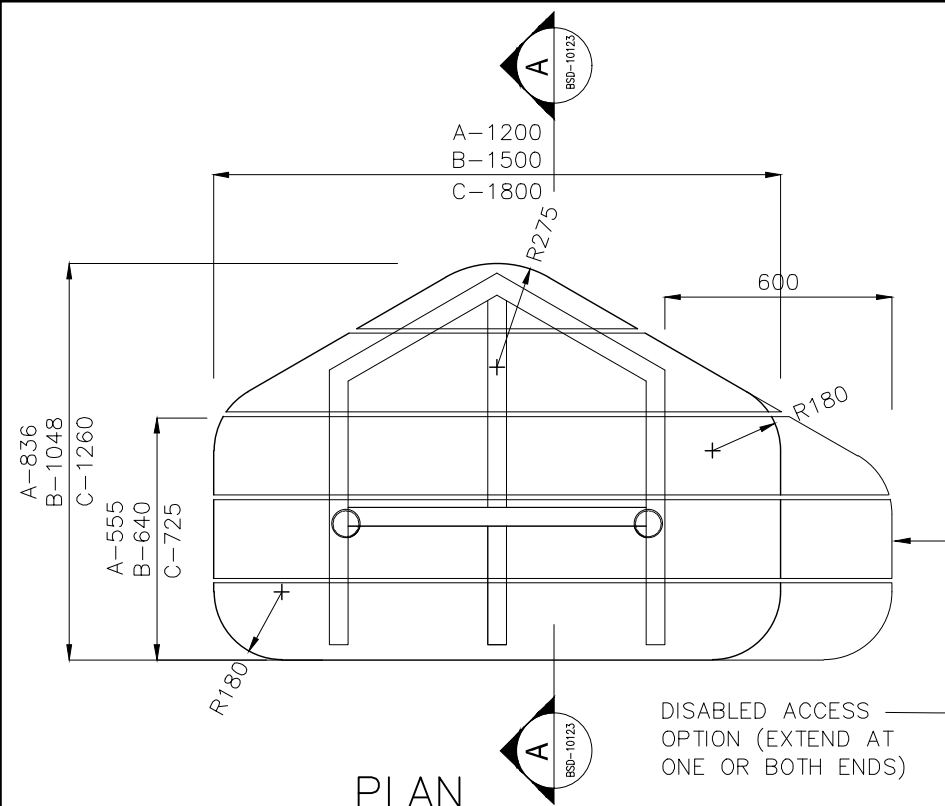


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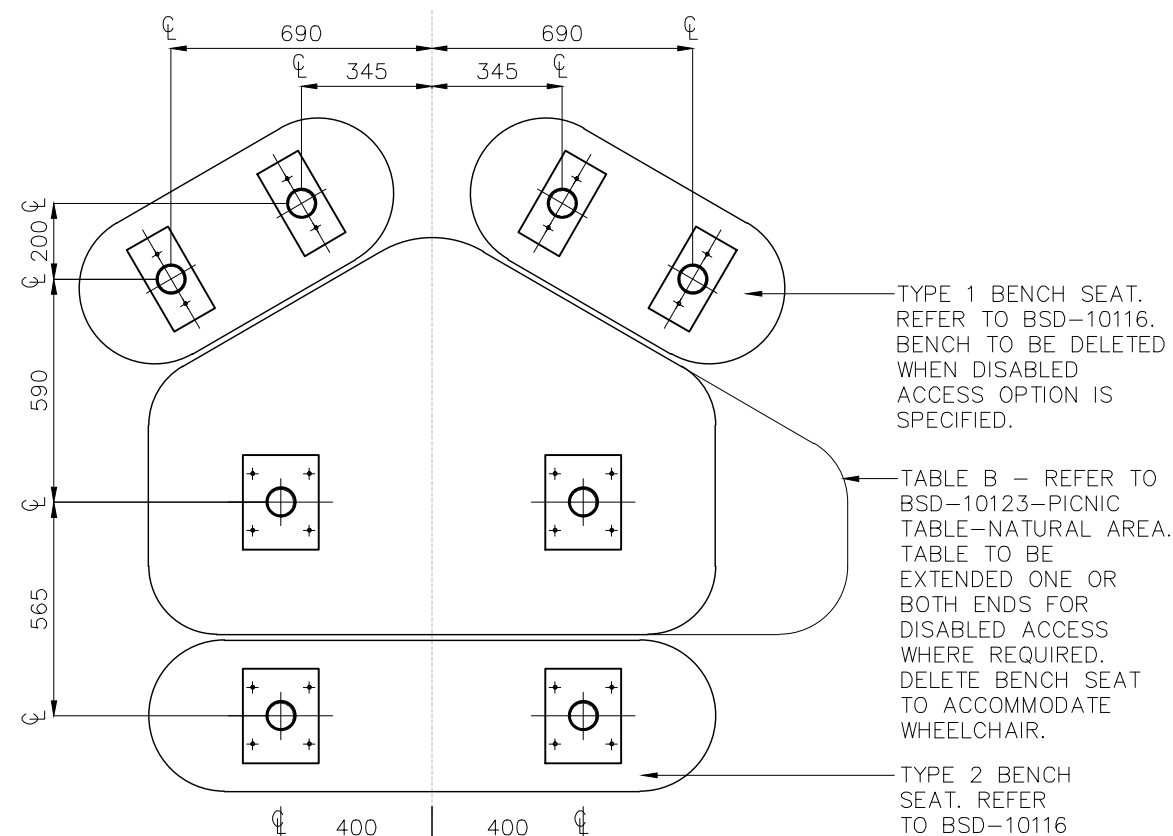
- SITE SETOUT TO BE VERIFIED BY SUPERINTENDENT OR LANDSCAPE ARCHITECT PRIOR TO THE COMMENCEMENT OF CONSTRUCTION WORKS.
- VERIFY LOCATION OF ALL SERVICES AND EASEMENTS PRIOR TO THE COMMENCEMENT OF WORKS.
- ALL FOOTINGS ARE TO BE FOUNDED IN THE NATURAL UNDISTURBED SOIL PROFILE WITH A MINIMUM ALLOWABLE SOIL BEARING CAPACITY OF 100kPa UNLESS NOTED OTHERWISE. IF SITE CONDITION IS DIFFERENT, CONSULT A STRUCTURAL ENGINEER
- ALL DIMENSIONS ARE IN MILLIMETRES UNLESS SHOWN OTHERWISE U.N.O
- DIMENSIONS SHALL NOT BE OBTAINED BY SCALING OFF DRAWINGS
- REFER TO BSD-10124 FOR SETOUT OF PICNIC TABLES IN PICNIC SETTINGS.
- ALL METALWORK TO BE HD GALVANISED AFTER FABRICATION UNLESS OTHERWISE NOTED
- ALL WELDS TO BE CONTINUOUS, GROUND OFF SMOOTH AND FLUSH
- ANGLES TO BE 50X50X6 MS ROUNDED AT EDGES

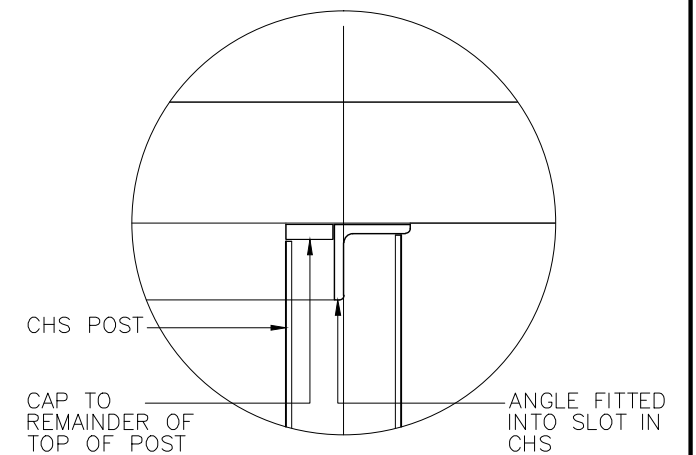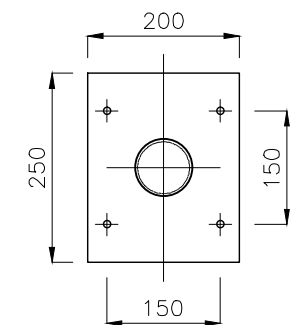


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| | | | | | DRAWING AUTHORISED FOR PUBLICATION | | | |  | BRISBANE CITY COUNCIL STANDARD DRAWING | | | | | |
| | | | | | Inga Condric 2015.06.04 14:45:14+10'00' for ASSET ENGINEERING MANAGER STRATEGIC ASSET MANAGEMENT DESIGN APPROVED | | | | | <div>PICNIC TABLE NATURAL AREA</div> | | | SCALE AS SHOWN | | |
| | | | | | C. Wood SENIOR CO-ORDINATOR NATURAL ENVIRONMENT ASSET SERVICES/BRISBANE INFRASTRUCTURE | | | | | | | | DWG No. BSD – 10123 | | |
| | | | | | | | | | | | | | ORIGINAL SIZE A3 | | |
| A | ORIGINAL ISSUE | | | | DEC '14 | DEC '14 | DEC '14 | | | | | | REVISION A | | |
| ISSUE | AMENDMENT | | | | DRAWN DATE | CHK'D DATE | APPR'D DATE | | | | | | | | |

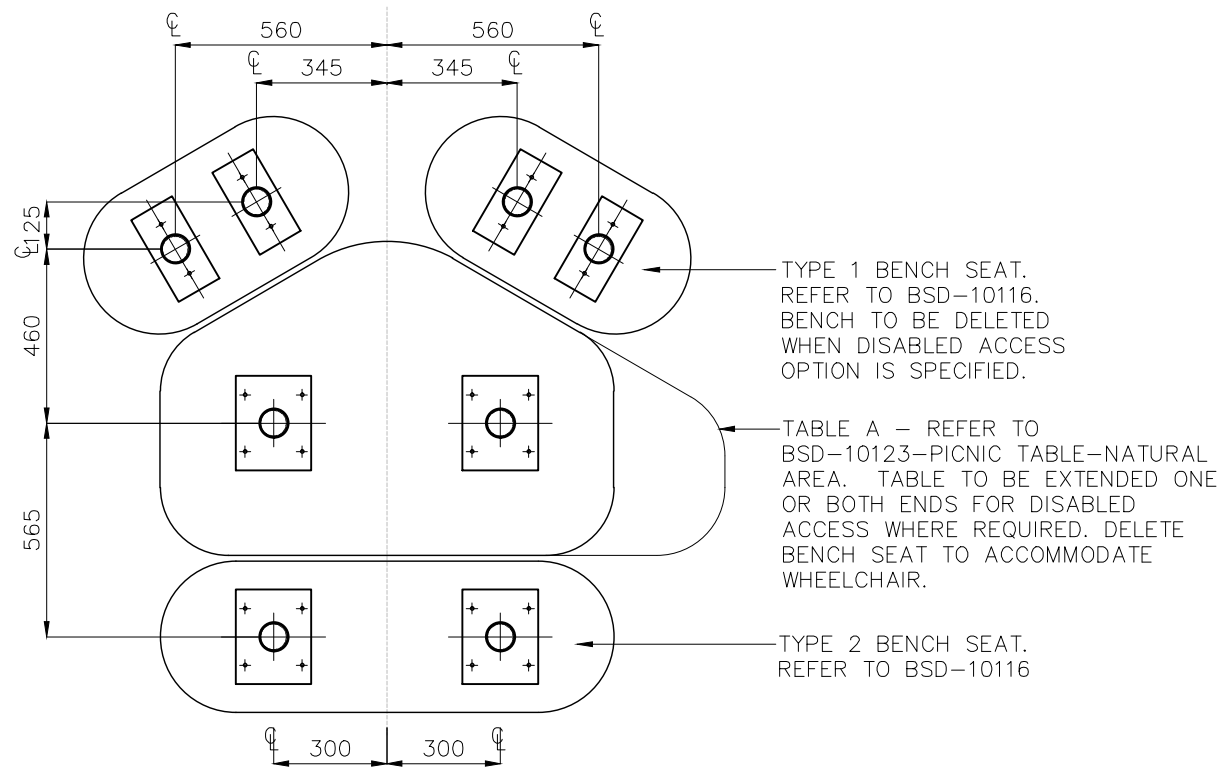


TYPE A SETTING - PLAN
SCALE 1:20



TYPE B SETTING - PLAN
SCALE 1:20

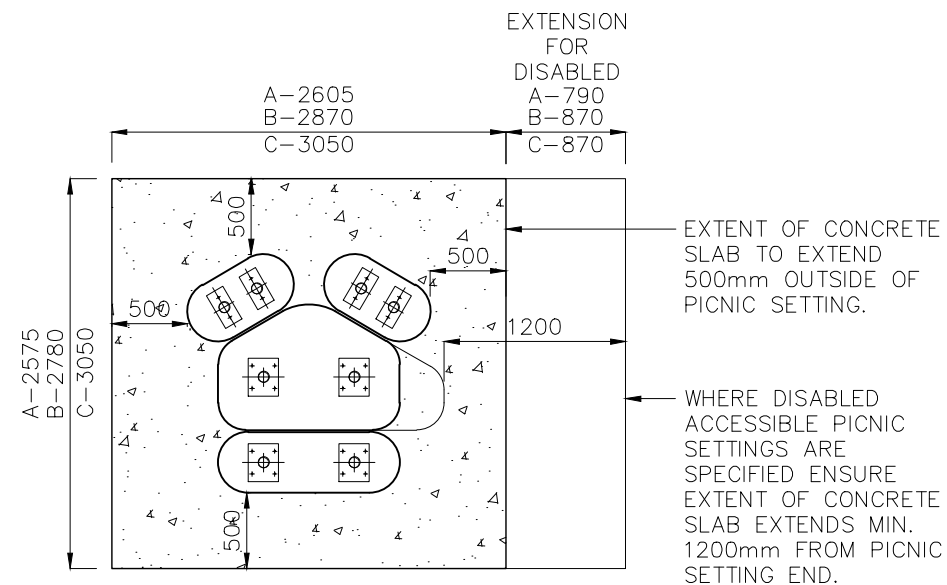

PICNIC SETTING ON
CONCRETE SLAB - PLAN
SCALE 1:50

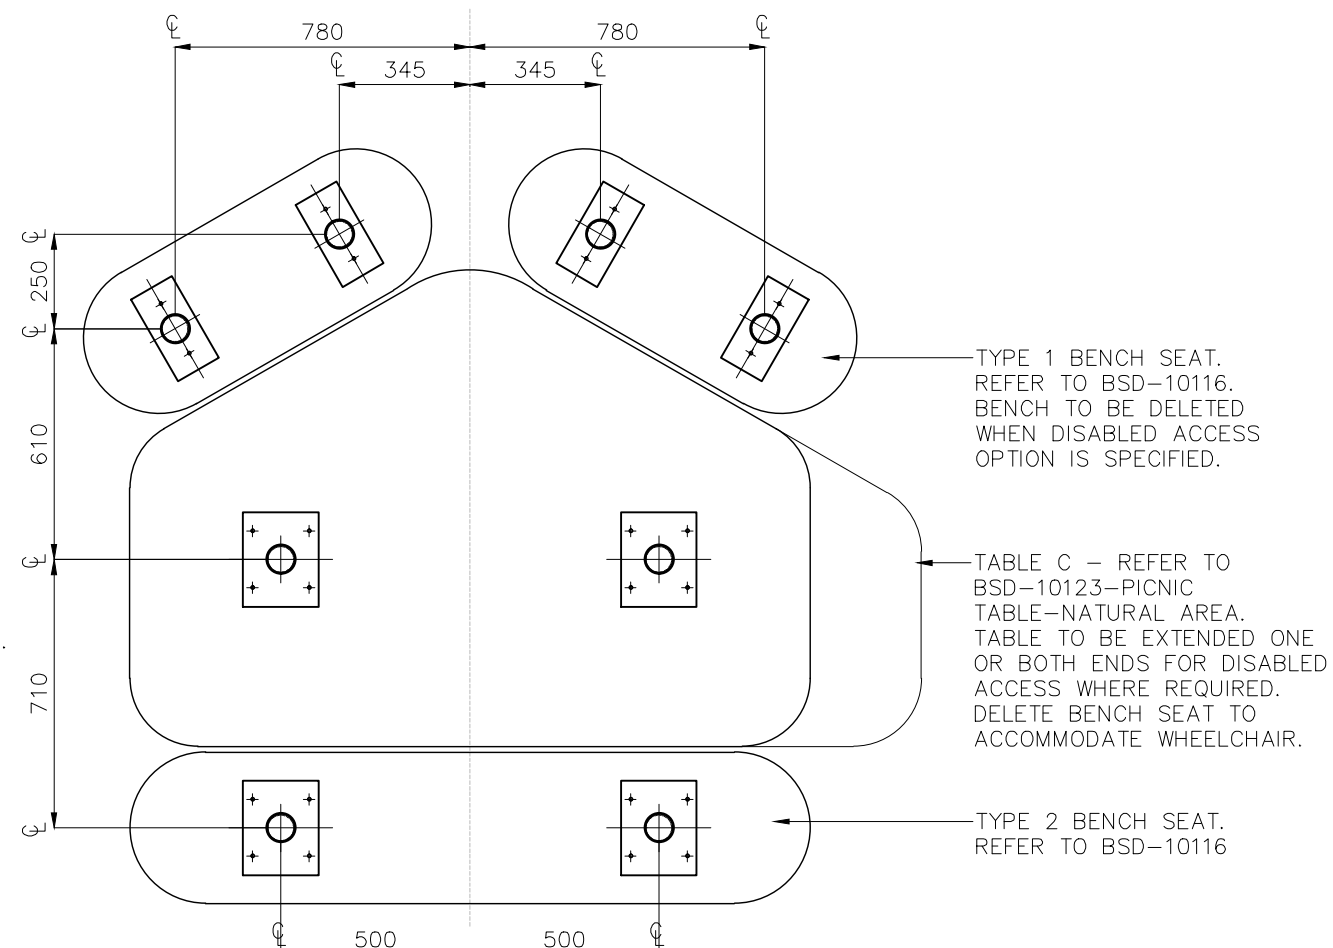

TYPE C SETTING - PLAN
SCALE 1:20


NOTES

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- ALL DIMENSIONS ARE IN MILLIMETRES UNLESS SHOWN OTHERWISE U.N.O
- DIMENSIONS SHALL NOT BE OBTAINED BY SCALING OFF DRAWINGS
- REFER TO BSD-10116 FOR BENCH SEAT DETAILS AND BSD-10123 FOR PICNIC TABLE DETAILS.
- ALL METALWORK TO BE HD GALVANISED AFTER FABRICATION UNLESS OTHERWISE NOTED
- ALL WELDS TO BE CONTINUOUS, GROUND OFF SMOOTH AND FLUSH
- ANGLES TO BE 50X50X6 MS ROUNDED AT EDGES


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| A | ORIGINAL ISSUE | DEC '14 | DEC '14 | DEC '14 |
| ISSUE | AMENDMENT | DRAWN DATE | CHK'D DATE | APPR'D DATE |

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| for ASSET ENGINEERING MANAGER STRATEGIC ASSET MANAGEMENT |
| DESIGN APPROVED |
| C.Wood |
| SENIOR CO-ORDINATOR NATURAL ENVIRONMENT ASSET SERVICES/BRISBANE INFRASTRUCTURE |


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| DRAWN | CP0 - P&D | DATE | DEC '14 |
| CHECKED | BI - FSG - AS | DATE | DEC '14 |
| DRAWING FILENAME | BSD-10124.dwg | | |
| ASSOCIATED PLANS | | | |

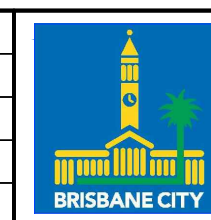


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|--|---------------|
| BRISBANE CITY COUNCIL STANDARD DRAWING | |
| PICNIC TABLE NATURAL AREA SETOUT DETAILS | |
| SCALE AS SHOWN | |
| DWG No. BSD - 10124 | |
| ORIGINAL SIZE A3 | REVISION A |

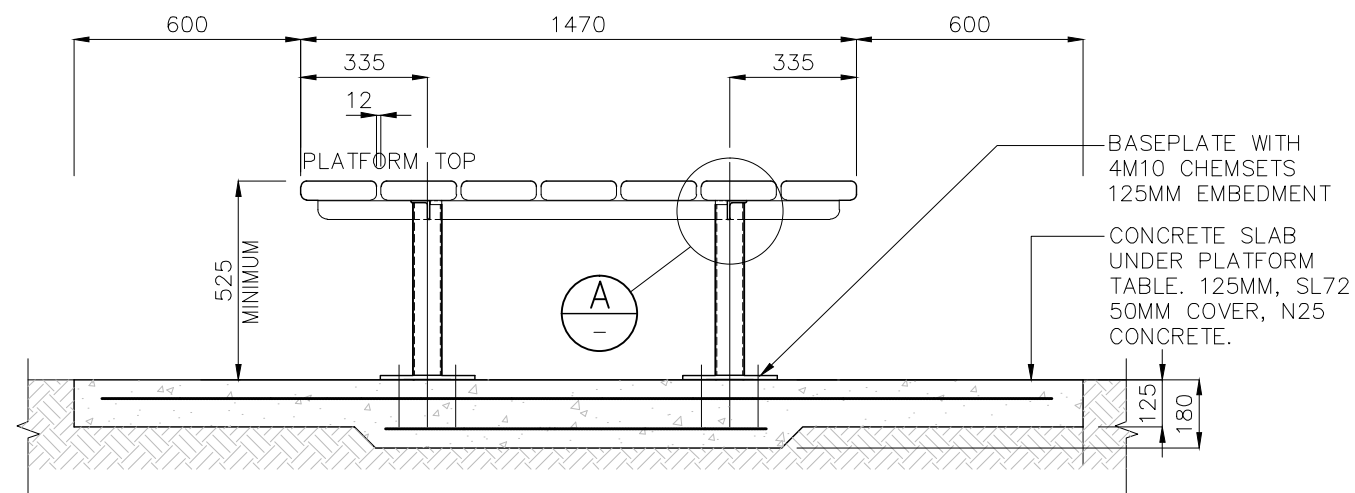

ELEVATION
SCALE 1:20
2670

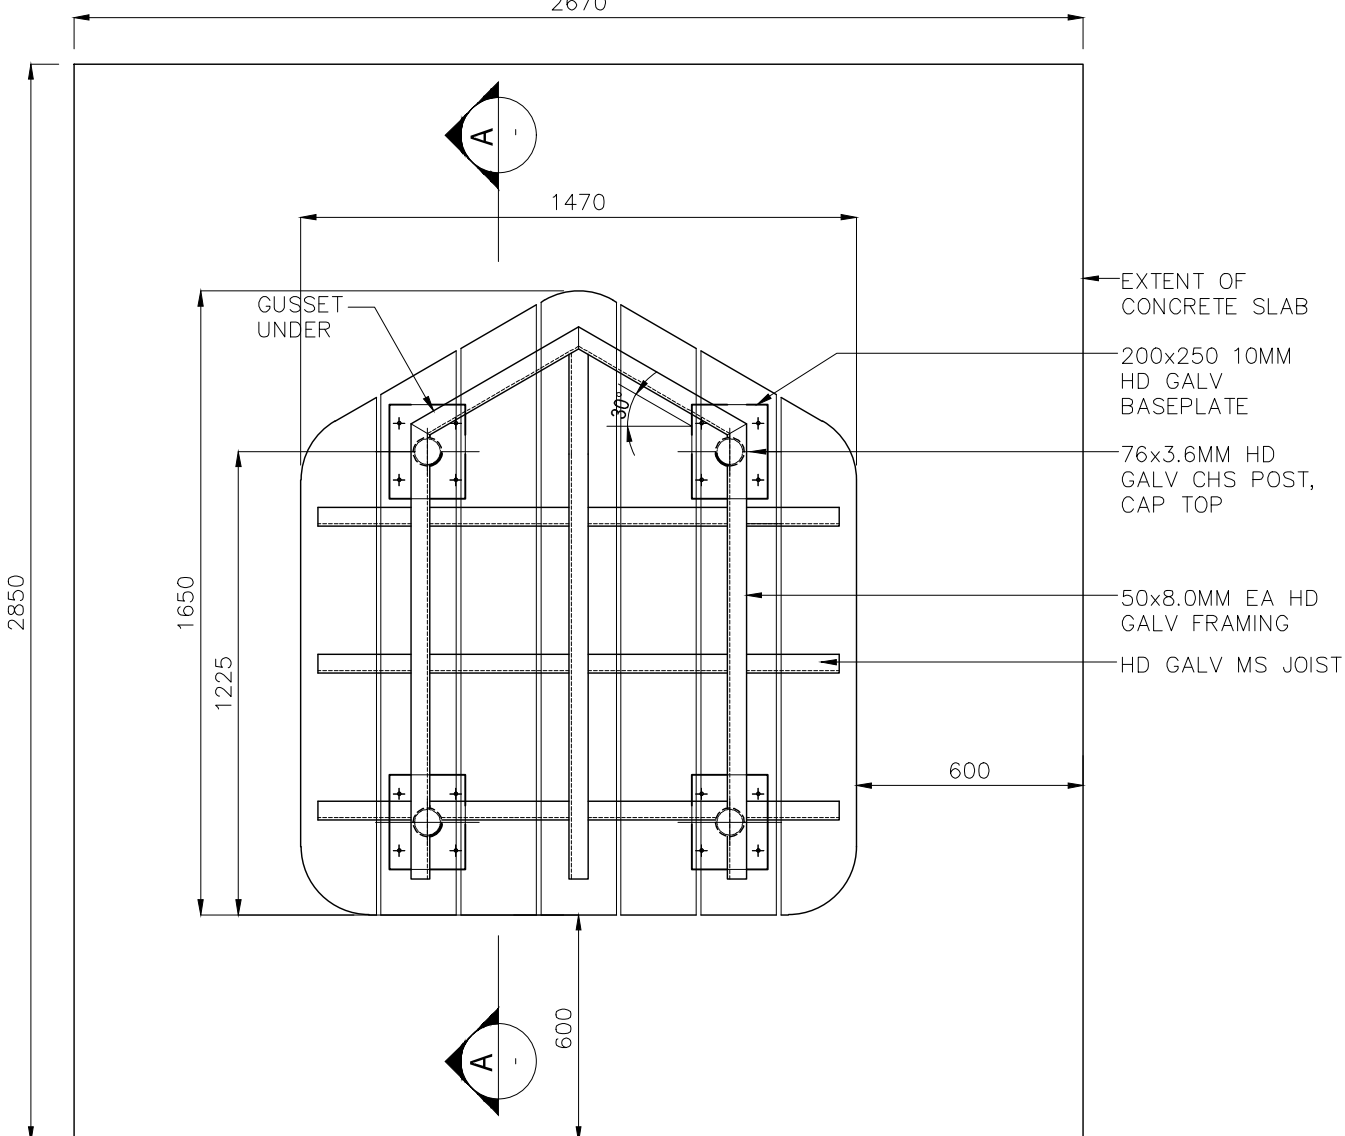


PLAN
SCALE 1:20

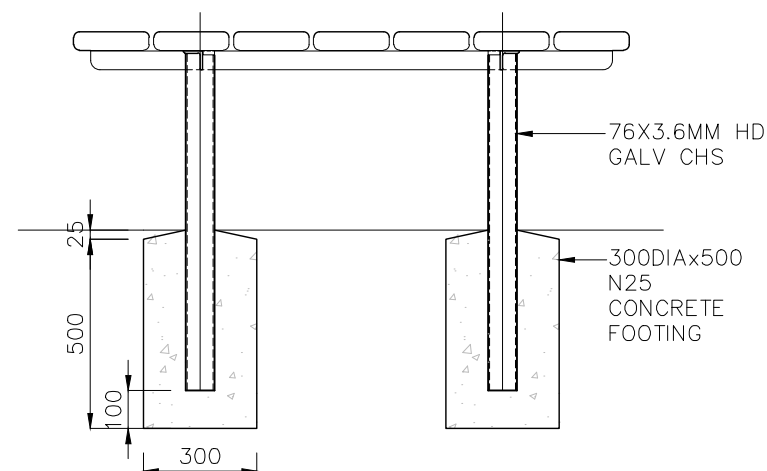


NOTE: ALTERNATIVE FOOTING TO BE USED WHERE PLATFORM TABLE IS TO BE INSTALLED WITHOUT A CONCRETE SLAB. THIS IS TO BE USED ONLY IN REMOTE AREAS WHERE CONSTRUCTION ACCESS IS LIMITED.


ALTERNATIVE FOOTING DETAIL
SCALE 1:20

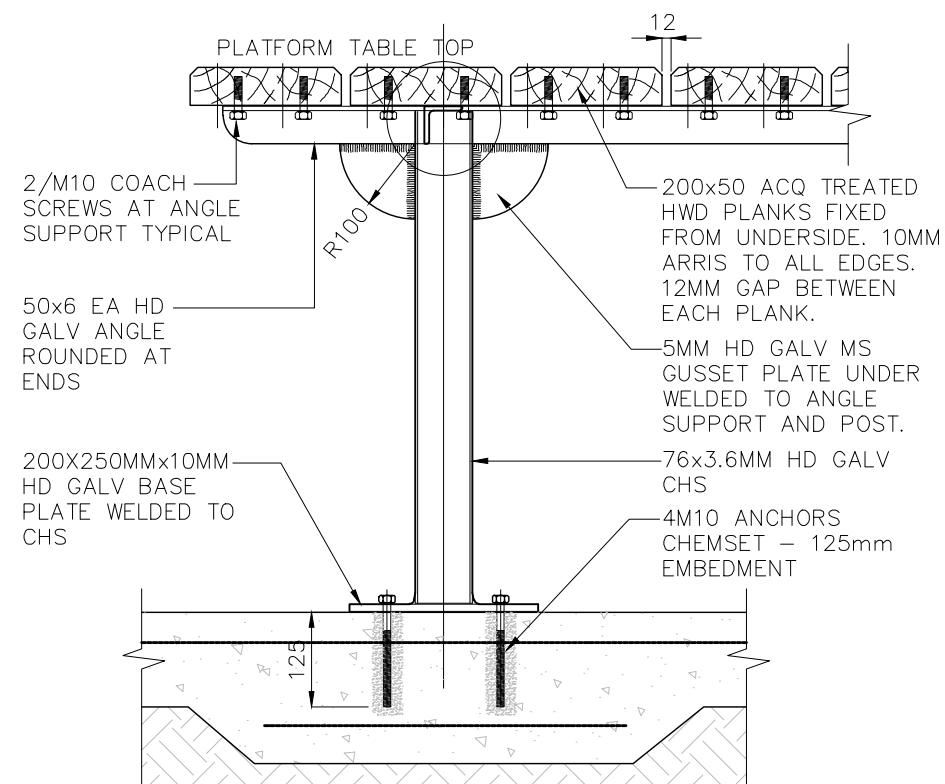

SECTION A-A
SCALE 1:20

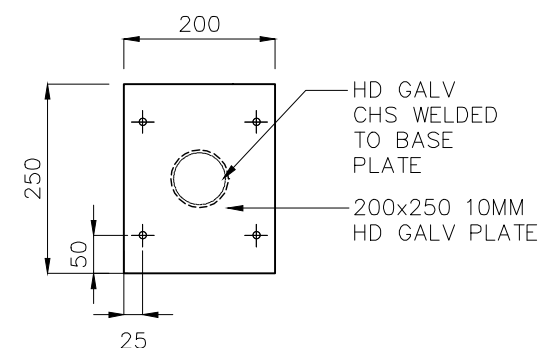


BASE PLATE DETAIL
SCALE 1:10

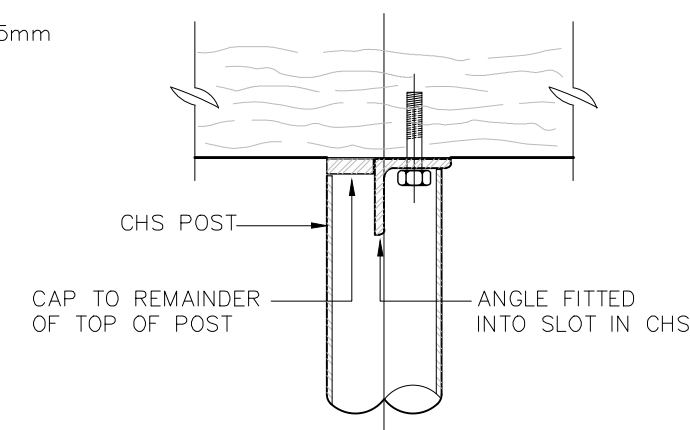

DETAIL A
SCALE 1:5

NOTES

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- ALL WELDS TO BE CONTINUOUS, GROUND OFF SMOOTH AND FLUSH
- ANGLES TO BE 50X50X6 MS ROUNDED AT EDGES

| | | | | | | | | | | | | | | |
|-------|----------------|---------------|---------------|----------------|--|---------------------|---|------|---------|---|--|--|-------------------------------|---------------|
| | | | | | DRAWING AUTHORISED FOR PUBLICATION Inga Condric 2015.06.04 14:46:32+10'00' for ASSET ENGINEERING MANAGER STRATEGIC ASSET MANAGEMENT DESIGN APPROVED C. Wood SENIOR CO-ORDINATOR NATURAL ENVIRONMENT ASSET SERVICES/BRISBANE INFRASTRUCTURE | DESIGN | CP0 - P&D | DATE | DEC '14 |  | BRISBANE CITY COUNCIL STANDARD DRAWING | | | |
| | | | | | | DRAWN | CP0 - P&D | DATE | DEC '14 | | PLATFORM TABLE NATURAL AREA | | SCALE AS SHOWN | |
| | | | | | | CHECKED | BI - FSG - AS | DATE | DEC '14 | | | | DWG No. BSD - 10126 | |
| | | | | | | DRAWING FILENAME | BSD-10126 (A) Platform table - Natural area.dwg | | | | | | ORIGINAL SIZE A3 | REVISION A |
| A | ORIGINAL ISSUE | DEC '14 | DEC '14 | DEC '14 | | ASSOCIATED PLANS | | | | | | | | |
| ISSUE | AMENDMENT | DRAWN DATE | CHK'D DATE | APPR'D DATE | | | | | | | | | | |

GENERAL NOTES:

| | |
|-----|--|
| G1 | THE BUILDER SHALL BE RESPONSIBLE FOR MAINTAINING STABILITY OF THE STRUCTURE UNTIL COMPLETION OF CONSTRUCTION AND SHALL ENSURE THAT NO PART OF THE STRUCTURE IS OVERSTRESSED. |
| G2 | THE BUILDER SHALL CHECK ALL DIMENSIONS AND ALL EXISTING CONDITIONS BEFORE COMMENCING CONSTRUCTION. |
| G3 | ANY DAMAGE CAUSED BY THE CONTRACTOR SHALL BE MADE GOOD AT THEIR OWN COST. |
| G4 | ALL MATERIALS AND WORKMANSHIP SHALL BE IN ACCORDANCE WITH THE CURRENT EDITIONS OF THE FOLLOWING AUSTRALIAN STANDARDS, EXCEPT WHERE VARIED BY THE SPECIFICATIONS AND/OR DRAWINGS: – AS 1684.2(2010) RESIDENTIAL TIMBER FRAMED CONSTRUCTION AS 1720.1(2010) TIMBER STRUCTURES AS 2870(2011) RESIDENTIAL SLABS AND FOOTINGS AS 3600 CONCRETE STRUCTURES AS 3798 GUIDELINES ON EARTHWORKS FOR COMMERCIAL AND RESIDENTIAL DEVELOPMENTS AS 4100 STEEL STRUCTURES |
| G5 | DIMENSIONS SHALL NOT BE OBTAINED BY SCALING THE STRUCTURAL DRAWINGS. |
| G6 | ALL DIMENSIONS ARE IN MILLIMETRES UNLESS NOTED OTHERWISE U.N.O. |
| G7 | U.N.O. DENOTES UNLESS NOTED OTHERWISE. |
| G8 | THE CONTRACTOR SHALL VISIT THE SITE PRIOR TO TENDERING TO FAMILIARISE THEMSELVES WITH ACCESS SITE CONDITIONS |
| G9 | THE CONTRACTOR MAY OFFER FOR CONSIDERATION ALTERNATIVE PROVEN EQUAL PRODUCTS TO THOSE INDICATED. ALTERNATIVE PRODUCTS ARE NOT TO ADVERSELY AFFECT THE PROJECT AND CANNOT BE SUBSTITUTED WITHOUT PRIOR APPROVAL. |
| G10 | EXISTING SERVICES TO BE LOCATED BEFORE CONSTRUCTION COMMENCES. |
| G11 | THE DETAILS OF HIP ROOF SHELTERS INCLUDED IN DRAWING SHEETS 1 TO 7. |
| G12 | CONSULT BCC ARCHITECTS FOR COLOUR SCHEME OF THE STRUCTURE. |
| G13 | LIGHTNING PROTECTION AS PER BSD–10133. |

DESIGN CRITERIA:

| | |
|---|--|
| WIND LOADS | : REGION B TERRAIN CATEGORY 1.5 |
| ULTIMATE WIND SPEED | = 54.0 m/s |
| SHELTER IS DESIGNED FOR THE CONDITION | "EMPTY UNDER" ACCORDING TO AS 1170.2 (2011) |
| DESIGN LIFE | : 50 YEARS WITH ROUTINE MAINTENANCE |
| LIVE LOADS: | : FLOOR = 5.0 kPa. ROOF = 0.25 kPa / 1.4 kN. |
| STRUCTURE IS DESIGNED TO REMAIN OPEN – NO SCREENS | (IMPERMEABLE OR PERMEABLE BARRIERS) TO BE INSTALLED. |
| TERRAIN CATEGORY 1.5 CORRESPONDS TO AN ENVIRONMENT WITH OPEN WATER SURFACES | SUBJECTED TO SHOALING WAVES AT SERVICEABILITY AND ULTIMATE WIND SPEEDS IN ALL WIND REGIONS |

FOUNDATIONS AND SLAB ON GROUND:

| | |
|----|---|
| F1 | ALL FOOTINGS ARE TO BE FOUNDED IN THE NATURAL UNDISTURBED SOIL PROFILE WITH A MINIMUM ALLOWABLE SOIL BEARING CAPACITY OF 100kPa UNLESS NOTED OTHERWISE. IF SITE CONDITION IS DIFFERENT, CONSULT A STRUCTURAL ENGINEER |
| F2 | SOIL TEST IS REQUIRED TO CONFIRM BEARING CAPACITY AND SITE CLASSIFICATION TO AS 2870. |
| F3 | FOUNDATIONS ARE TO BE CHECKED AND CERTIFIED BY A REGISTERED PROFESSIONAL GEOTECHNICAL ENGINEER, QUEENSLAND (RPEQ). |
| F4 | COMPACT AND PREPARE THE BASE TO PROVIDE A SOUND PLATFORM AND ANY ORGANIC, SOFT OR LOOSE MATERIALS REMOVED AND REPLACED WITH COMPACTED FILL – BCC SPECIFICATION S300 QUARRY PRODUCT CLASS I MATERIAL. |
| F5 | THE BOTTOMS OF ALL FOOTINGS ARE TO BE CLEANED OF ALL LOOSE MATERIAL AND WATER PRIOR TO POURING CONCRETE. |
| F6 | FOR CONTROL JOINT LOCATIONS, REFER TO DRAWINGS. |
| F7 | SLABS ON GRADE SHALL BE UNDERLAIN WITH CONTINUOUS LAYER OF 200 MICRON (0.2mm) THICK POLYETHYLENE DAMPPROOF MEMBRANE AS PER AS 2870, LAPPED AND TAPED TO MANUFACTURER’S SPECIFICATION. |

EARTHWORKS:

| | |
|----|--|
| E1 | STRIP ALL HUMUS MATERIAL FROM THE AREA OF THE BUILDING IMPRINT AND 1000 BEYOND. |
| E2 | PROOF ROLL THE AREAS TO BE CONCRETED AND PAVED. REMOVE ANY WEAK MATERIAL. |
| E3 | COMPACTED FILL SHALL BE COMPACTED IN LAYERS NOT EXCEEDING 150mm LOOSE DEPTH TO 98% MAXIMUM DRY DENSITY IN ACCORDANCE WITH AS1289. 5.1.1 (STANDARD COMPACTION). CARRY OUT DENSITY TESTS AT A RATE OF 2 PER LEVEL OF FILL. EVERY TEST MUST PASS. |

TIMBER NOTES:

| | |
|----|--|
| T1 | ALL WORKMANSHIP AND MATERIAL SHALL BE IN ACCORDANCE WITH AS 1720 AND AS 1684. |
| T2 | TIMBER GRADES SHALL BE AS SHOWN ON THE DRAWINGS. ALL TIMBER TO BE SEASONED OR KILN DRIED GRADE MGP12 MINIMUM U.N.O WITH NATURAL DURABILITY CLASS 4 (ABOVE GROUND) OR BETTER. |
| T3 | JOIST HANGERS ARE TO HAVE A MINIMUM OF SIX (6) No. 3.15mm DIA. x 35mm LONG NAILS PER LEG/END. |
| T4 | ALL FASTENERS SHALL BE HOT DIP GALVANISED. BOLTS TO BE METRIC HEX–HEAD M16 MINIMUM WITH WASHERS U.N.O. CLEAT PLATES TO BE 10mm THICK U.N.O. IN MARINE ENVIRONMENT, ALL FASTENERS, CLEATS, STEEL MEMBERS, NAILS AND BOLTS SHALL BE STAINLESS STEEL GR. 316 U.N.O. THE MARINE ENVIRONMENT EXTENDS 1km FROM FORESHORE. |
| T5 | TIMBER JOINT GROUP JD4 OR BETTER. |
| T6 | ALL TIMBER SHALL BE FULLY DRESSED AND ALL EDGES, ENDS AND CORNERS TO BE 6mm DRESSED. |
| T7 | PROTECT ENDS OF EXPOSED MEMBERS. USE A HIGH QUALITY EXTERIOR PAINT FINISH. |
| T8 | ALL TIMBER FRAMING SHALL BE NATURALLY TERMITE RESISTANT OR TREATED USING LOSP OR ACQ CHEMICALS TO A HAZARD RESISTANCE LEVEL H3 IN ACCORDANCE WITH AS 1684.2 APPENDIX B. |
| T9 | ALL TIMBER TO BE STAINED OR PAINTED PRIOR TO FIXING INTO FINAL POSITION. REFER TO PROJECT SPECIFICATION FOR EACH PROJECT. |

CONCRETE NOTES:

C1

ALL WORKMANSHIP AND MATERIAL SHALL BE IN ACCORDANCE WITH AS 3600.

C2

ALL CONCRETE SHALL BE PREMIXED BY AN APPROVED SUPPLIER.

C3

ALL CEMENT SHALL BE TYPE GP OR GB.

C4

CONCRETE SPECIFICATION: NOMINAL AGGREGATE SIZE TO BE 20mm, SLUMP TO BE NOT GREATER THAN 80mm.

C5

CONCRETE STRENGTH AND CLEAR CONCRETE COVER TO REINFORCEMENT SHALL BE IN ACCORDANCE WITH THE FOLLOWING TABLE

U.N.O.

ELEMENT:

F'C (MPa)

REINFORCEMENT COVER

PIERS

32

75 MIN.

SLAB

32

CENTRALLY PLACED

C6

ALL LAPS IN REINFORCEMENT SHALL BE AS SHOWN IN THE TABLE BELOW UNLESS NOTED OTHERWISE.

BAR

LAP LENGTH (mm)

N12

500

N16

650

MESH

350

C7

REINFORCEMENT SYMBOLS:

R

STRUCTURAL PLAIN ROUND GRADE 250R TO AS 4671.

N

DEFORMED BAR GRADE D500N TO AS 4671.

SL

HARD DRAWN STEEL REINFORCING FABRIC GRADE D500L TO AS 4671.

C8

SIZES OF CONCRETE ELEMENTS DO NOT INCLUDE THICKNESS OF APPLIED FINISHES.

C9

NO HOLES, CHASES OR EMBEDMENT OF PIPES OTHER THAN THOSE SHOWN ON THE STRUCTURAL DRAWINGS SHALL BE MADE IN CONCRETE MEMBERS WITHOUT PRIOR APPROVAL BY THE SUPERINTENDENT.

C10

ALL CONCRETE SHALL BE COMPACTED USING A MECHANICAL VIBRATION PROCESS.

C11


ALL REINFORCEMENT SHALL BE SECURELY SUPPORTED IN ITS CORRECT POSITION DURING CONCRETING BY APPROVED BAR CHAIRS, SPACERS OR SUPPORT BARS.

C12

CONSTRUCTION JOINTS SHALL BE PROPERLY FORMED AND USED ONLY WHERE SHOWN OR SPECIFICALLY APPROVED BY THE SUPERINTENDENT.

INSPECTION AND CERTIFICATION NOTES:

| | |
|----|---|
| A1 | THE CONTRACTOR’S ENGINEER (RPEQ) SHALL UNDERTAKE INSPECTIONS DURING CONSTRUCTION TO ENSURE ALL CONSTRUCTION WORKS ARE IN ACCORDANCE WITH THE MOST CURRENT ISSUE OF THE STRUCTURAL DRAWINGS AND THE CONTRACT DOCUMENT. THE RPEQ SHALL CERTIFY ALL CONSTRUCTION WORK (FORM 16). ANY ALTERNATIVE TECHNIQUE USED IN CONSTRUCTION SHALL BE FOLLOWED BY A DESIGN CERTIFICATE (FORM 15) BY THE CONTRACTOR’S PROFESSIONAL ENGINEER (RPEQ) |
|----|---|

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| | | | | | | | | | | DESIGN Original signed by : L. Mendis RPEQ: 8950 – 2014.11.26 | | | | | | | | | | DESIGN CHECK Original signed by : D. Bateup RPEQ: 13095 – 2014.11.26 | | | | | | | | | | AUTHORISED FOR ISSUE Original signed by : B. Balakumar RPEQ: 3963 – 2014.11.27 | |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| B NOTE G13 ADDED – LIGHTNING PROTECTION | | | | | | | | | | JUNE '15 JUNE '15 JUNE '15 | |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HIP ROOF SHELTERS SCHEDULE

| SHELTER TYPE | DIMENSIONS | | | | | | POST HEIGHT | FASCIA | No. of bridging equally spaced along fascia/purlin length | | | | RIDGE 2/170x45 | APEX Connector | PURLINS | | HIP RAFTER | POST C1 | | ANNEX | | | POST C2 | |
|---|------------|------|------|------|------|------|-------------|--|---|---------------|-------------|-------------|----------------|------------------------------------|-----------------------------------|-------------------------|---------------------------|------------|----------------|----------------|------------------------------|---------------------------|----------|----------------------|
| | A(m) | B(m) | C(m) | D(m) | E(m) | F(m) | H(m) | Size in timber stress grade MGP12 G(mm) | | | | | Spacing | Size in timber stress grade MGP12* | Size in timber stress grade MGP12 | Hot dip galv. grade 350 | Stainless steel grade 316 | Ground pad | Rafter spacing | Length of beam | Hot dip galvanised grade 350 | Stainless steel grade 316 | | |
| | | | | | | | | | Fascia/Purlin length | | | | | | | | | | | | | | | |
| | | | | | | | | | Less than 1.5m | 1.51m to 2.7m | 2.71m to 5m | 5.01m to 6m | | | | | | | | | | | yes/no | Type (Refer sheet 7) |
| 4x4 | 4.0 | 4.0 | 3.0 | 3.0 | 5.0 | 5.0 | 2.55 | 190x45 | — | 1 | 1 | — | no | 1 | 780 | 140x45 | 2/170x45 | 100x6 SHS | 100x5 SHS | — | — | — | 75x5 SHS | 100x5 SHS |
| 4x4+ANNEX | 4.0 | 4.0 | 3.0 | 3.0 | 5.0 | 5.0 | 2.55 | 190x45 | — | 1 | 1 | — | no | 1 | 780 | 140x45 | 2/170x45 | 100x6 SHS | 100x5 SHS | 7.8 | 0.45 | 4.4 | 75x5 SHS | 100x5 SHS |
| 4x5 | 4.0 | 5.0 | 3.0 | 4.0 | 5.0 | 6.0 | 2.55 | 190x45 | — | 1 | 2 | — | yes | 2 | 780 | 140x45 | 2/170x45 | 100x6 SHS | 100x5 SHS | — | — | — | 75x5 SHS | 100x5 SHS |
| 4x5+ANNEX | 4.0 | 5.0 | 3.0 | 4.0 | 5.0 | 6.0 | 2.55 | 190x45 | — | 1 | 2 | — | yes | 2 | 780 | 140x45 | 2/170x45 | 100x6 SHS | 100x5 SHS | 8.8 | 0.45 | 4.4 | 75x5 SHS | 100x5 SHS |
| 4x6 | 4.0 | 6.0 | 3.0 | 5.0 | 5.0 | 7.0 | 2.55 | 240x45 | — | 1 | 2 | 3 | yes | 2 | 780 | *170x45 | 2/170x45 | 100x6 SHS | 100x5 SHS | — | — | — | 75x5 SHS | 100x5 SHS |
| 4x6+ANNEX | 4.0 | 6.0 | 3.0 | 5.0 | 5.0 | 7.0 | 2.55 | 240x45 | — | 1 | 2 | 3 | yes | 2 | 780 | *170x45 | 2/170x45 | 100x6 SHS | 100x5 SHS | 9.8 | 0.45 | 4.4 | 75x5 SHS | 100x5 SHS |
| 5x5 | 5.0 | 5.0 | 4.0 | 4.0 | 6.0 | 6.0 | 2.55 | 190x45 | — | 1 | 2 | — | no | 1 | 730 | 140x45 | 2/170x45 | 100x6 SHS | 100x5 SHS | — | — | — | 75x5 SHS | 100x5 SHS |
| 5x5+ANNEX | 5.0 | 5.0 | 4.0 | 4.0 | 6.0 | 6.0 | 2.55 | 190x45 | — | 1 | 2 | — | no | 1 | 730 | 140x45 | 2/170x45 | 100x6 SHS | 100x5 SHS | 8.8 | 0.575 | 5.4 | 75x5 SHS | 100x5 SHS |
| 5x6 | 5.0 | 6.0 | 4.0 | 5.0 | 6.0 | 7.0 | 2.55 | 240x45 | — | 1 | 2 | 3 | yes | 2 | 730 | *170x45 | 2/170x45 | 100x6 SHS | 100x5 SHS | — | — | — | 75x5 SHS | 100x5 SHS |
| 5x6+ANNEX | 5.0 | 6.0 | 4.0 | 5.0 | 6.0 | 7.0 | 2.55 | 240x45 | — | 1 | 2 | 3 | yes | 2 | 730 | *170x45 | 2/170x45 | 100x6 SHS | 100x5 SHS | 9.8 | 0.575 | 5.4 | 75x5 SHS | 100x5 SHS |
| Provide bridging with 140x45 timber grade same as purlins | | | | | | | | | * For spans greater than 3750 provide 2/170x45 with 2 No. M16 bolts equally spaced along the purlin, c/w washers and nuts thru purlins. | | | | | | | | | | | | | | | |

STEELWORK NOTES

- S1. ALL WORKMANSHIP & MATERIALS SHALL BE IN ACCORDANCE WITH AS4100 & AS/NZS1554.
- S2. ALL STEEL SHALL BE IN ACCORDANCE WITH: AS1163 GRADE C350LO FOR RECTANGULAR AND SQUARE HOLLOW SECTIONS UNO
- S3. ALL BOLTS TO BE METRIC HEXAGONAL TO AS 1252 U.N.O. ALL BOLTS TO BE M16 4.6/S TO AS/NZS 1252 U.N.O. ALL BOLTS TO BE HOT DIP GALVANISED TO AS 1214 U.N.O.
- S4. ALL CLEATS AND GUSSETS SHALL BE 10mm PLATE TO AS/NZS3678 GRADE 250 U.N.O.
- S5. METAL ROOF CLADDING TO BE 0.42 BMT LYSAGHT CUSTOM ORB WITH A COLORBOND FINISH OR APPROVED EQUAL FIXED AS PER MANUFACTURER’S SPECIFICATIONS – COLORBOND COLOUR AS PER SPECIFICATION. IN MARINE ENVIRONMENT, PROVIDE COLORBOND ULTRA FINISH OR APPROVED EQUAL.
- S6. ALL WELDS TO BE 6mm CONTINUOUS FILLET WELDS (CFW) STRUCTURAL PURPOSE (SP) WELDS U.N.O. ALL WELDS TO BE MADE USING E48XX OR W50X GRADE 1 (OR BETTER) ELECTRODES TO AS/NZS 1554. GRIND ALL CORNERS & WELDS SMOOTH.
- S7. ALL STEELWORK TO BE HOT DIP GALVANISED IN ACCORDANCE WITH AS/NZS 2312 HDG600 SPECIFICATION. CORROSION PROTECTION COATING TO SURFACE PREPARATION OF SUBSTRATE MATERIAL IS CLASS 2½ TO AS 1627 AND PICKLED PRIOR GALVANISING. HOT DIPPED GALVANISED COATING SHALL BE IN ACCORDANCE WITH AS/NZS 4680.

- S8. ANY POST GALVANISING DAMAGE TO BE MADE GOOD WITH HIGH QUALITY TWO PACK EPOXY ZINC RICH PAINT CONFORMING TO AS/NZS 3750.9 WITH A MINIMUM DRY FILM THICKNESS OF 100 MICRONS. SURFACE PREPARATION TO BE ACCORDING TO PAINT MANUFACTURER’S RECOMMENDATIONS.
- S9. THE ENDS OF ALL TUBULAR OR HOLLOW MEMBERS ARE TO BE SEALED WITH 6mm THICK PLATES AND CONTINUOUS FILLET WELDED U.N.O.
- S10. PROTECTIVE COATINGS TO BE APPLIED AFTER ALL FABRICATION COMPLETED. NO WELDING ETC TO BE CARRIED OUT DURING OR AFTER APPLICATION OF COATING SYSTEM.
- S11. THE PRINCIPAL CONTRACTOR SHALL CONFER WITH THE FABRICATOR AND GALVANISER TO ENSURE VENT HOLES ARE PROVIDED IN ACCORDANCE WITH AS/NZS 4680.
- S12. FOR MARINE ENVIRONMENTAL ZONES (WITHIN 1km OF THE SHORELINE), ALL STEEL MEMBERS, FASTENERS, INCLUDING BOLTS, NUTS, AND CLEATS SHALL BE STAINLESS STEEL. PLASTIC SEPARATORS SHALL BE PROVIDED TO AVOID CONTACT BETWEEN DISSIMILAR MATERIALS. STAINLESS STEEL GRADE 316 TO BE USED.
- S13. CO-ORDINATE WITH LIGHTNING PROTECTION DETAILS – REFER TO BSD-10133.

STAINLESS STEEL:

1. BEFORE FABRICATION SUBMIT COPIES OF SHOP DRAWINGS FOR REVIEW. REVIEW DOES NOT INCLUDE DIMENSION CHECKING.
2. STAINLESS STEEL MATERIAL SHALL NOT BE STORED WITH CARBON STEEL.
3. TOOLS USED FOR CARBON STEEL SHALL NOT BE USED TO FABRICATE OR ASSEMBLE STAINLESS STEEL COMPONENTS.
4. THE STAINLESS STEEL SHALL BE WRAPPED OR OTHERWISE PROTECTED DURING TRANSPORT TO AVOID CONTAMINATION BY FERROUS PRODUCTS.
5. WELDING SHALL BE IN ACCORDANCE WITH AS1554.6.
6. LIMIT THE INPUT OF HEAT INTO THE WELD. THE WELD SHALL NOT BE PREHEATED, POST-HEATED OR STRESS RELIEVED.
7. GRADE 316L ELECTRODES SHALL BE USED FOR 316L.
8. WELDS SHALL BE CATEGORY 2B IN ACCORDANCE WITH AS1554.6.
9. SURFACE FINISHES OF WELDS SHALL BE GRADE 1, POLISHED USING 320 GRIT OR FINER, SILICONE CARBIDE ABRASIVES WITH LUBRICATION. AFTER POLISHING, WELDS SHALL BE PASSIVATED USING NITRIC ACID IN ACCORDANCE WITH ASTM A380.
10. ALL STAINLESS STEEL COMPONENTS SHALL HAVE A Ra<0.5µm AND PASSIVATED USING NITRIC ACID IN ACCORDANCE WITH ASTM A380.
11. CHEMICAL ANCHORS AND BOLTS TO BE GRADE 316 STAINLESS STEEL A4-50 MINIMUM.

STRUCTURAL DESIGN CERTIFICATION


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| DESIGN Original signed by : L. Mendis RPEQ: 8950 – 2014.11.26 | DESIGN CHECK Original signed by : D. Bateup RPEQ: 13095 – 2014.11.26 | AUTHORISED FOR ISSUE Original signed by : B. Balakumar RPEQ: 3963 – 2014.11.27 |
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
BRISBANE CITY COUNCIL STANDARD DRAWING

| | | |
|--|--|---|
| HIP ROOF SHELTER-PARK- STRUCTURAL NOTES (PAGE 2 OF 2) SHEET 2 OF 7 | | SCALE NOT TO SCALE DWG NO. BSD-10131 ORIGINAL SIZE A3 REVISION C |
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|-------|---|---------------|---------------|----------------|---|------------------------------|---|------|----------|
| | | | | | DRAWING AUTHORISED FOR PUBLICATION I. CONDRIK AUTHORISED JUNE 2015 ----- ASSET ENGINEERING MANAGER STRATEGIC ASSET MANAGEMENT | DESIGN | L.M. | DATE | Sept '14 |
| C | Drawing Title Amended, Hip Roof Shelters Schedule (mm) to (m) | FEB '16 | JUL '16 | JUL '16 | | DRAWN | G.B. | DATE | Sept '14 |
| B | NOTE S13 ADDED – LIGHTNING PROTECTION | JUNE '15 | JUNE '15 | JUNE '15 | DESIGN APPROVED D. VAN DER WALLE APPROVED JUNE 2015 ----- SENIOR CO-ORDINATOR PARKS ASSET SERVICES BRANCH - FIELD SERVICES GROUP | CHECKED | D.B. | DATE | Sept '14 |
| A | ORIGINAL ISSUE | SEPT '14 | SEPT '14 | SEPT '14 | | DRAWING FILENAME | BSD-10131 (1) Hip roof shelter - Park - Structural notes (Page 2 of 2) - Sheet 2 of 7.dwg | | |
| ISSUE | AMENDMENT | DRAWN DATE | CHK'D DATE | APPR'D DATE | ASSOCIATED PLANS | BSD-10131 SHEETS 1,3,4,5,6&7 | | | |







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| | | | | | DRAWING AUTHORISED FOR PUBLICATION I. CONDRIK AUTHORISED JUNE 2015 ----- ASSET ENGINEERING MANAGER STRATEGIC ASSET MANAGEMENT | DESIGN | L.M. | DATE | Sept '14 |  | BRISBANE CITY COUNCIL STANDARD DRAWING | | | |
| | | | | | | DRAWN | G.B. | DATE | Sept '14 | | <div>HIP ROOF SHELTER—PARK— RECTANGULAR SHELTER—PLAN AND DETAILS—SHEET 4 OF 7</div> | SCALE 1:50, 1:20 | | |
| C | Drawing Title Amended | FEB '16 | JUL '16 | JUL '16 | DESIGN APPROVED D. VAN DER WALLE APPROVED JUNE 2015 ----- SENIOR CO-ORDINATOR PARKS ASSET SERVICES BRANCH - FIELD SERVICES GROUP | CHECKED | D.B. | DATE | Sept '14 | | | Dwg No. | BSD-10131 | |
| B | NOTE 5 ADDED - LIGHTNING PROTECTION | JUNE '15 | JUNE '15 | JUNE '15 | | DRAWING FILENAME | BSD-10131(1) Hip roof shelter - Park - Rectangular shelter - Plan and details - Sheet 4 of 7.dwg | | | | | ORIGINAL SIZE | REVISION | |
| A | ORIGINAL ISSUE | SEPT '14 | SEPT '14 | SEPT '14 | | ASSOCIATED PLANS | BSD-10131 SHEETS 1,2,3,5,6 & 7 | | | | | A3 | C | |
| ISSUE | AMENDMENT | DRAWN DATE | CHK'D DATE | APPR'D DATE | | | | | | | | | | |

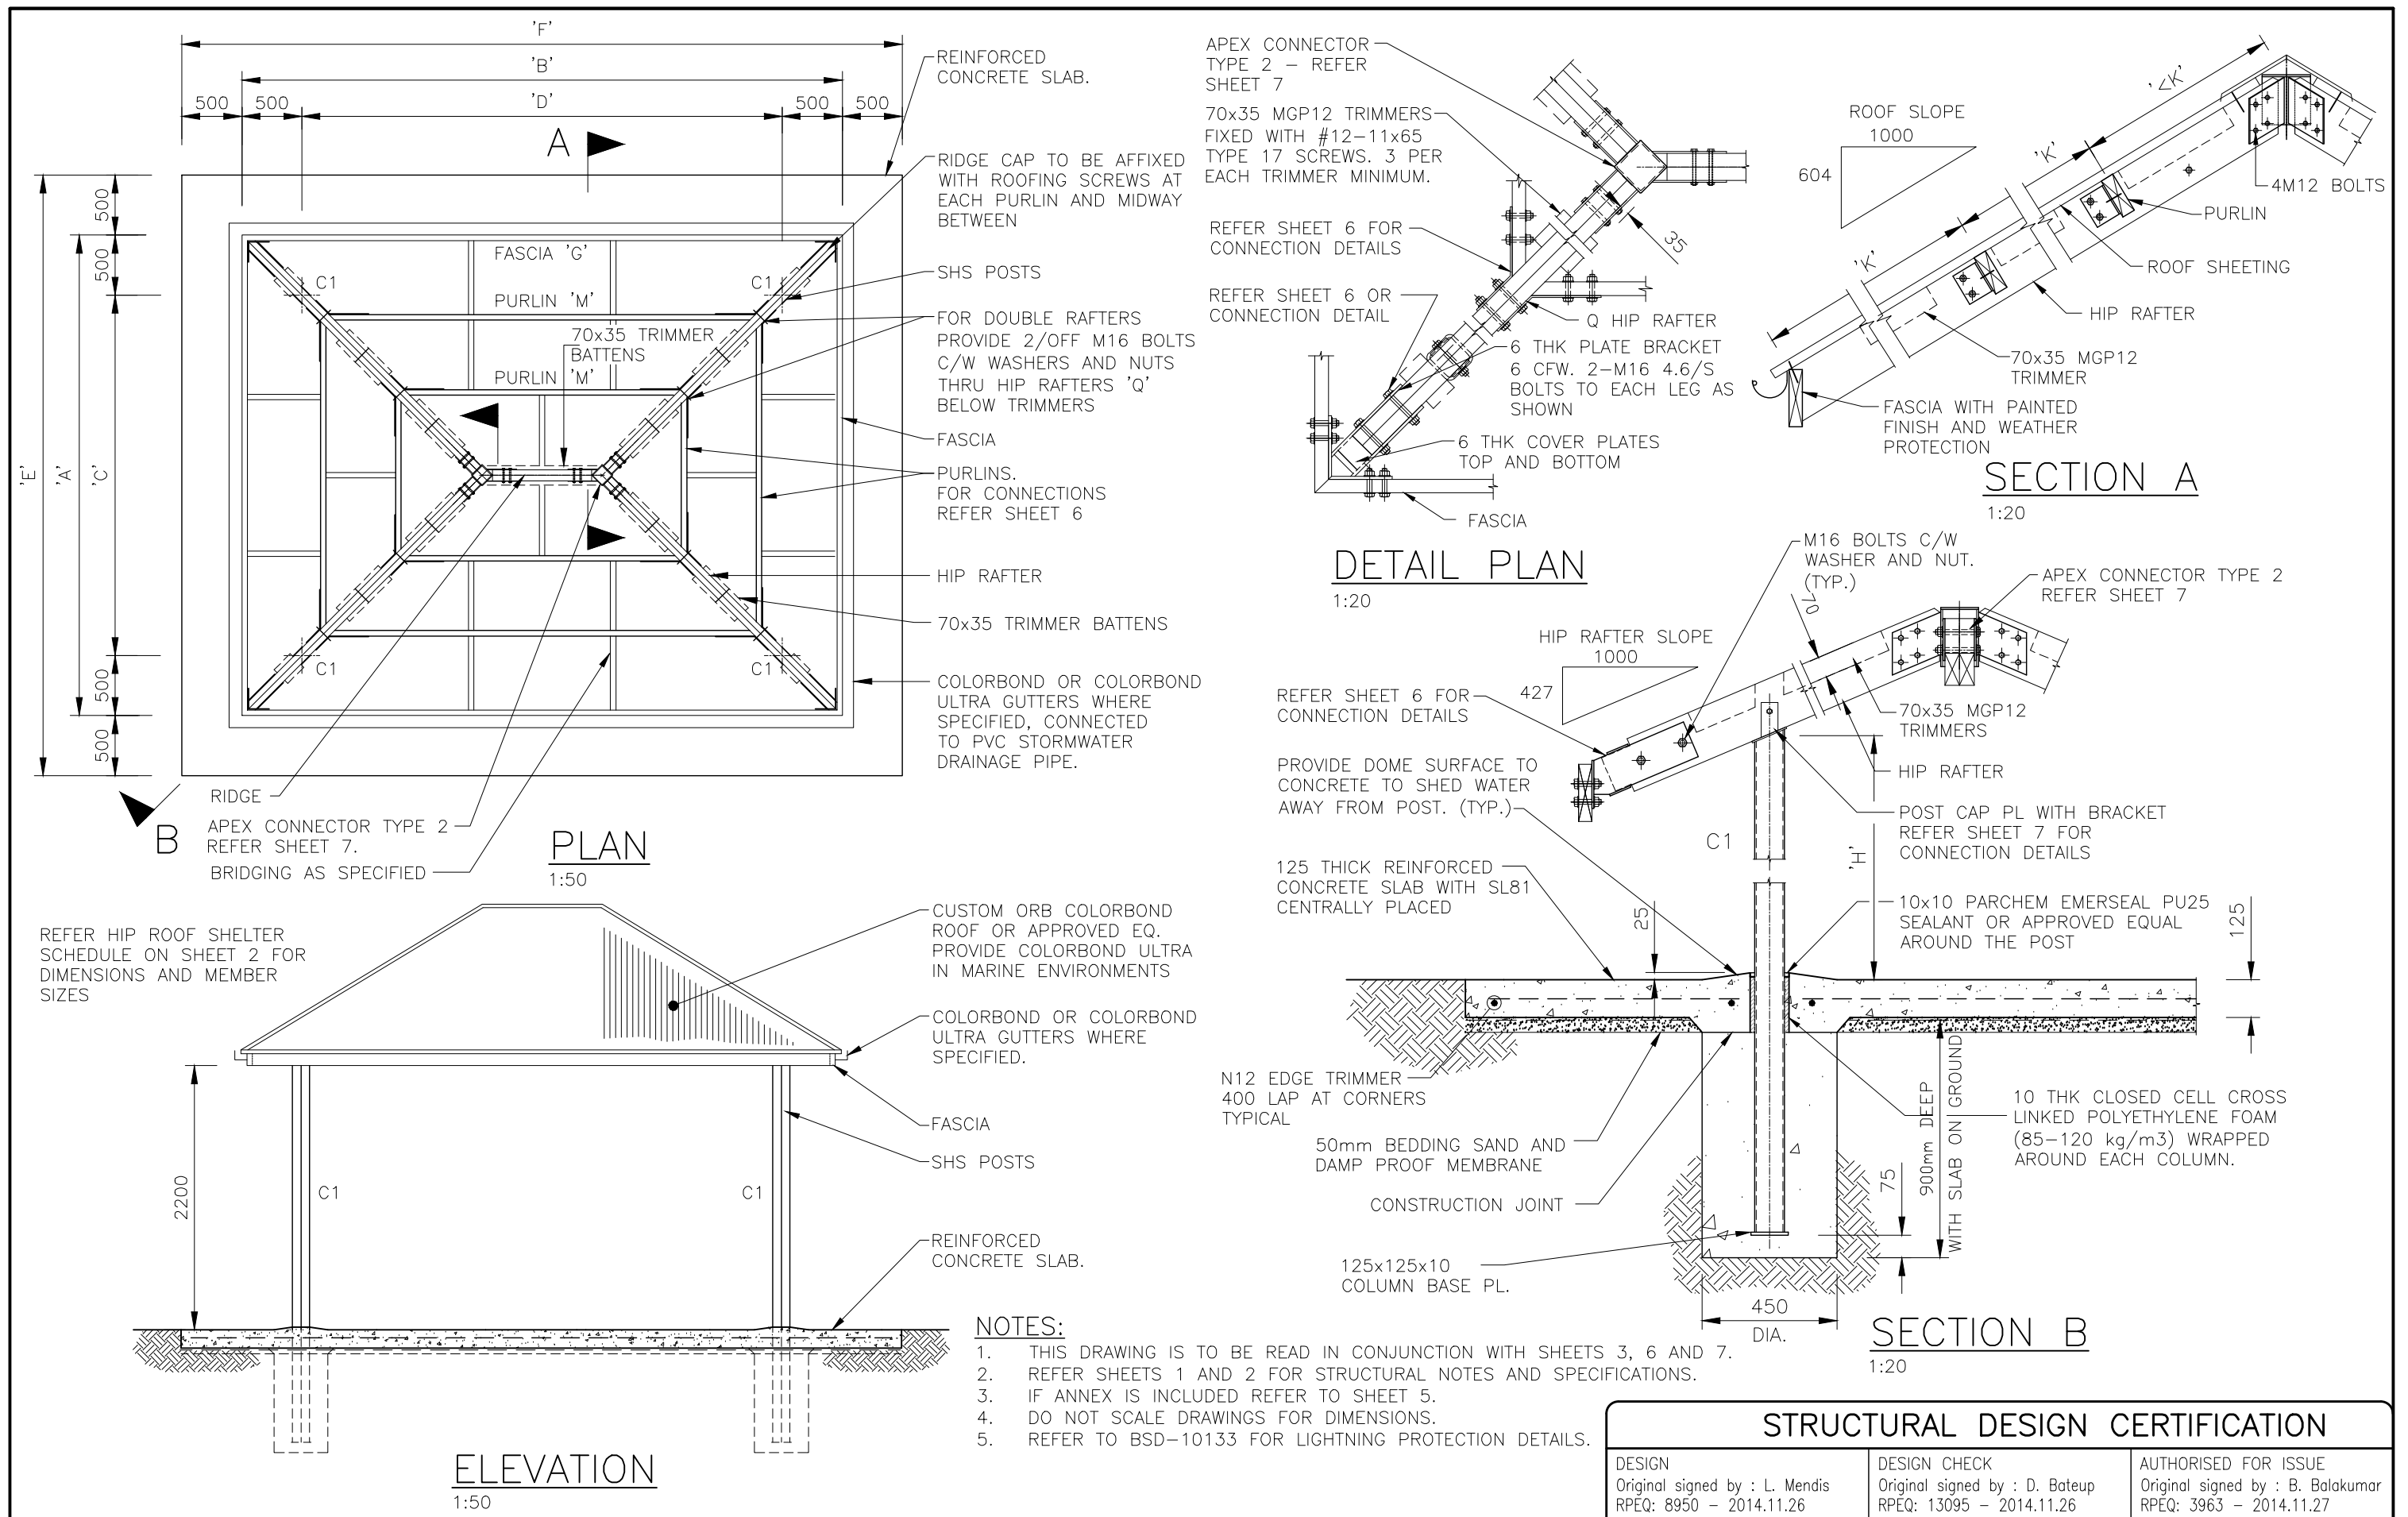


| STRUCTURAL DESIGN CERTIFICATION | | |
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| DESIGN Original signed by : L. Mendis RPEQ: 8950 - 2014.11.26 | DESIGN CHECK Original signed by : D. Bateup RPEQ: 13095 - 2014.11.26 | AUTHORISED FOR ISSUE Original signed by : B. Balakumar RPEQ: 3963 - 2014.11.27 |
| BRISBANE CITY COUNCIL STANDARD DRAWING | | |
| HIP ROOF SHELTER-PARK- RECTANGULAR SHELTER-PLAN AND DETAILS-SHEET 4 OF 7 | | SCALE 1:50, 1:20 DWG No. BSD-10131 ORIGINAL SIZE A3 REVISION C |

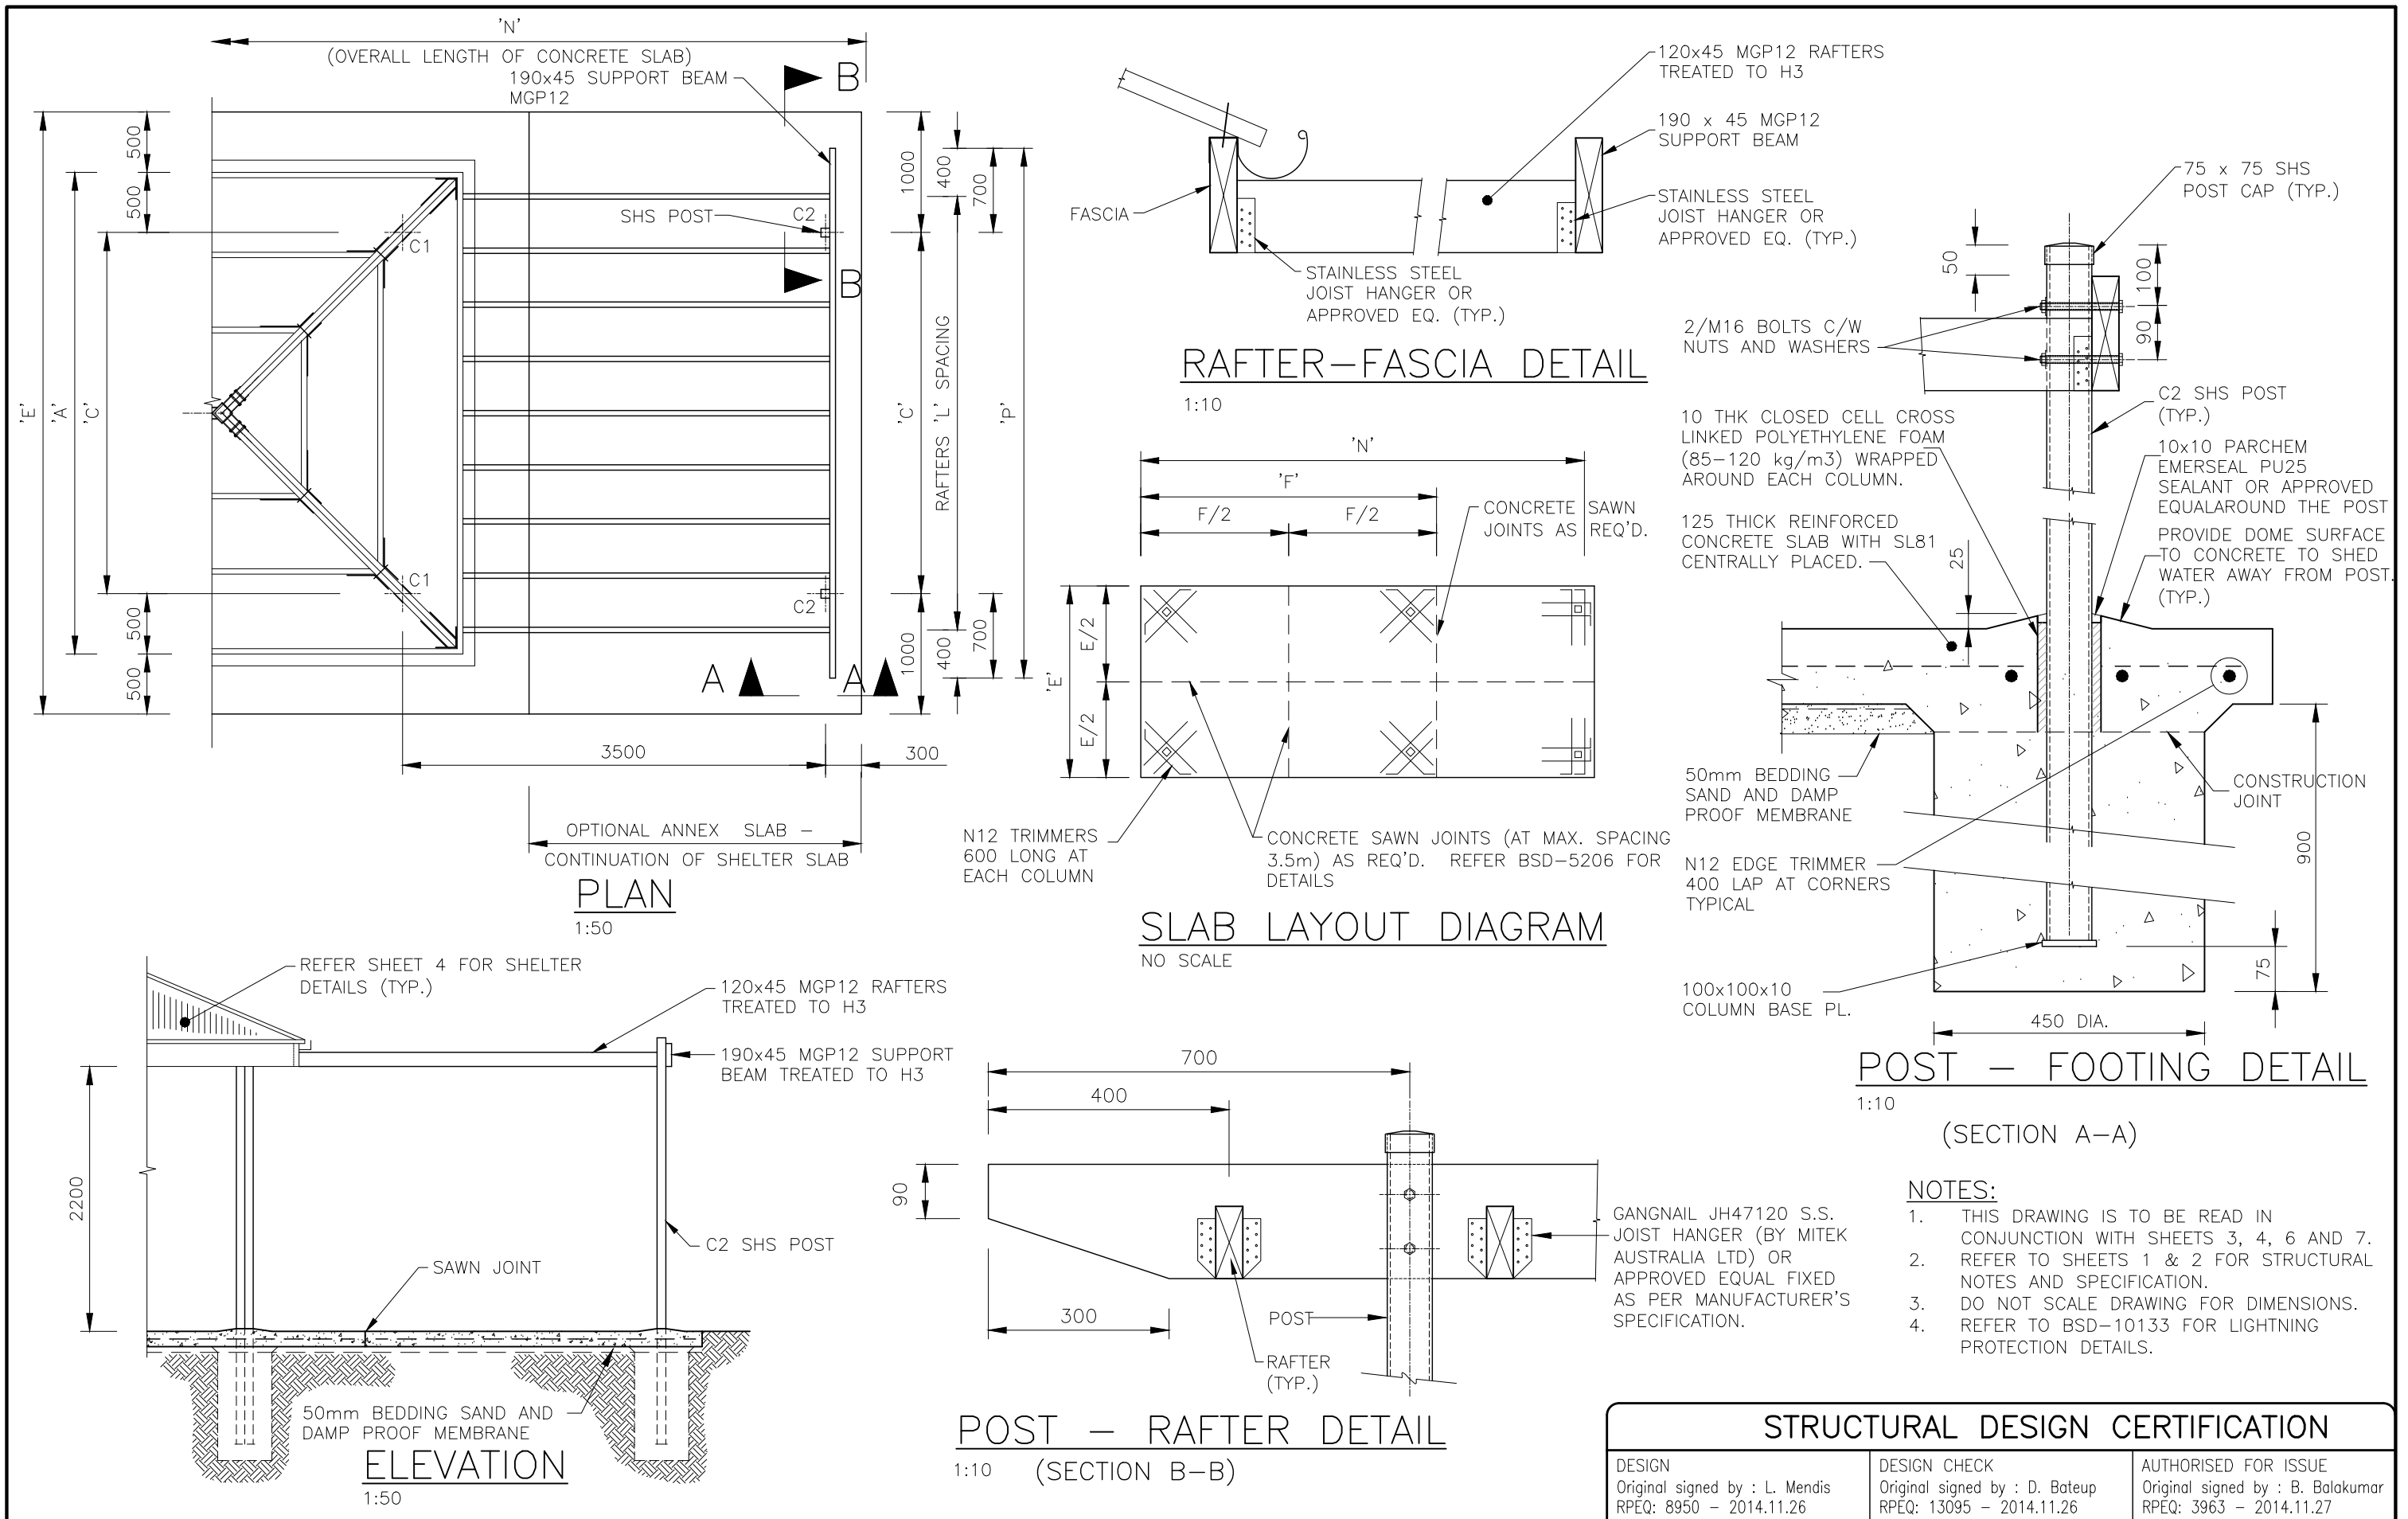


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| | | AUTHORISED FOR ISSUE Original signed by : B. Balakumar RPEQ: 3963 – 2014.11.27 | |
| BRISBANE CITY COUNCIL STANDARD DRAWING | | | |
| HIP ROOF SHELTER—PARK— OPTIONAL ANNEX—PLAN AND DETAILS—SHEET 5 OF 7 | | SCALE 1:50, 1:10 | |
| | | DWG No. BSD—10131 | |
| | | ORIGINAL SIZE A3 | REVISION C |


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| DESIGN APPROVED D. VAN DER WALLE APPROVED JUNE 2015 | | | | | CHECKED D.B. | DATE Sept '14 |
| SENIOR CO-ORDINATOR PARKS ASSET SERVICES BRANCH - FIELD SERVICES GROUP | | | | | DRAWING FILENAME BSD-10131(1) Hip roof shelter - Park - Optional annex - Plan and details - Sheet 5 of 7.dwg | |
| | | | | | ASSOCIATED PLANS BSD-10131 SHEETS 1,2,3,4,6 & 7 | |
| C | Drawing Title Amended | FEB '16 | JUL '16 | JUL '16 |  | |
| B | NOTE 4 ADDED - LIGHTNING PROTECTION | JUNE '15 | JUNE '15 | JUNE '15 | | |
| A | ORIGINAL ISSUE | SEPT '14 | SEPT '14 | SEPT '14 | | |
| ISSUE | AMENDMENT | DRAWN DATE | CHK'D DATE | APPR'D DATE | | |

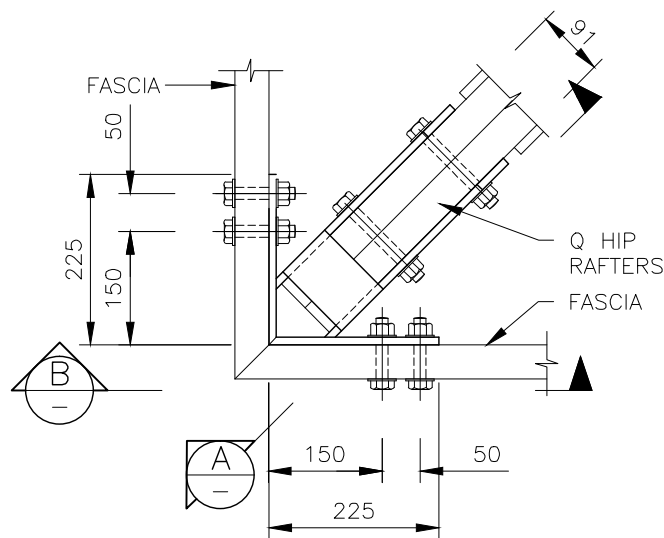

HIP RAFTER-FASCIA CONNECTOR
SCALE 1:10

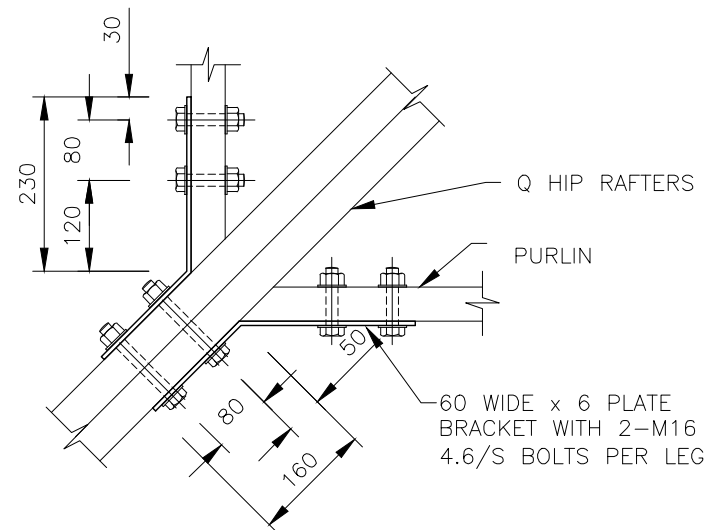


HIP RAFTER-PURLIN CONNECTOR
SCALE 1:10

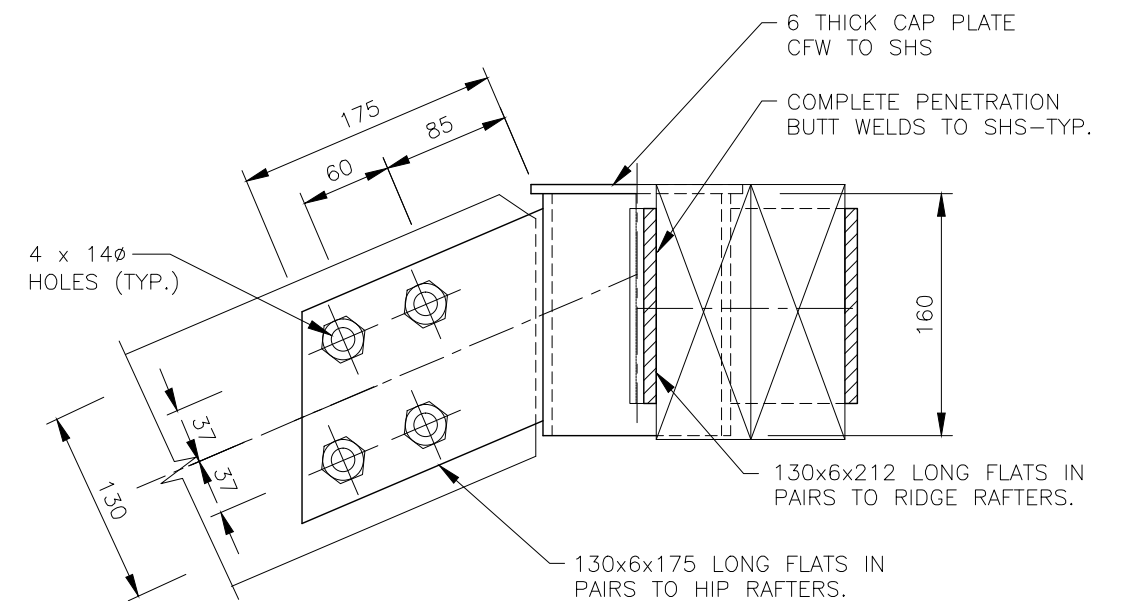


SECTION A
SCALE 1:5
Sh7

NOTES:


1. THIS DRAWING IS TO BE READ IN CONJUNCTION WITH SHEETS 3, 4, & 7.
2. REFER SHEETS 1 & 2 FOR STRUCTURAL NOTES AND SPECIFICATION.
3. IF ANNEX IS INCLUDED REFER TO SHEET 5.
4. DO NOT SCALE DRAWINGS FOR DIMENSIONS.
5. REFER TO BSD-10133 FOR LIGHTNING PROTECTION DETAILS.

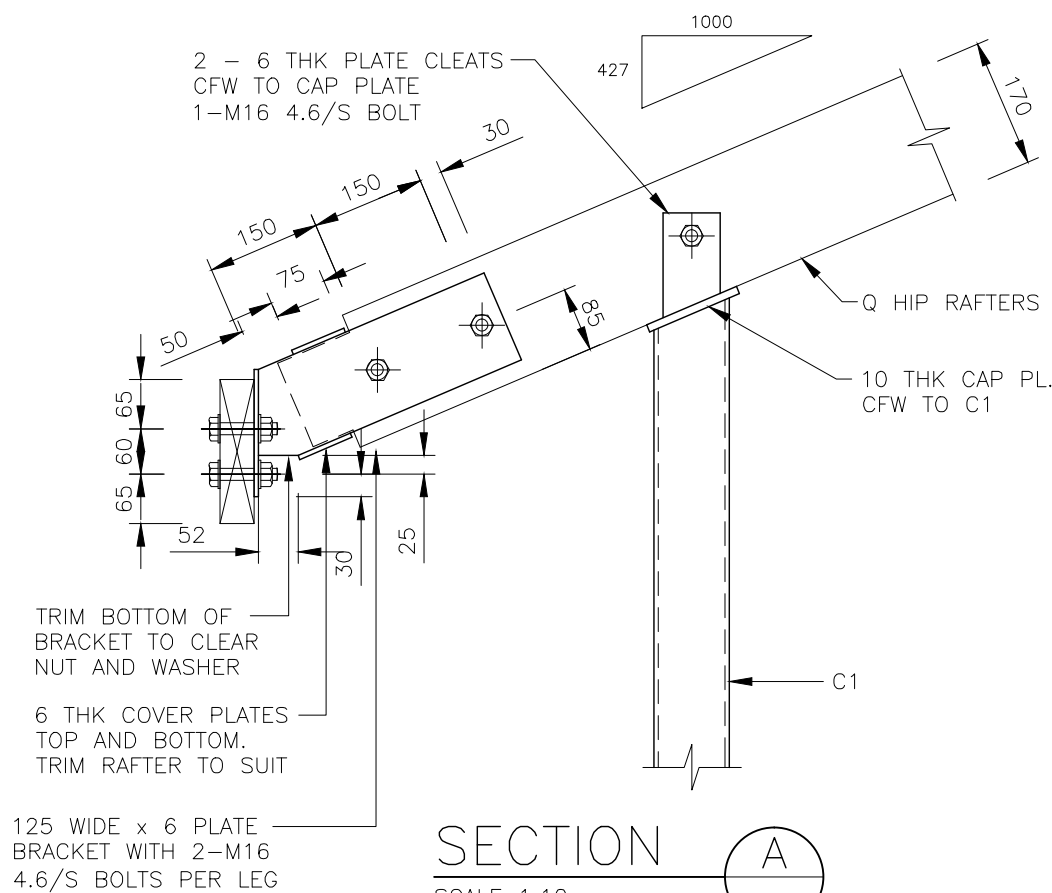

SECTION A
SCALE 1:10

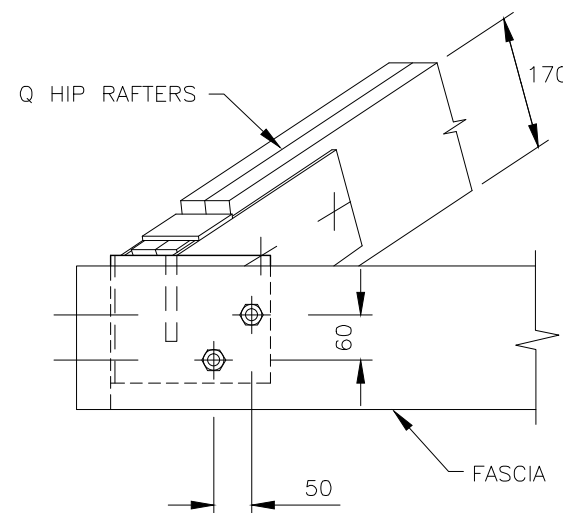

SECTION B
SCALE 1:10

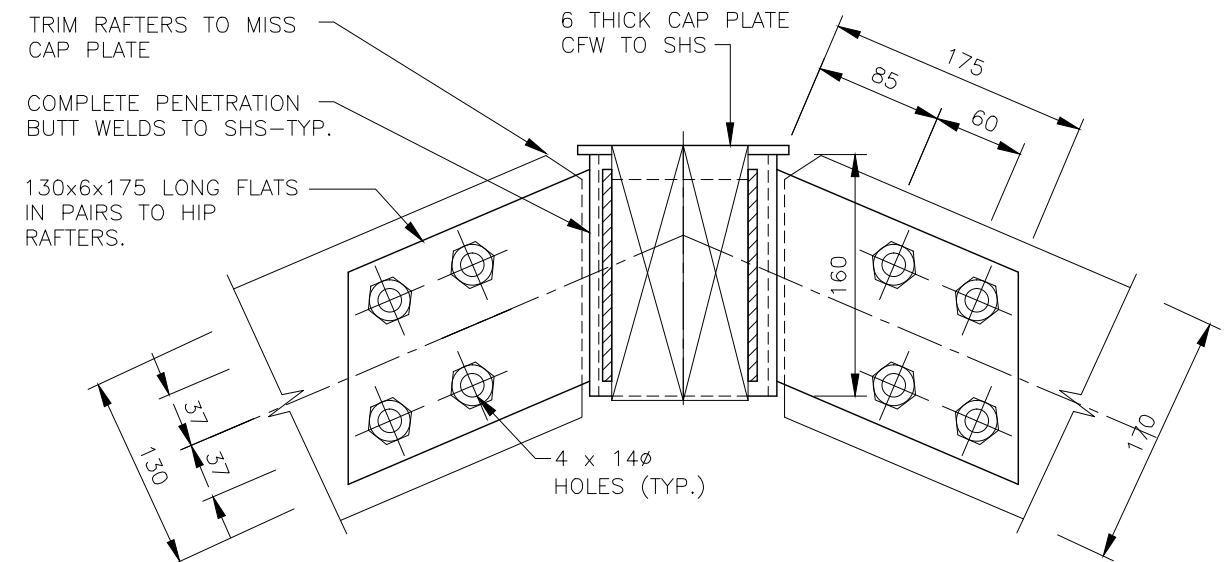

SECTION C
SCALE 1:5
Sh7

STRUCTURAL DESIGN CERTIFICATION


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| BRISBANE CITY COUNCIL STANDARD DRAWING | |
| HIP ROOF SHELTER-PARK-DETAILS | |
| SHEET 6 OF 7 | |
| SCALE 1:10, 1:5 | REVISION C |

| ISSUE | AMENDMENT | DRAWN DATE | CHK'D DATE | APPR'D DATE |
|-------|-------------------------------------|------------|------------|-------------|
| C | Drawing Title Amended | FEB '16 | JUL '16 | JUL '16 |
| B | NOTE 5 ADDED - LIGHTNING PROTECTION | JUNE '15 | JUNE '15 | JUNE '15 |
| A | ORIGINAL ISSUE | SEPT '14 | SEPT '14 | SEPT '14 |






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| DRAWING AUTHORISED FOR PUBLICATION I. CONDRIK AUTHORISED JUNE 2015 | DESIGN L.M. | DATE Sept '14 |
| ASSET ENGINEERING MANAGER STRATEGIC ASSET MANAGEMENT | DRAWN G.B. | DATE Sept '14 |
| DESIGN APPROVED D. VAN DER WALLE APPROVED JUNE 2015 | CHECKED D.B. | DATE Sept '14 |
| SENIOR CO-ORDINATOR PARKS ASSET SERVICES BRANCH - FIELD SERVICES GROUP | DRAWING FILENAME BSD-10131 (C) Hip roof shelter - Park - Details - Sheet 6 of 7.dwg | ASSOCIATED PLANS BSD-10131 SHEETS 1,2,3,4,5 & 7 |



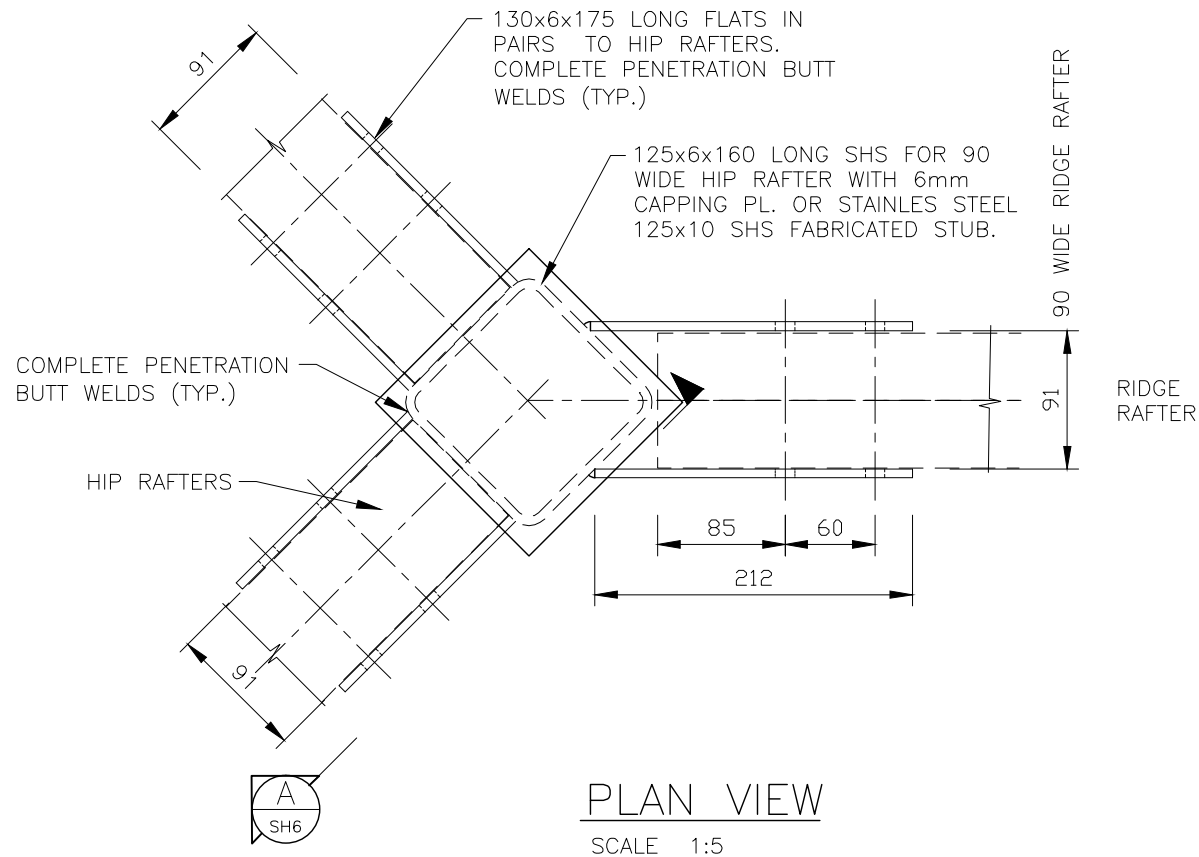

NOTES:

1. THIS DRAWING TO BE READ IN CONJUNCTION WITH SHEETS 3, 4 & 6.
2. REFER SHEETS 1 & 2 FOR STRUCTURAL NOTES AND SPECIFICATIONS.
3. IF ANNEX IS INCLUDED REFER TO SHEET 5.
4. DO NOT SCALE DRAWINGS FOR DIMENSIONS.
5. REFER TO BSD-10133 FOR LIGHTNING PROTECTION DETAILS.

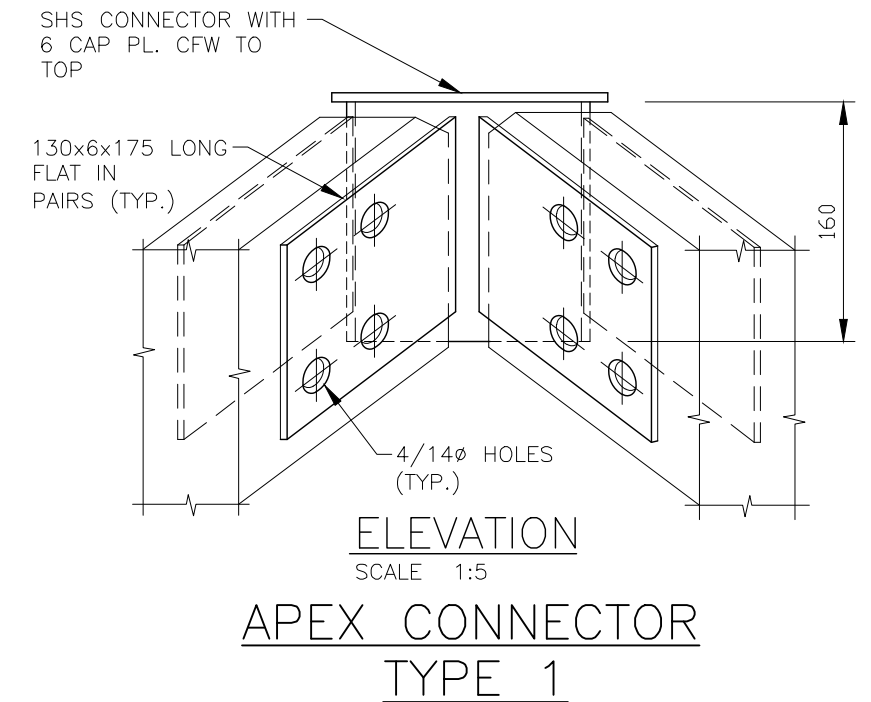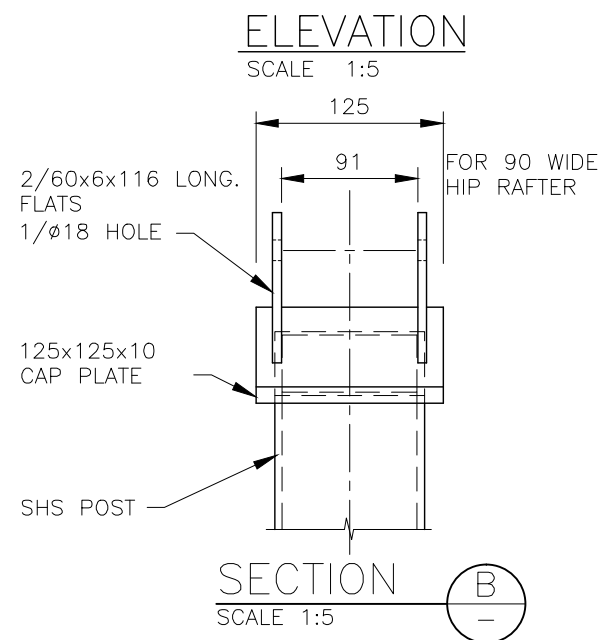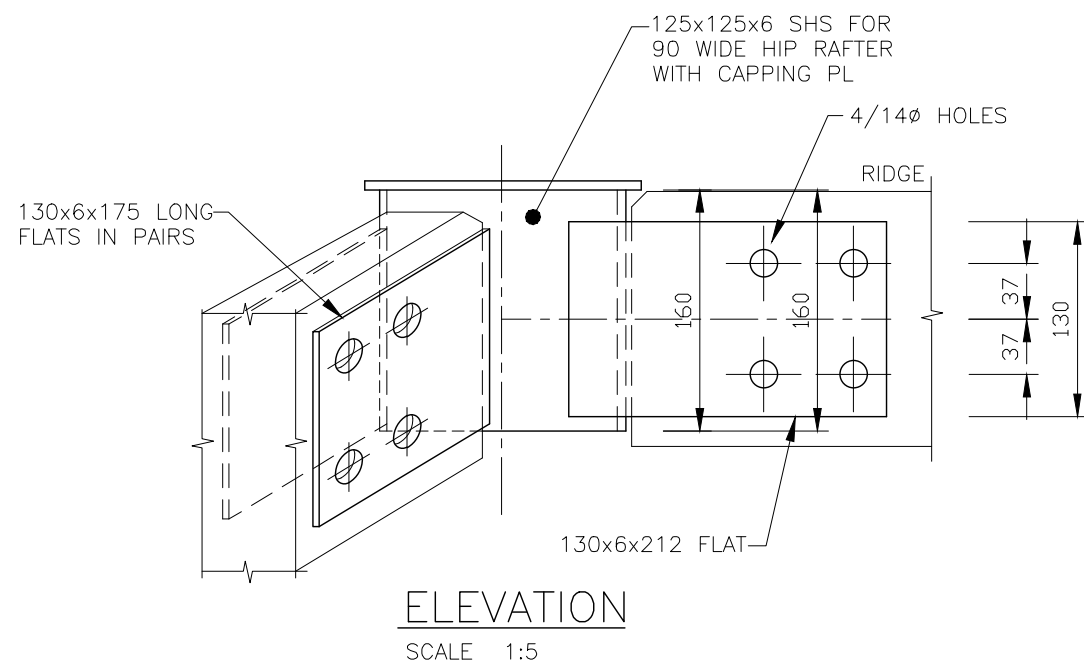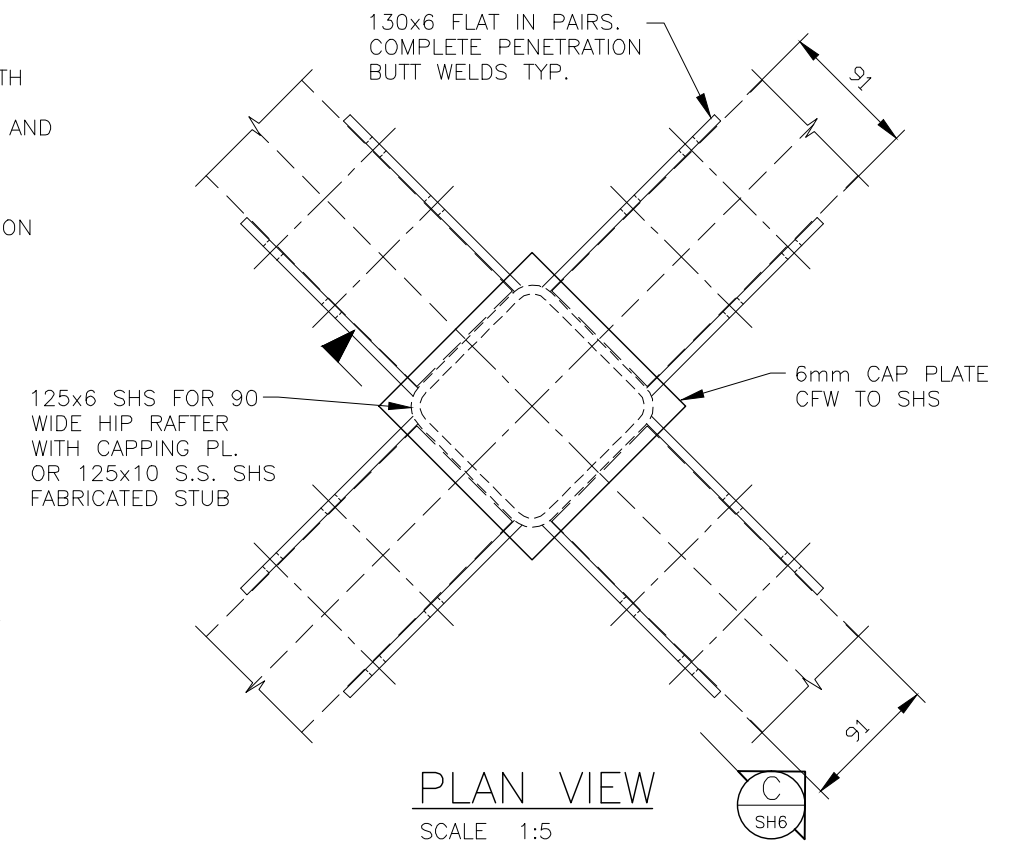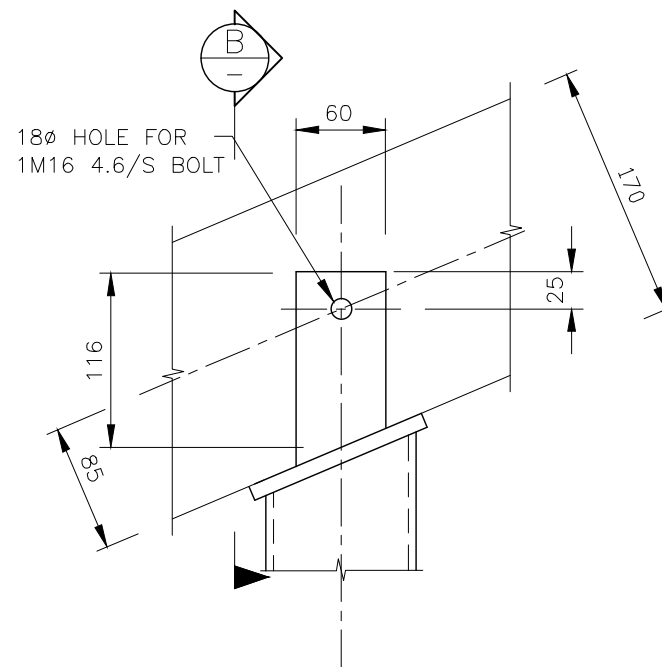

APEX CONNECTOR TYPE 2

POST TOP CONNECTION




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| BRISBANE CITY COUNCIL STANDARD DRAWING | |
| HIP ROOF SHELTER-PARK-DETAILS | |
| SHEET 7 OF 7 | |
| SCALE 1:5 | DWG No. BSD-10131 |
| ORIGINAL SIZE A3 | REVISION C |


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| ASSET ENGINEERING MANAGER STRATEGIC ASSET MANAGEMENT | | | | | DRAWN G.B. | DATE Apl '14 |
| DESIGN APPROVED D. VAN DER WALLE APPROVED JUNE 2015 | | | | | CHECKED D.B. | DATE Jun 14 |
| SENIOR CO-ORDINATOR PARKS ASSET SERVICES BRANCH - FIELD SERVICES GROUP | | | | | DRAWING FILENAME BSD-10131 (C) Hip roof shelter - Park - Details - Sheet 7 of 7.dwg | |
| | | | | | ASSOCIATED PLANS BSD-10131 SHEETS 1 TO 6 | |
| C | Drawing Title Amended | FEB '16 | JUL '16 | JUL '16 | | |
| B | NOTE 5 ADDED - LIGHTNING PROTECTION | JUNE '15 | JUNE '15 | JUNE '15 | | |
| A | ORIGINAL ISSUE | JUNE '14 | JUNE '14 | JUNE '14 | | |
| ISSUE | AMENDMENT | DRAWN DATE | CHK'D DATE | APPR'D DATE | | |





STRUT/POST CONNECTION DETAIL
SCALE 1:5

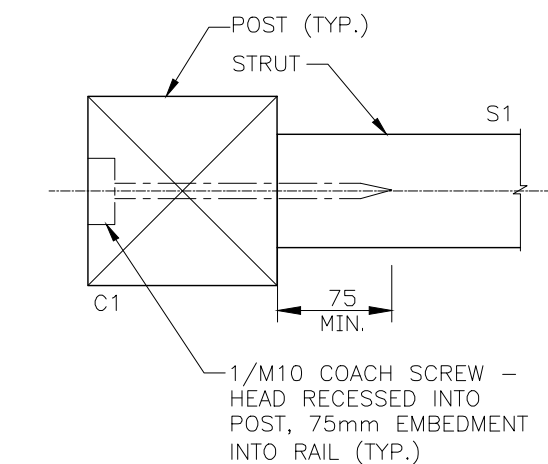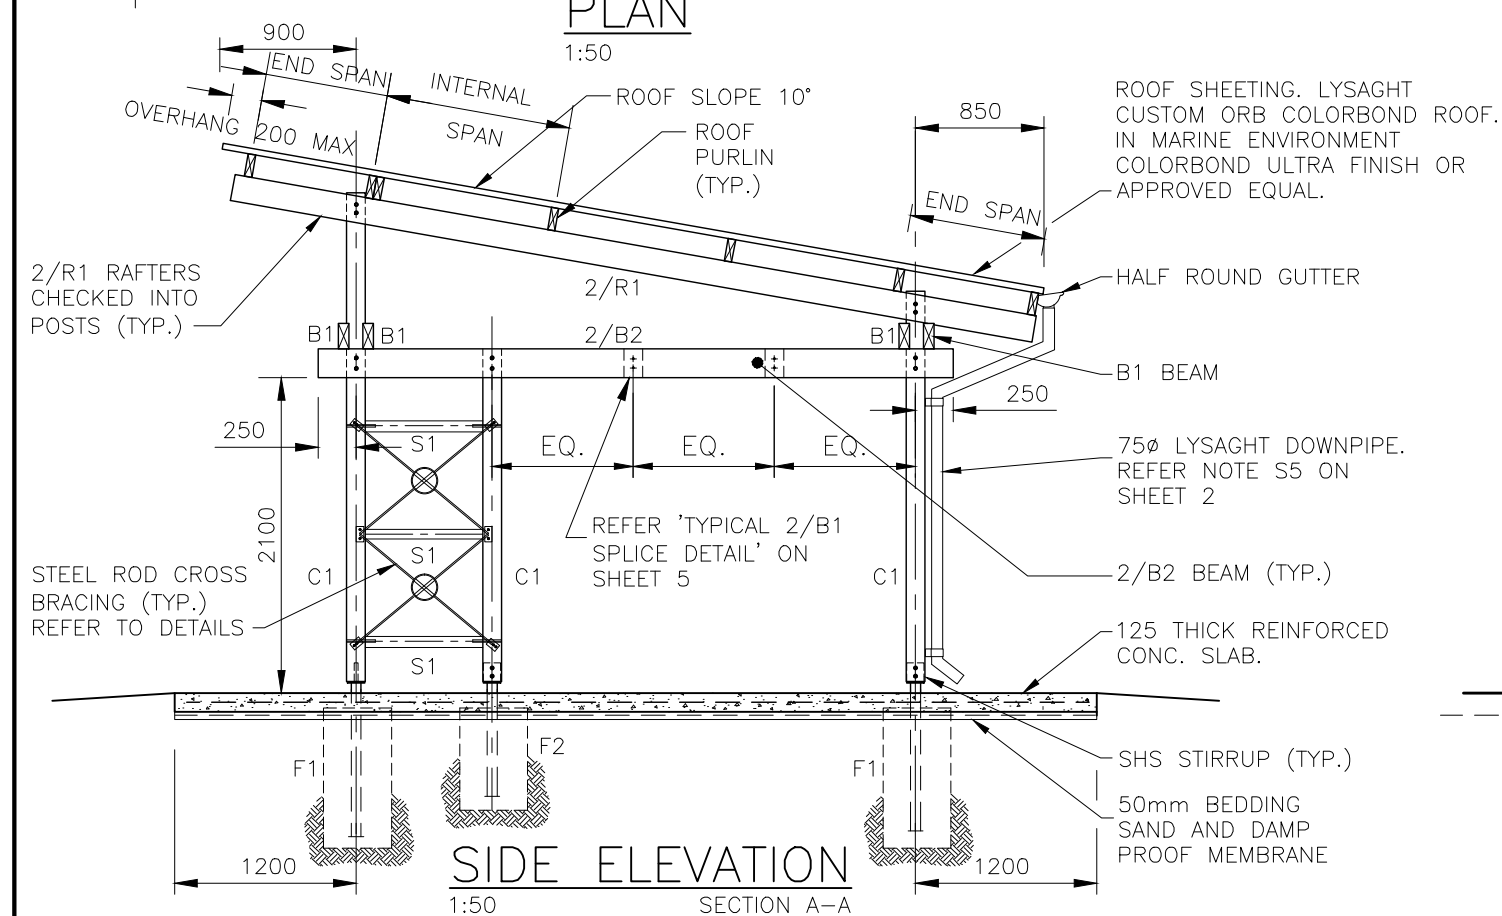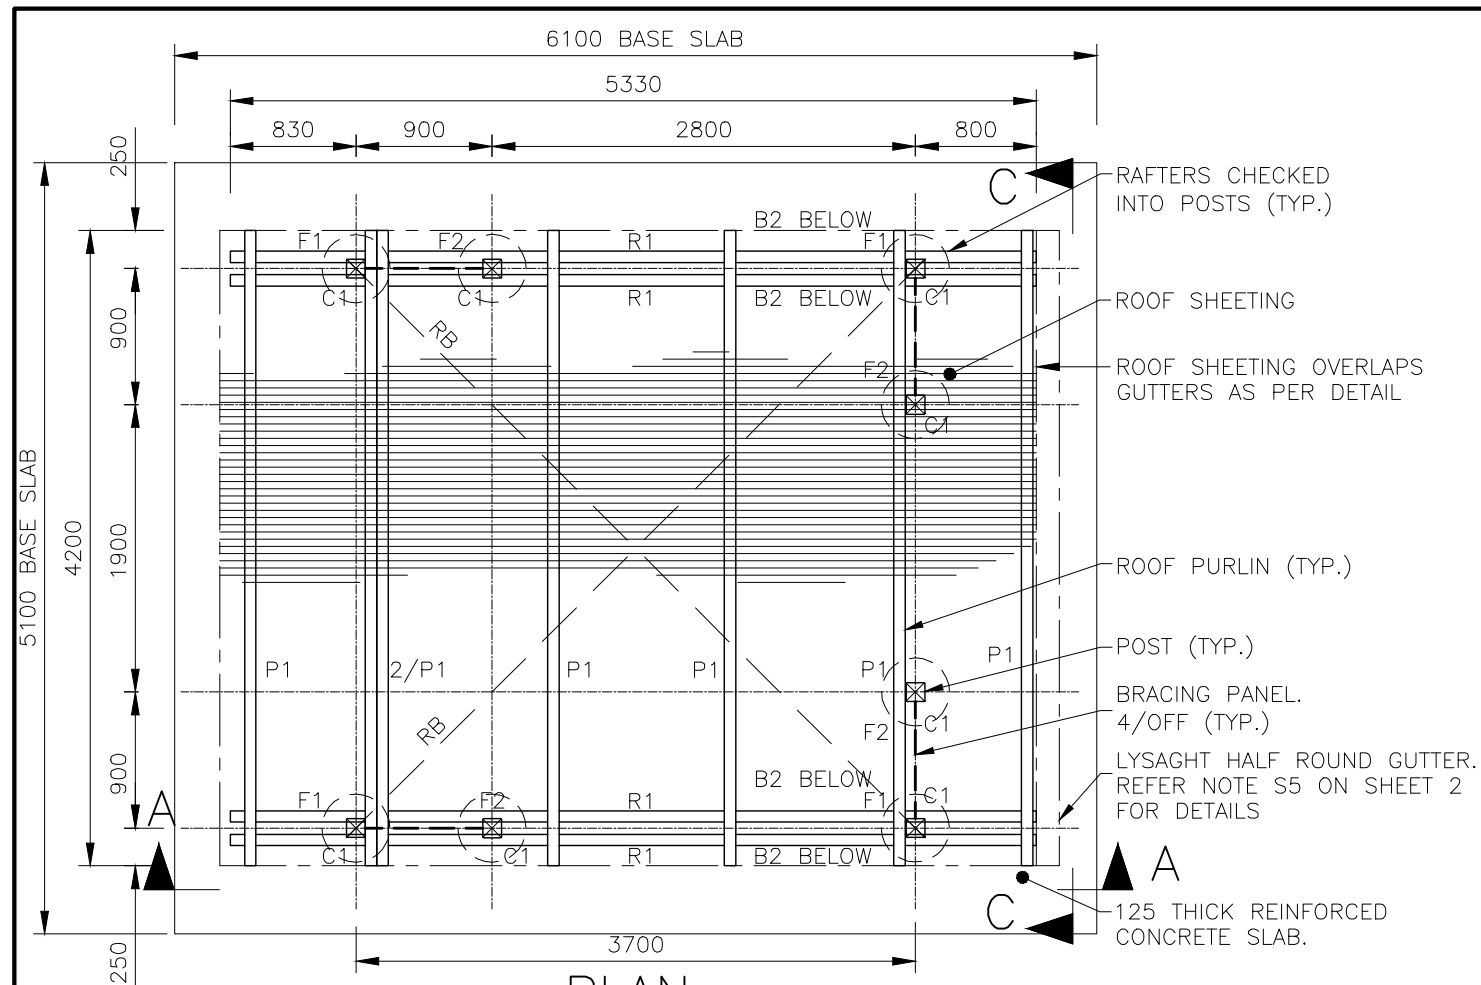- NOTES:**
1. THIS DRAWING IS TO BE READ IN CONJUNCTION WITH SHEETS 1, 2, 4 AND 5.
 2. REFER TO BSD-10133 FOR LIGHTNING PROTECTION DETAILS.

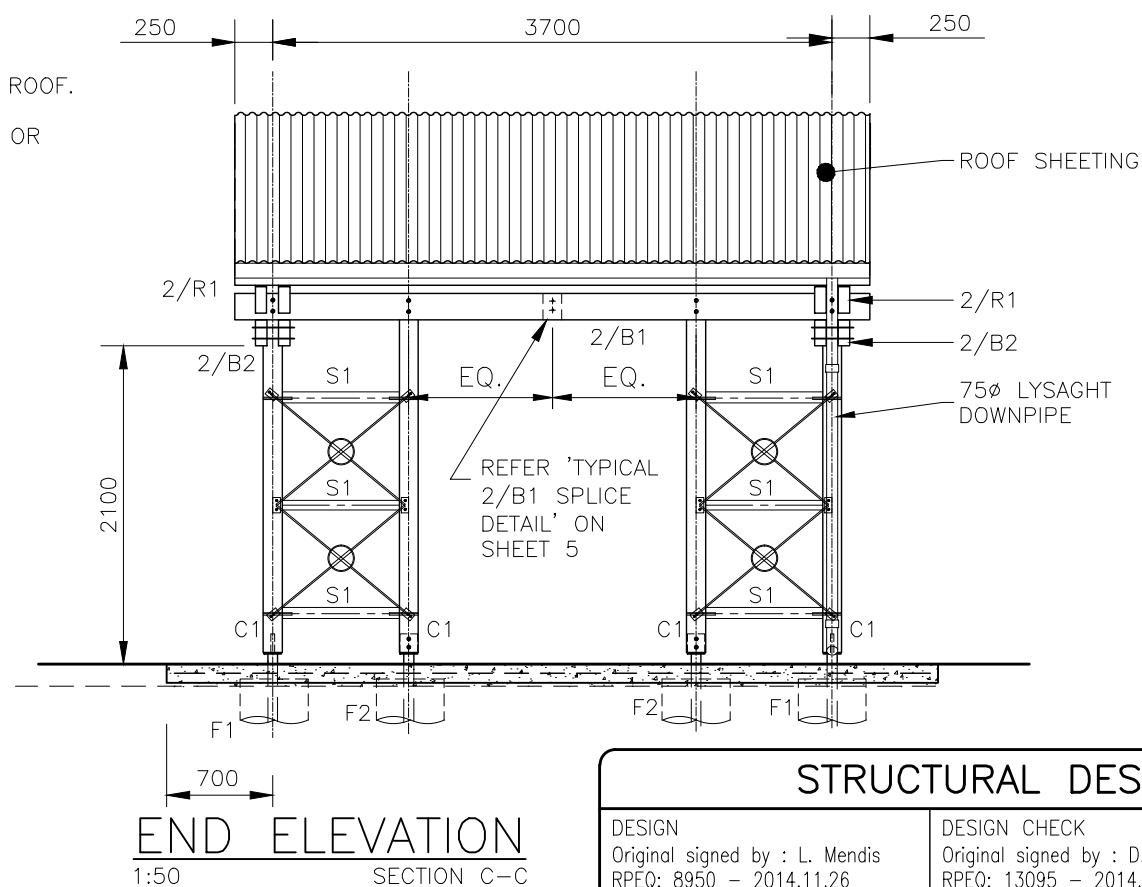

STRUCTURAL DESIGN CERTIFICATION

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| BRISBANE CITY COUNCIL STANDARD DRAWING | |
| SKILLION ROOF SHELTER-PARK PLAN AND DETAILS SHEET 3 OF 5 | |
| SCALE 1:50, 1:20, 1:5 | DWG No. BSD-10132 |
| ORIGINAL SIZE A3 | REVISION C |

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| DRAWING AUTHORISED FOR PUBLICATION I. CONDRIK AUTHORISED JUNE 2015 | | | | DESIGN L.M. | DATE Sept '14 |
| ASSET ENGINEERING MANAGER STRATEGIC ASSET MANAGEMENT | | | | DRAWN G.B. | DATE Sept '14 |
| DESIGN APPROVED D. VAN DER WALLE APPROVED JUNE 2015 | | | | CHECKED D.B. | DATE Sept '14 |
| SENIOR CO-ORDINATOR PARKS ASSET SERVICES BRANCH - FIELD SERVICES GROUP | | | | DRAWING FILENAME BSD-10132 (C) Skillion Roof Shelter - Park - Plan and details - Sheet 3 of 5.dwg | |
| | | | | ASSOCIATED PLANS BSD-10132 SHEETS 1, 2, 4 AND 5 | |
| C | Drawing Title Amended | FEB '16 | JUL '16 | JUL '16 | |
| B | NOTE 2 ADDED - LIGHTNING PROTECTION | JUNE '15 | JUNE '15 | JUNE '15 | |
| A | ORIGINAL ISSUE | SEPT '14 | SEPT '14 | SEPT '14 | |
| ISSUE | AMENDMENT | DRAWN DATE | CHK'D DATE | APPR'D DATE | |



GENERAL NOTES:

| | |
|-----|--|
| G1 | THE BUILDER SHALL BE RESPONSIBLE FOR MAINTAINING STABILITY OF THE STRUCTURE UNTIL COMPLETION OF CONSTRUCTION AND SHALL ENSURE THAT NO PART OF THE STRUCTURE IS OVERSTRESSED. |
| G2 | THE BUILDER SHALL CHECK ALL DIMENSIONS AND ALL EXISTING CONDITIONS BEFORE COMMENCING CONSTRUCTION. |
| G3 | ANY DAMAGE CAUSED BY THE CONTRACTOR SHALL BE MADE GOOD AT THEIR OWN COST. |
| G4 | ALL MATERIALS AND WORKMANSHIP SHALL BE IN ACCORDANCE WITH THE CURRENT EDITIONS OF THE FOLLOWING AUSTRALIAN STANDARDS, EXCEPT WHERE VARIED BY THE SPECIFICATIONS AND/OR DRAWINGS: – AS 1684.2 (2010) RESIDENTIAL TIMBER FRAMED CONSTRUCTION AS 1720.1 (2010) TIMBER STRUCTURES AS 2870 (2011) RESIDENTIAL SLABS AND FOOTINGS AS 3600 (2009) CONCRETE STRUCTURES AS 3798 (2007) GUIDELINES ON EARTHWORKS FOR COMMERCIAL AND RESIDENTIAL DEVELOPMENTS AS 4100 (1998) STEEL STRUCTURES |
| G5 | DIMENSIONS SHALL NOT BE OBTAINED BY SCALING THE STRUCTURAL DRAWINGS. |
| G6 | ALL DIMENSIONS ARE IN MILLIMETRES UNLESS NOTED OTHERWISE U.N.O. |
| G7 | U.N.O. DENOTES UNLESS NOTED OTHERWISE. |
| G8 | THE CONTRACTOR SHALL VISIT THE SITE PRIOR TO TENDERING TO FAMILIARISE THEMSELVES WITH ACCESS SITE CONDITIONS |
| G9 | THE CONTRACTOR MAY OFFER FOR CONSIDERATION ALTERNATIVE PROVEN EQUAL PRODUCTS TO THOSE INDICATED. ALTERNATIVE PRODUCTS ARE NOT TO ADVERSELY AFFECT THE PROJECT AND CANNOT BE SUBSTITUTED WITHOUT PRIOR APPROVAL. |
| G10 | EXISTING SERVICES TO BE LOCATED BEFORE CONSTRUCTION COMMENCES. |
| G11 | THIS DRAWING IS TO BE READ IN CONJUNCTION WITH SHEET 2 TO 4. |
| G12 | CONSULT BCC ARCHITECT FOR COLOUR SCHEME OF THE STRUCTURE. |
| G13 | LIGHTNING PROTECTION AS PER BSD–10133. |

DESIGN CRITERIA:

| | |
|--|--|
| WIND LOADS | : REGION B TERRAIN CATEGORY 1.5 |
| ULTIMATE WIND SPEED | = 54.0 m/s |
| SHELTER IS DESIGNED FOR THE CONDITION | "EMPTY UNDER" ACCORDING TO AS 1170.2 (2011) |
| DESIGN LIFE | : 50 YEARS WITH ROUTINE MAINTENANCE. |
| LIVE LOADS: | : FLOOR = 5.0 kPa. ROOF = 0.25 kPa / 1.4 kN. |
| STRUCTURE IS DESIGNED TO REMAIN OPEN – NO SCREENS | (IMPERMEABLE OR PERMEABLE BARRIERS) TO BE INSTALLED. |
| TERRAIN CATEGORY 1.5 CORRESPONDS TO AN ENVIRONMENT WITH OPEN WATER SURFACES, SUBJECTED TO SHOALING WAVES AT SERVICEABILITY AND ULTIMATE WIND SPEEDS IN ALL WIND REGIONS. | |

FOUNDATIONS AND SLAB ON GROUND:

| | |
|----|---|
| F1 | ALL FOOTINGS ARE TO BE FOUNDED IN THE NATURAL UNDISTURBED SOIL PROFILE WITH A MINIMUM ALLOWABLE SOIL BEARING CAPACITY OF 100kPa UNLESS NOTED OTHERWISE. IF SITE CONDITION IS DIFFERENT, CONSULT A STRUCTURAL ENGINEER |
| F2 | SOIL TEST IS REQUIRED TO CONFIRM BEARING CAPACITY AND SITE CLASSIFICATION TO AS 2870. |
| F3 | FOUNDATIONS ARE TO BE CHECKED AND CERTIFIED BY A REGISTERED PROFESSIONAL GEOTECHNICAL ENGINEER, QUEENSLAND (RPEQ). |
| F4 | COMPACT AND PREPARE THE BASE TO PROVIDE A SOUND PLATFORM AND ANY ORGANIC, SOFT OR LOOSE MATERIALS REMOVED AND REPLACED WITH COMPACTED FILL – BCC SPECIFICATION S300 QUARRY PRODUCTS CLASS I MATERIAL. |
| F5 | THE BOTTOMS OF ALL FOOTINGS ARE TO BE CLEANED OF ALL LOOSE MATERIAL AND WATER PRIOR TO POURING CONCRETE. |
| F6 | SLABS ON GRADE SHALL BE UNDERLAIN WITH CONTINUOUS LAYER OF 200 MICRON (0.2mm) THICK POLYETHYLENE DAMPPROOF MEMBRANE AS PER AS 2870, LAPPED AND TAPED TO MANUFACTURER’S SPECIFICATION. |

EARTHWORKS:

| | |
|----|---|
| E1 | STRIP ALL HUMUS MATERIAL FROM THE AREA OF THE BUILDING IMPRINT AND 1000 BEYOND. |
| E2 | PROOF ROLL THE AREAS TO BE CONCRETED AND PAVED. REMOVE ANY WEAK MATERIAL. |
| E3 | USE NON–HUMUS CUT MATERIAL OR IMPORTED APPROVED NON–REACTIVE SOIL AS FILL. |
| E4 | COMPACTED FILL SHALL BE COMPACTED IN LAYERS NOT EXCEEDING 150mm LOOSE DEPTH TO 98% MAXIMUM DRY DENSITY IN ACCORDANCE WITH AS 1289. 5.1.1 (STANDARD COMPACTION). CARRY OUT DENSITY TESTS AT A RATE OF 2 PER LEVEL OF FILL. EVERY TEST MUST PASS. |

TIMBER NOTES:


| | |
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| T1 | ALL WORKMANSHIP AND MATERIAL SHALL BE IN ACCORDANCE WITH AS 1720 AND AS 1684. |
| T2 | TIMBER GRADES SHALL BE AS SHOWN ON THE DRAWINGS. ALL TIMBER TO BE SEASONED HARD WOOD, NATURAL DURABILITY CLASS 1 (ABOVE GROUND) WITH SAPWOOD REMOVED OR SAPWOOD PRESERVATIVE – TREATED TO H3. IN ACCORDANCE WITH AS1684.2 APPENDIX B. |
| T3 | ALL FASTENERS SHALL BE HOT DIP GALVANISED. BOLTS TO BE METRIC HEX–HEAD M16 MINIMUM WITH WASHERS U.N.O. CLEAT PLATES TO BE 10mm THICK U.N.O. IN MARINE ENVIRONMENT, ALL FASTENERS, CLEATS, STEEL MEMBERS, NAILS, AND BOLTS SHALL BE STAINLESS STEEL GR. 316 U.N.O. THE MARINE ENVIRONMENT EXTENDS 1km FROM FORESHORE. |
| T4 | TIMBER JOINT GROUP JD2 OR BETTER. |
| T5 | ALL TIMBER SHALL BE FULLY DRESSED AND ALL EDGES, ENDS AND CORNERS TO BE 6mm DRESSED. |
| T6 | PROTECT ENDS OF EXPOSED MEMBERS. USE A HIGH QUALITY EXTERIOR PAINT FINISH. |
| T7 | ALL TIMBER FRAMING SHALL BE NATURALLY TERMITE RESISTANT, NO TIMBER IS IN CONTACT WITH THE GROUND, |
| T8 | ALL TIMBER TO BE PAINTED PRIOR TO FIXING INTO FINAL POSITION. REFER TO PROJECT SPECIFICATION. |
| T9 | WASHER SIZES TO BE: M10 – 45 DIA. M12 – 55 DIA. M16 – 65 DIA. |

CONCRETE NOTES:

| | |
|-----|--|
| C1 | ALL WORKMANSHIP AND MATERIAL SHALL BE IN ACCORDANCE WITH AS 3600. |
| C2 | ALL CONCRETE SHALL BE PREMIXED BY AN APPROVED SUPPLIER. |
| C3 | ALL CEMENT SHALL BE TYPE GP OR GB. |
| C4 | CONCRETE SPECIFICATION: NOMINAL AGGREGATE SIZE TO BE 20mm, SLUMP TO BE NOT GREATER THAN 80mm. |
| C5 | CONCRETE STRENGTH AND CLEAR CONCRETE COVER TO REINFORCEMENT SHALL BE IN ACCORDANCE WITH THE FOLLOWING TABLE U.N.O. ELEMENT: F’C (MPa) REINFORCEMENT COVER PIERS 32 75 SLAB 32 CENTRALLY PLACED. |
| C6 | ALL LAPS IN REINFORCEMENT SHALL BE AS SHOWN IN THE TABLE BELOW UNLESS NOTED OTHERWISE. BAR LAP LENGTH (mm) N12 500 N16 650 MESH 350 |
| C7 | REINFORCEMENT SYMBOLS: R STRUCTURAL PLAIN ROUND GRADE 250R TO AS 4671. N DEFORMED BAR GRADE D500N TO AS 4671. SL HARD DRAWN STEEL REINFORCING FABRIC GRADE D500L TO AS 4671. |
| C8 | SIZES OF CONCRETE ELEMENTS DO NOT INCLUDE THICKNESS OF APPLIED FINISHES. |
| C9 | NO HOLES, CHASES OR EMBEDMENT OF PIPES OTHER THAN THOSE SHOWN ON THE STRUCTURAL DRAWINGS SHALL BE MADE IN CONCRETE MEMBERS WITHOUT PRIOR APPROVAL BY THE SUPERINTENDENT. |
| C10 | ALL CONCRETE SHALL BE COMPACTED USING A MECHANICAL VIBRATION PROCESS. |
| C11 | ALL REINFORCEMENT SHALL BE SECURELY SUPPORTED IN ITS CORRECT POSITION DURING CONCRETING BY APPROVED BAR CHAIRS, SPACERS OR SUPPORT BARS. |
| C12 | CONSTRUCTION JOINTS SHALL BE PROPERLY FORMED AND USED ONLY WHERE SHOWN OR SPECIFICALLY APPROVED BY THE SUPERINTENDENT. |

INSPECTION AND CERTIFICATION NOTES:

| | |
|----|--|
| A1 | THE CONTRACTOR’S ENGINEER (RPEQ) SHALL UNDERTAKE INSPECTIONS DURING CONSTRUCTION TO ENSURE ALL CONSTRUCTION WORKS ARE IN ACCORDANCE WITH THE MOST CURRENT ISSUE OF THE STRUCTURAL DRAWINGS AND THE CONTRACT DOCUMENT. THE RPEQ SHALL CERTIFY ALL CONSTRUCTION WORK (FORM 16). ANY ALTERNATIVE TECHNIQUE USED IN CONSTRUCTION SHALL BE FOLLOWED BY A DESIGN CERTIFICATE (FORM 15) BY THE CONTRACTOR’S PROFESSIONAL ENGINEER (RPEQ). |
|----|--|

| | | | | | | | | | | | | | | | | | | | | | | | | |
|-------|---------------------------------------|--|--|--|---------------|---------------|----------------|---|--|---|--|------|----------|--|--|--|--|--|--|--|--|--|--|--|
| E4 | | | | | | | | | | COMPACTED FILL SHALL BE COMPACTED IN LAYERS NOT EXCEEDING 150mm LOOSE DEPTH TO 98% MAXIMUM DRY DENSITY IN ACCORDANCE WITH AS 1289. 5.1.1 (STANDARD COMPACTION). CARRY OUT DENSITY TESTS AT A RATE OF 2 PER LEVEL OF FILL. EVERY TEST MUST PASS. | | | | | | | | | | | | | | |
| | | | | | | | | | | STRUCTURAL DESIGN CERTIFICATION | | | | | | | | | | | | | | |
| | | | | | | | | | | DESIGN Original signed by : L. Mendis RPEQ: 8950 – 2014.11.26 | | | | | DESIGN CHECK Original signed by : D. Bateup RPEQ: 13095 – 2014.11.26 | | | | | AUTHORISED FOR ISSUE Original signed by : B. Balakumar RPEQ: 3963 – 2014.11.27 | | | | |
| | | | | | | | | | | BRISBANE CITY COUNCIL STANDARD DRAWING | | | | | | | | | | | | | | |
| | | | | | | | | | |  | | | | | | | | | | | | | | |
| | | | | | | | | | | | | | | | | | | | | | | | | |
| C | Drawing Title Amended | | | | FEB '16 | JUL '16 | JUL '16 | DRAWING AUTHORISED FOR PUBLICATION I. CONDRIK AUTHORISED JUNE 2015 | | DESIGN | L.M. | DATE | Sept '14 | | | | | | | | | | | |
| B | NOTE G13 ADDED – LIGHTNING PROTECTION | | | | JUNE '15 | JUNE '15 | JUNE '15 | ASSET ENGINEERING MANAGER STRATEGIC ASSET MANAGEMENT | | DRAWN | G.B. | DATE | Sept '14 | | | | | | | | | | | |
| A | ORIGINAL ISSUE | | | | SEPT '14 | SEPT '14 | SEPT '14 | DESIGN APPROVED D. VAN DER WALLE APPROVED JUNE 2015 | | CHECKED | D.B. | DATE | Sept '14 | | | | | | | | | | | |
| ISSUE | AMENDMENT | | | | DRAWN DATE | CHK'D DATE | APPR'D DATE | SENIOR CO-ORDINATOR PARKS ASSET SERVICES BRANCH – FIELD SERVICES GROUP | | DRAWING FILENAME | BSD-10132 (I) Skillion Roof Shelter - Park - Structural notes (Page 1 of 2) - Sheet 1 of 5.dwg | | | | | | | | | | | | | |
| | | | | | | | | | | ASSOCIATED PLANS | BSD-10132 SHEETS 2 TO 5 | | | | | | | | | | | | | |
| | | | | | | | | | | SKILLION ROOF SHELTER–PARK STRUCTURAL NOTES (PAGE 1 OF 2) SHEET 1 OF 5 | | | | | | | | | | | | | | |
| | | | | | | | | | | SCALE NOT TO SCALE | | | | | DWG No. BSD–10132 | | | | | | | | | |
| | | | | | | | | | | ORIGINAL SIZE A3 | | | | | REVISION C | | | | | | | | | |

SKILLION ROOF PARK SHELTER

STEELWORK NOTES

- S1.

ALL WORKMANSHIP AND MATERIAL SHALL BE IN ACCORDANCE WITH AS4100 & AS/NZS 1554.
- S2.

ALL STEEL SHALL BE IN ACCORDANCE WITH AS1163 GRADE C350LO FOR RECTANGULAR AND SQUARE HOLLOW SECTIONS U.N.O
- S3.

ALL BOLTS TO BE METRIC HEXAGONAL TO AS1252 U.N.O
ALL BOLTS TO BE M16 4.6/S TO AS/NZS 1252 U.N.O
ALL BOLTS TO BE HOT DIP GALVANISED TO AS 1214
- S4.

ALL CLEATS AND GUSSETS SHALL BE 10mm PLATE TO AS/NZS 3678 GRADE 250 U.N.O
- S5.

METAL ROOF CLADDING TO BE 0.42 BMT LYSAGHT CUSTOM ORB WITH A COLORBOND FINISH OR APPROVED EQUAL FIXED AS PER MANUFACTURER’S SPECIFICATIONS. COLORBOND COLOUR AS PER PROJECT SPECIFICATION. IN MARINE ENVIRONMENT, PROVIDE COLORBOND ULTRA FINISH OR APPROVED EQUAL.
- S6.

ALL WELDS TO BE 6mm CONTINUOUS FILLET WELDS (CFW) STRUCTURAL PURPOSE (SP) WELDS U.N.O. ALL WELDS TO BE MADE USING E48XX OR W50X GRADE 1 (OR BETTER) ELECTRODES TO AS/NZS 1554. GRIND ALL CORNERS & WELDS SMOOTH.
- S7.

BOLT DIAMETERS HAVE BEEN INCREASED IN POST AND BEAM CONNECTIONS TO ALLOW FOR LONGER TERM DURABILITY.
- S8.

ALL STEELWORK TO BE HOT DIP GALVANISED IN ACCORDANCE WITH AS/NZS 2312 HDG600 SPECIFICATION. EXCEPT IN MARINE ENVIRONMENTAL ZONES. REFER TO NOTE 12. CORROSION PROTECTION COATING TO SURFACE PREPARATION OF SUBSTRATE MATERIAL IS CLASS 2½ TO AS 1627 AND PICKLED PRIOR GALVANISING. HOT DIPPED GALVANISED COATING SHALL BE IN ACCORDANCE WITH AS/NZS 4680.
- S9.

ANY POST GALVANISING DAMAGE TO BE MADE GOOD WITH HIGH QUALITY TWO PACK EPOXY ZINC RICH PAINT CONFORMING TO AS/NZS 3750.9 WITH A MINIMUM DRY FILM THICKNESS OF 100 MICRONS. SURFACE PREPARATION TO BE ACCORDING TO PAINT MANUFACTURER’S RECOMMENDATIONS
- S10.

THE ENDS OF ALL TUBULAR OR HOLLOW MEMBERS ARE TO BE SEALED WITH 5mm THICK PLATES AND CONTINUOUS FILLET WELDED U.N.O.
- S11.

PROTECTIVE COATINGS TO BE APPLIED AFTER ALL FABRICATION COMPLETED. NO WELDING ETC TO BE CARRIED OUT DURING OR AFTER APPLICATION OF COATING SYSTEM.
- S12.

THE PRINCIPAL CONTRACTOR SHALL CONFER WITH THE FABRICATOR AND GALVANISER TO ENSURE VENT HOLES ARE PROVIDED IN ACCORDANCE WITH AS/NZS 4680.
- S13.


FOR MARINE ENVIRONMENTAL ZONES (WITHIN 1km OF THE SHORELINE), ALL STEEL MEMBERS, FASTENERS, INCLUDING BOLTS, NUTS, AND CLEATS SHALL BE STAINLESS STEEL. PLASTIC SEPARATORS SHALL BE PROVIDED TO AVOID CONTACT BETWEEN DISSIMILAR MATERIALS. STAINLESS STEEL GRADE 316 TO BE USED. BOLTS TO BE GRADE 316 (A4–CLASS 50). REFER TO STAINLESS STEEL NOTES.
- S14.


CO–ORDINATE WITH LIGHTNING PROTECTION DETAILS – REFER TO BSD–10133.

| MEMBER | DESCRIPTION | MINIMUM SIZE | GRADE | SPACING | COMMENTS |
|--------|--------------------------------|---|-----------|--------------------------------------|--|
| C1 | POST | 120x120 HWD | F17 | AS SHOWN | 2/M16 BOLTS PER CONNECTION |
| B1 | BEAM No 1. | 170x45 HWD | F17 | AS SHOWN | 2/M16 BOLTS PER CONNECTION |
| B2 | BEAM No 2. | 190x45 HWD | F17 | AS SHOWN | 2/M16 BOLTS PER CONNECTION |
| R1 | RAFTER | 190x45 HWD | F17 | AS SHOWN | 2/M16 BOLTS PER CONNECTION TO C1 |
| S1 | STRUT | 90x90 HWD | F17 | AS SHOWN | 1/M10 BOLTS PER CONNECTION TO C1 |
| P1 | ROOF PURLIN | 140x45 HWD | F17 | 900 END SPANS 1200 INTERNAL SPANS | CONNECTIONS TO EACH RAFTER VIA 125x75x6 UA ANGLE BRACKET–50mm LONG, WITH 2/M10 BOLTS THROUGH THE PURLIN & 1/M10 x 70 COACH SCREW INTO THE RAFTER |
| RB | ROOF BRACING TO TOP OF RAFTERS | 2/30x1.0 GALV. IRON STRAPPING WITH TENSIONER OR 'PRYDA' 2–25x1.0 S.S. OR APPROVED EQUAL | | | 5/3.15ø x 35mm NAILS AT EACH END FIXED TO SIDES OF RAFTERS AND 1 NAIL TO TOP OF EACH PURLIN |
| F1 | PIER FOOTING FOR MAIN COL. | 450ø x 750 DEEP | N32 CONC. | AS SHOWN | STIRRUP TO BE EMBEDDED AS SHOWN |
| F2 | PIER FOOTING FOR BRACING PANEL | 450ø x 600 DEEP | N32 CONC. | AS SHOWN | STIRRUP TO BE EMBEDDED AS SHOWN |

STAINLESS STEEL:

1. BEFORE FABRICATION SUBMIT COPIES OF SHOP DRAWINGS FOR REVIEW. REVIEW DOES NOT INCLUDE DIMENSION CHECKING.
2. STAINLESS STEEL MATERIAL SHALL NOT BE STORED WITH CARBON STEEL.
3. TOOLS USED FOR CARBON STEEL SHALL NOT BE USED TO FABRICATE OR ASSEMBLE STAINLESS STEEL COMPONENTS.
4. THE STAINLESS STEEL SHALL BE WRAPPED OR OTHERWISE PROTECTED DURING TRANSPORT TO AVOID CONTAMINATION BY FERROUS PRODUCTS.
5. WELDING SHALL BE IN ACCORDANCE WITH AS1554.6.
6. LIMIT THE INPUT OF HEAT INTO THE WELD. THE WELD SHALL NOT BE PREHEATED, POST–HEATED OR STRESS RELIEVED. GRADE 316L ELECTRODES SHALL BE USED FOR 316L.
7. WELDS SHALL BE CATEGORY 2B IN ACCORDANCE WITH AS1554.6.
8. SURFACE FINISHES OF WELDS SHALL BE GRADE 1, POLISHED USING 320 GRIT OR FINER, SILICONE CARBIDE ABRASIVES WITH LUBRICATION. AFTER POLISHING, WELDS SHALL BE PASSIVATED USING NITRIC ACID IN ACCORDANCE WITH ASTM A380.
9. ALL STAINLESS STEEL COMPONENTS SHALL HAVE A Ra<0.5µm AND PASSIVATED USING NITRIC ACID IN ACCORDANCE WITH ASTM A380.
10. CHEMICAL ANCHORS AND BOLTS TO BE GRADE 316 STAINLESS STEEL A4–50 MINIMUM.





| STRUCTURAL DESIGN CERTIFICATION | | | | | | | | | | | |
|--|---------------------------------------|---------------|---------------|----------------|--|---------------------|--|--|----------|---|--|
| DESIGN Original signed by : L. Mendis RPEQ: 8950 – 2014.11.26 | | | | | DESIGN CHECK Original signed by : D. Bateup RPEQ: 13095 – 2014.11.26 | | | AUTHORISED FOR ISSUE Original signed by : B. Balakumar RPEQ: 3963 – 2014.11.27 | | | |
| | | | | | DRAWING AUTHORISED FOR PUBLICATION I. CONDRIK AUTHORISED JUNE 2015 | DESIGN | L.M. | DATE | Sept '14 |  | |
| | | | | | ASSET ENGINEERING MANAGER STRATEGIC ASSET MANAGEMENT | DRAWN | G.B. | DATE | Sept '14 | | |
| C | Drawing Title Amended | FEB '16 | JUL '16 | JUL '16 | DESIGN APPROVED D. VAN DER WALLE APPROVED JUNE 2015 | CHECKED | D.B. | DATE | Sept '14 | | |
| B | NOTE S14 ADDED – LIGHTNING PROTECTION | JUNE '15 | JUNE '15 | JUNE '15 | | DRAWING FILENAME | BSD-10132 (C) Skillion Roof Shelter - Park - Structural notes (Page 2 of 2) - Sheet 2 of 5.dwg | | | | |
| A | ORIGINAL ISSUE | SEPT '14 | SEPT '14 | SEPT '14 | | ASSOCIATED PLANS | BSD-10132 SHEETS 1, 3, 4 AND 5 | | | | |
| ISSUE | AMENDMENT | DRAWN DATE | CHK'D DATE | APPR'D DATE | SENIOR CO-ORDINATOR PARKS ASSET SERVICES BRANCH – FIELD SERVICES GROUP | | | | | | |
| BRISBANE CITY COUNCIL STANDARD DRAWING | | | | | | | | | | | |
| SKILLION ROOF SHELTER–PARK STRUCTURAL NOTES (PAGE 2 OF 2) SHEET 2 OF 5 | | | | | | | | SCALE NOT TO SCALE | | BSD–10132 | |
| | | | | | | | | DWG No. | | | |
| | | | | | | | | ORIGINAL SIZE | | REVISION | |
| A3 | | C | | | | | | | | | |

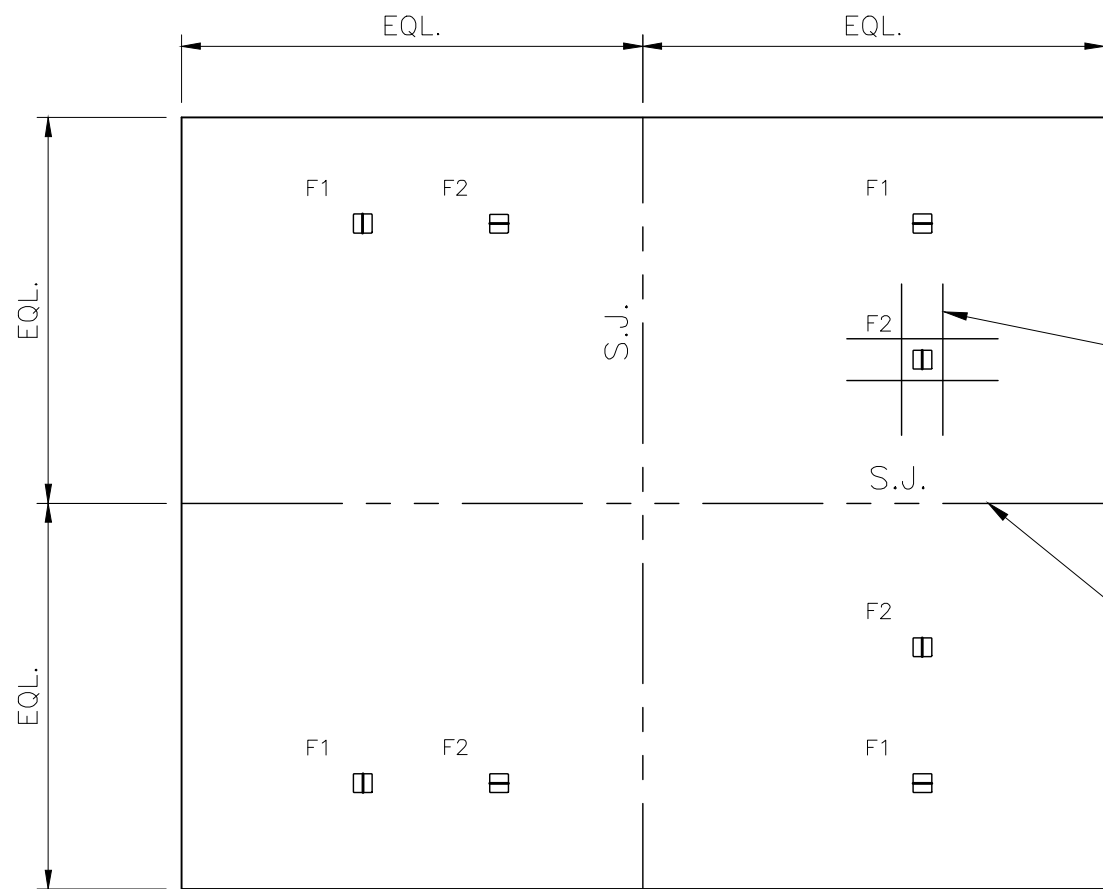

- NOTES:**
1. ALLOWABLE BEARING CAPACITY OF SOIL 100 kPa MIN. IF SITE CONDITION IS DIFFERENT, CONSULT A STRUCTURAL ENGINEER.
 2. THIS DRAWING IS TO BE READ IN CONJUNCTION WITH SHEETS 1, 2, 3 AND 4.
 3. REFER TO BSD-10133 FOR LIGHTNING PROTECTION DETAILS.

PROVIDE N12 TRIMMERS x 1000 LONG CENTRALLY PLACED AT EACH STIRRUP LOCATION





REFER TO DRAWING BSD-5206 FOR SAWN JOINT (S.J.) DETAIL

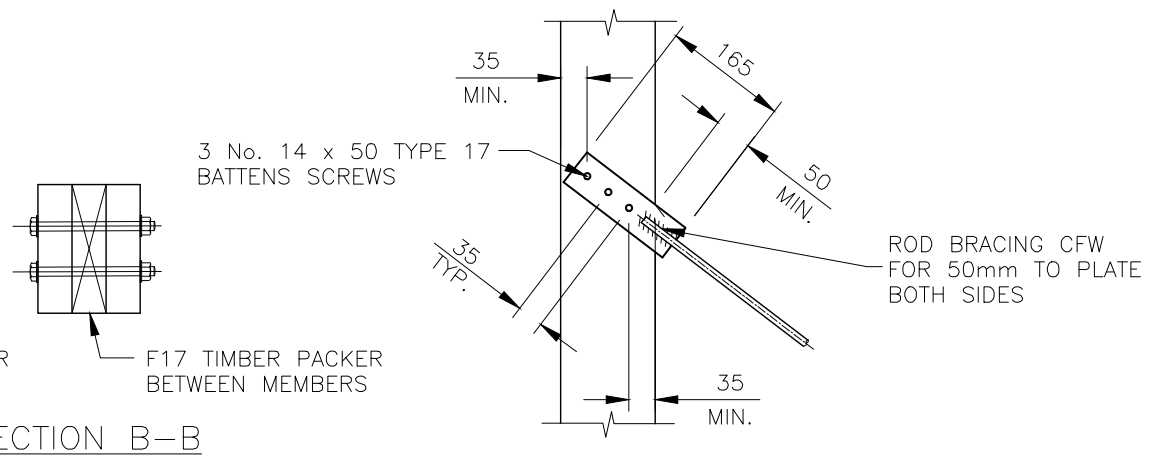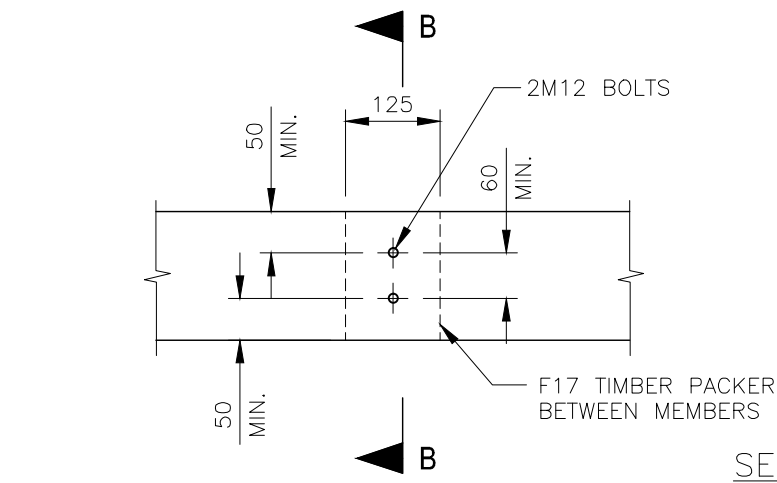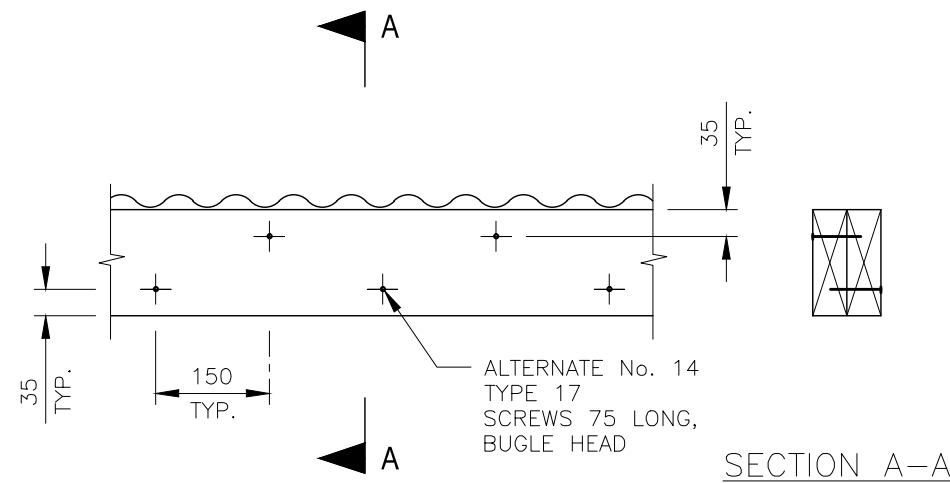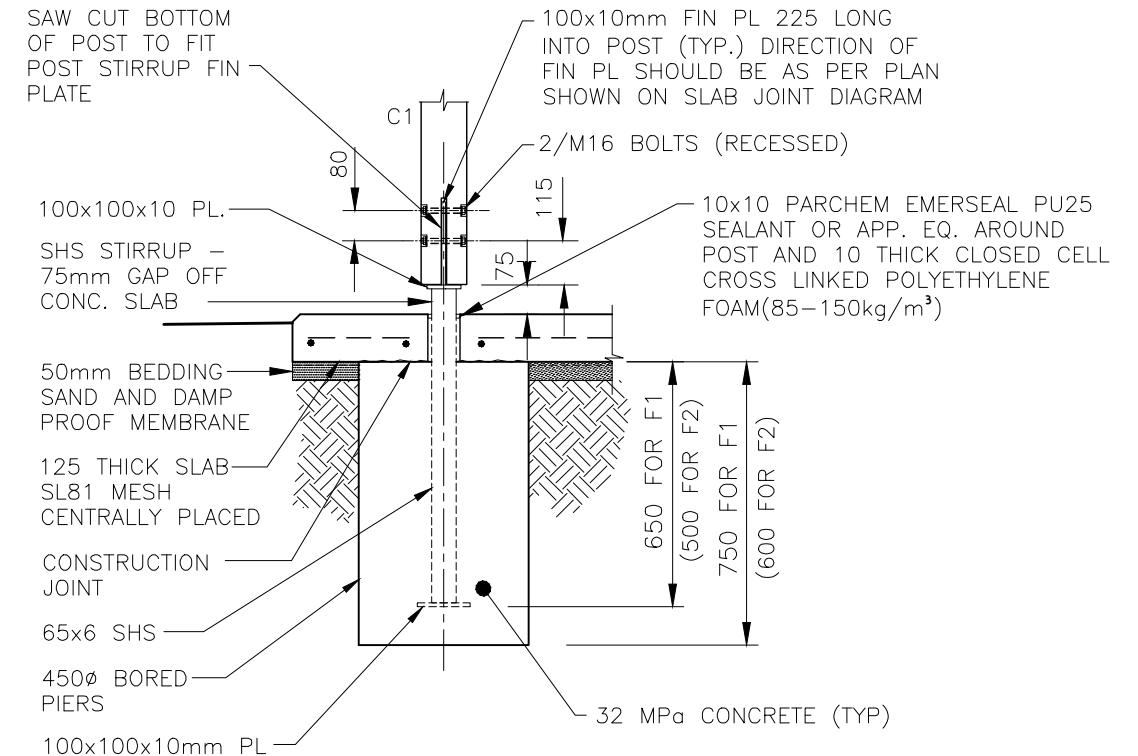


| STRUCTURAL DESIGN CERTIFICATION | | | |
|---|--|--|------------|
| DESIGN Original signed by : L. Mendis RPEQ: 8950 – 2014.11.26 | | DESIGN CHECK Original signed by : D. Bateup RPEQ: 13095 – 2014.11.26 | |
| | | AUTHORISED FOR ISSUE Original signed by : B. Balakumar RPEQ: 3963 – 2014.11.27 | |
| BRISBANE CITY COUNCIL STANDARD DRAWING | | | |
| SKILLION ROOF SHELTER—PARK DETAILS SHEET 5 OF 5 | | SCALE 1:20, 1:10 | |
| | | DWG No. BSD—10132 | |
| | | ORIGINAL SIZE A3 | REVISION C |

| | | | | | |
|---|--|--|--|---|------------------|
| DRAWING AUTHORISED FOR PUBLICATION I. CONDRIK AUTHORISED JUNE 2015 | | | | DESIGN L.M. | DATE Sept '14 |
| ASSET ENGINEERING MANAGER STRATEGIC ASSET MANAGEMENT | | | | DRAWN G.B. | DATE Sept '14 |
| DESIGN APPROVED D. VAN DER WALLE APPROVED JUNE 2015 | | | | CHECKED D.B. | DATE Sept '14 |
| SENIOR CO-ORDINATOR PARKS ASSET SERVICES BRANCH - FIELD SERVICES GROUP | | | | DRAWING FILENAME BSD-10132 (C) Skillion Roof Shelter - Park - Details - Sheet 5 of 5.dwg | |
| | | | | ASSOCIATED PLANS BSD-10132 SHEETS 1, 2, 3 AND 4 | |



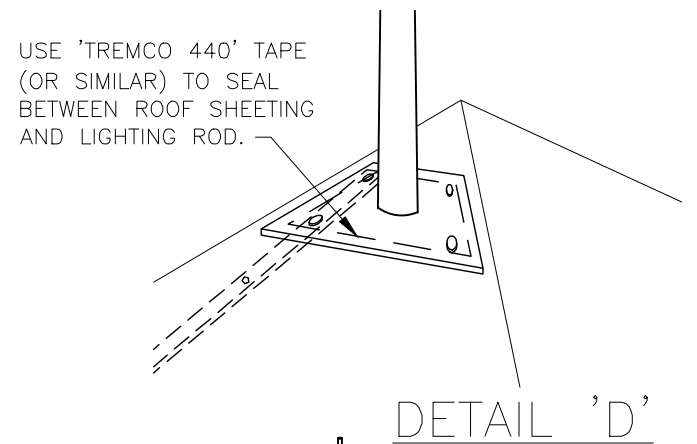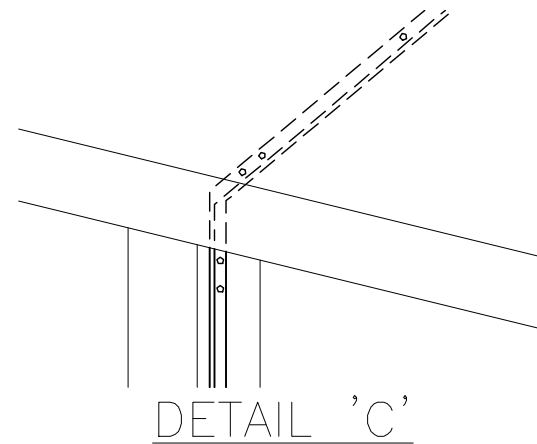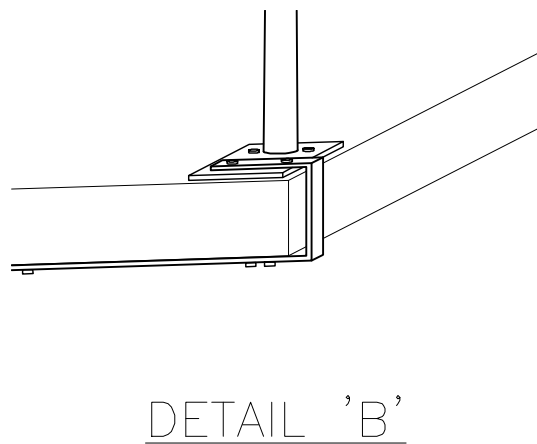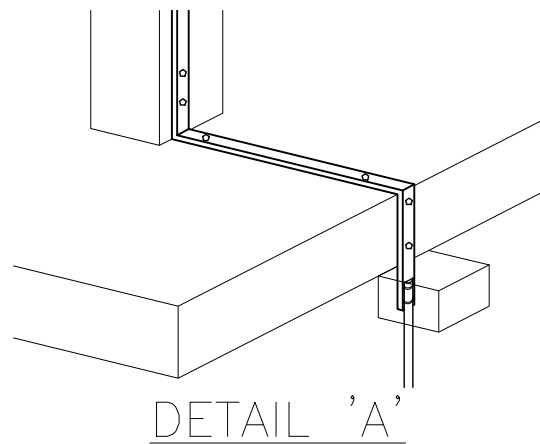

USE 'TREMCO 440' TAPE
(OR SIMILAR) TO SEAL
BETWEEN ROOF SHEETING
AND LIGHTING ROD.

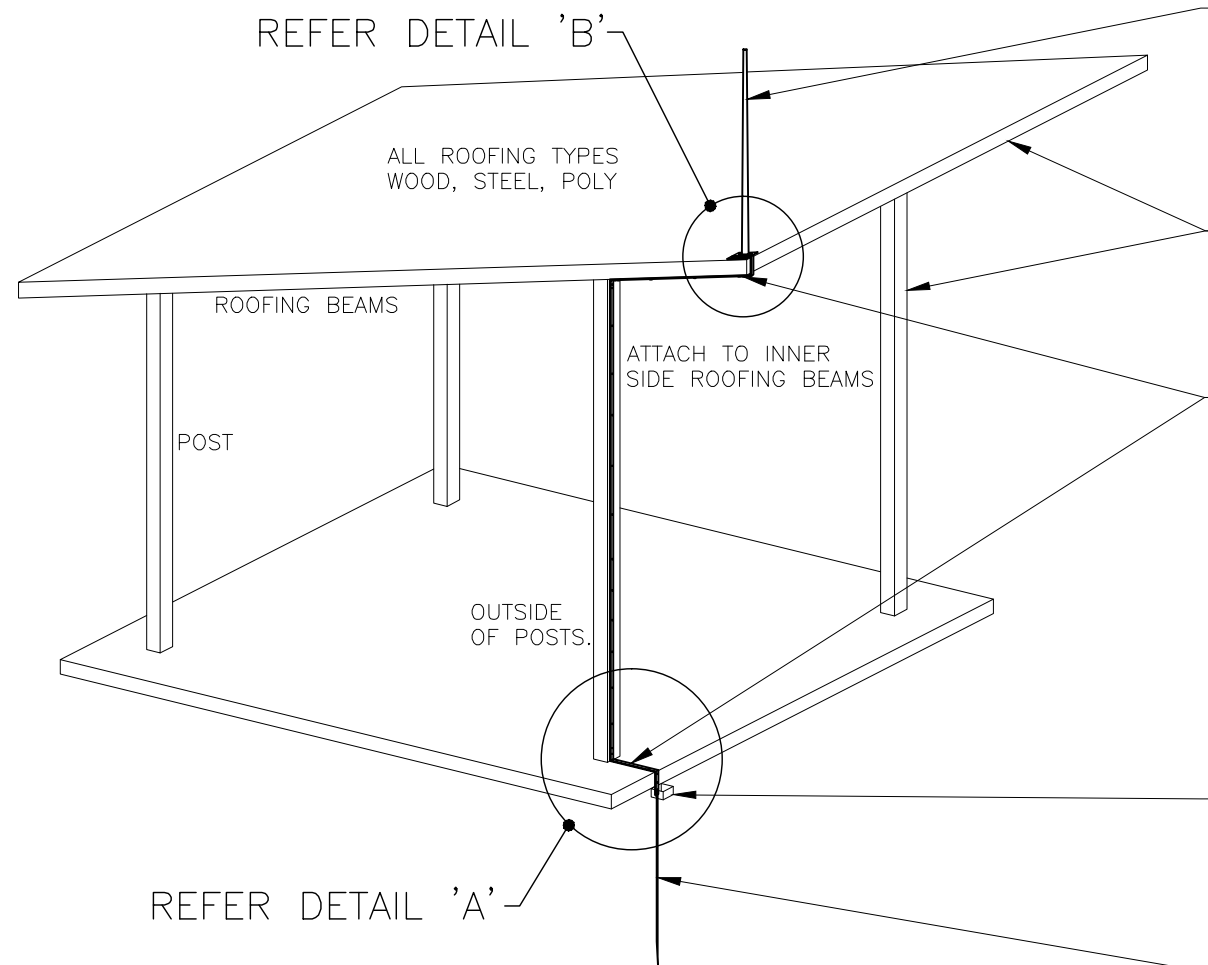

TYPICAL SMALL STRUCTURE
SLOPING FLAT OR CURVED ROOF

EARTH AIR ROD.
LOCATE NEAR HIGHEST POINT OF STRUCTURE. APPROX. 1.0m
LONG Ø15mm ALUMINIUM/STAINLESS STEEL ROD WITH ROOF
MOUNTING PLATE. SECURELY MOUNT TO STRUCTURAL BEAM.
WEATHER SEAL ALL ROOF PENETRATIONS WITH 25 YEAR
GUARANTEE SILASTIC TYPE MATERIAL.


STRUCTURES WITH STEEL FRAMES/POSTS TO INCLUDE USE
OF PENETRATING LOCKING WASHERS TO BRIDGE ANY NON
CONDUCTIVE COVERING/PAINT MATERIALS AND PROVIDE
ELECTRICAL CONTINUITY.

EARTH DOWN CONDUCTOR – ALUMINIUM/STAINLESS STEEL
10mm WIDE x 5mm THICK BAR (PREFERRED AS REDUCED
TRIP ISSUES AT SLAB LEVEL) OR 12mm CABLE.
SECURELY ATTACHED TO SIDE OF RAFTERS AND POST, AT
APPROX. 300mm INTERVALS.
USE SELF TAPING/SCREWING SCREWS (CABLE SADDLES)
INTO BEAMS AND POSTS OF SUITABLE LENGTH TO PROVIDE
ROBUST CONNECTION (PENETRATION INTO STRUCTURAL
ELEMENTS – 10mm STEEL, 20mm WOOD).
DOUBLY SECURE AT CORNERS AND BENDS.

SMALL EARTH PIT – POLY/PVC (INSPECTION TEST POINT)
200mm x 200mm x200mm DEEP.
MECHANICALLY SECURED LID (MIN. 2 CORNERS) WITH S/S
CORNER LOCKING SCREWS.

DRIVEN EARTH STAKE.
STAINLESS STEEL Ø15mm BAR x 3.0m LONG TO
PROVIDED REQUIRED MIN 10 OHM EARTH CONDUCTIVITY.

REFER DETAIL 'C'

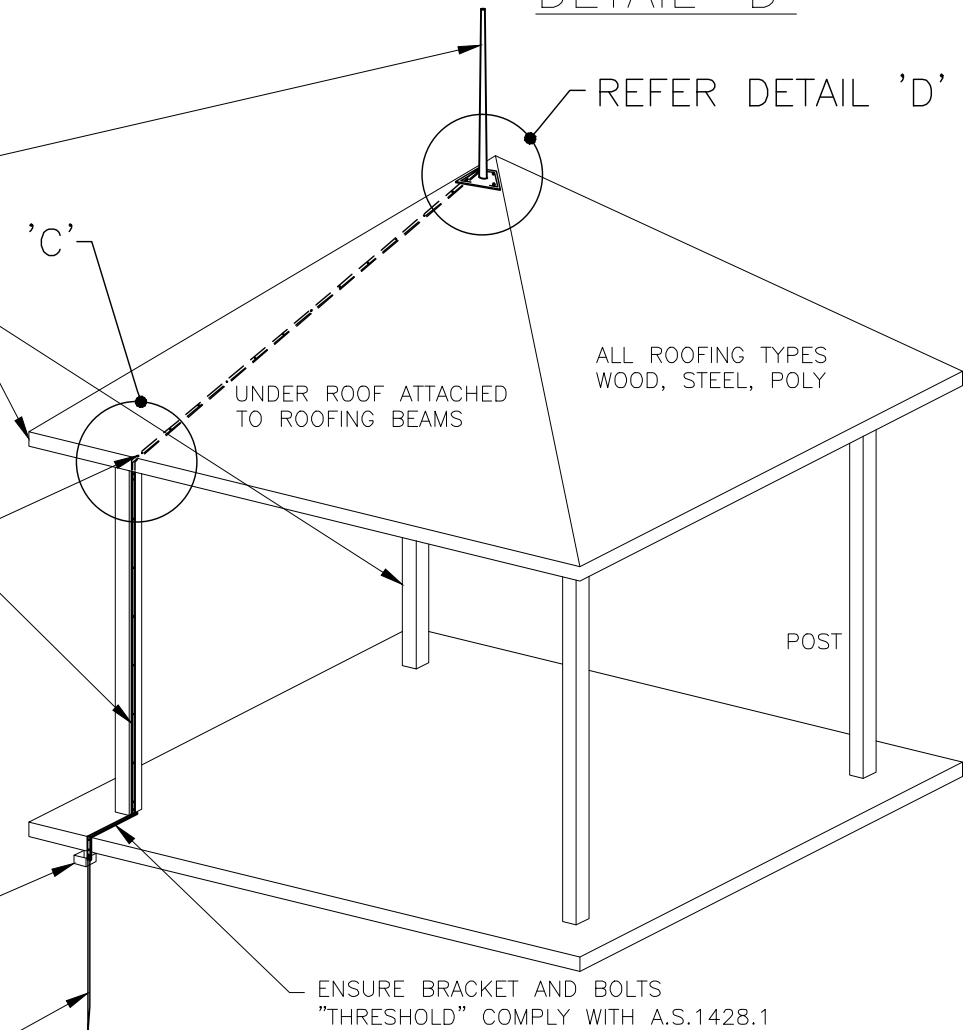

TYPICAL SMALL STRUCTURE
PEAKED ROOF

ALL ROOFING TYPES
WOOD, STEEL, POLY

POST

ENSURE BRACKET AND BOLTS
"THRESHOLD" COMPLY WITH A.S.1428.1

NOTE:

HYBRID SYSTEM ONLY AS1768–2007 LIGHTNING PROTECTION STANDARDS
DO NOT REQUIRE PROTECTION TO SMALL STRUCTURES.
ALL COMPONENTS TO BE COMPLIANT WITH AS1768–2007 LIGHTNING
PROTECTION STANDARDS.
ON STRUCTURES WITH STEEL FRAMES/POSTS ENSURE ELECTRICAL
CONTINUITY AT ALL STRUCTURAL JOINTS BY USE OF PENETRATING LOCKING
WASHERS TO BRIDGE ALL NON CONDUCTIVE COVERING/PAINT MATERIALS.


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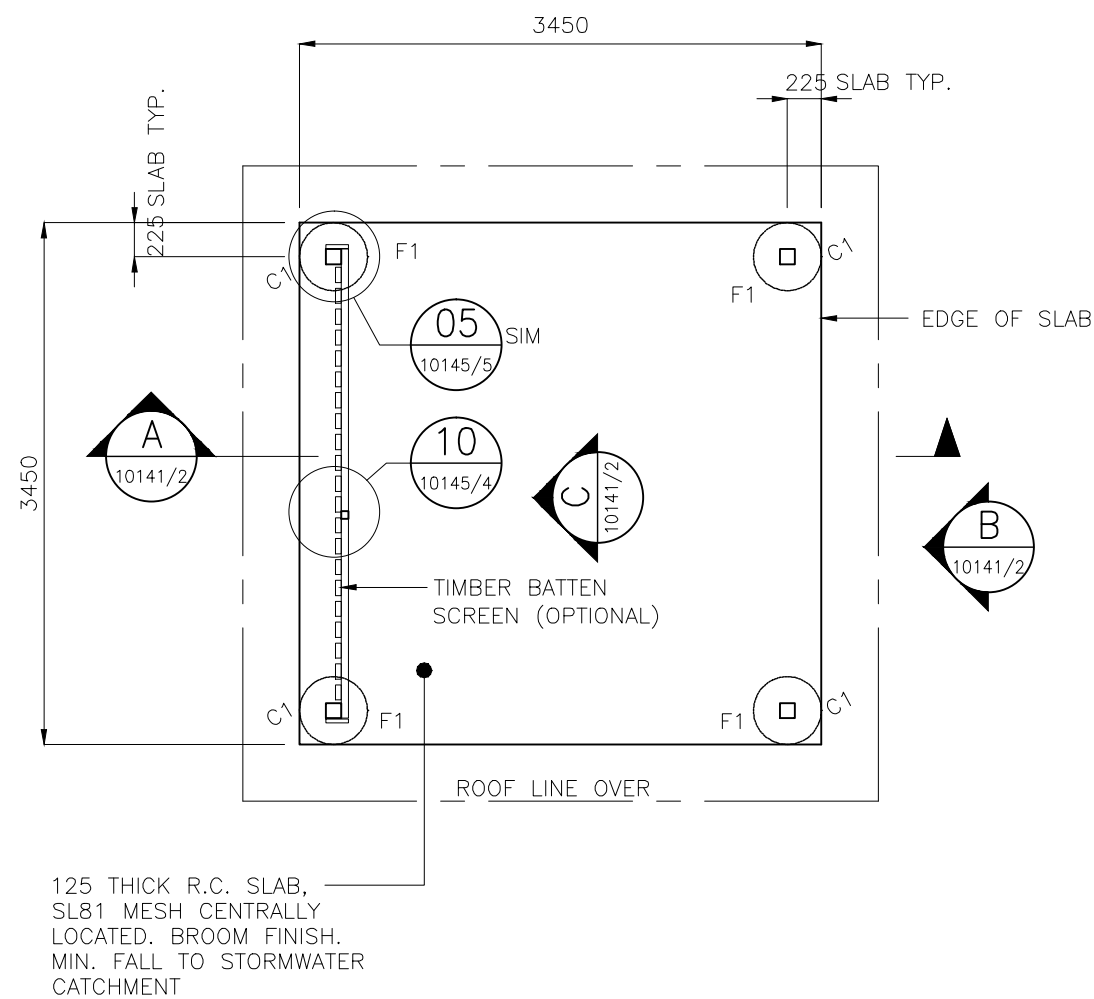
STEELWORK PAINTED TO MATCH EXISTING
SHELTER'S COLOUR SCHEME.

BOQ – TYPICAL COMPONENT LIST – (TERCEL OR THOMPSON LIGHTING SYSTEMS)
STAINLESS STEEL/ALUMINIUM SYSTEM (REDUCE RISK OF COPPER THEFT)


| DESC | QTY |
|--------------------------|-----|
| AIR ROD WITH BASE | 1 |
| GROUNDING DOWN CONDUCTOR | 9m |
| EARTH PIT/WELL | 1 |
| GROUNDING ROD CLAMP | 1 |
| GROUNDING ROD | 1 |

(LENGTH AS REQUIRED BY SOIL TYPE PROVIDE 100HMS OR LESS EARTH RESISTANCE)

| | | | | | | | | | | | | | | | |
|-------|-----------------------|------------|------------|-------------|---|--|------------------|--|------|---------|---|--|----------|--------------------|-----------|
| | | | | | DRAWING AUTHORISED FOR PUBLICATION | | DESIGN | J.K. | DATE | May '15 |  | BRISBANE CITY COUNCIL STANDARD DRAWING | | | |
| | | | | | Inga Condric 2015.06.30 11:33:31+10'00' | | DRAWN | J.K. | DATE | May '15 | | ROOF SHELTER – PARK HYBRID LIGHTNING PROTECTION SYSTEM | | SCALE NOT TO SCALE | |
| | | | | | ASSET ENGINEERING MANAGER STRATEGIC ASSET MANAGEMENT | | CHECKED | J.K. | DATE | May '15 | | | | DWG No. | BSD–10133 |
| B | Drawing Title Amended | FEB '16 | JUL '16 | JUL '16 | DESIGN APPROVED | | DRAWING FILENAME | BSD-10133 (B) Roof Shelter - Park - Hybrid Lightning Protection System.dwg | | | | ORIGINAL SIZE | REVISION | | |
| A | ORIGINAL ISSUE | JUN '15 | JUN '15 | JUN '15 | D. VAN DER WALLE APPROVED JUNE 2015 | | | | | | | A3 | B | | |
| ISSUE | AMENDMENT | DRAWN DATE | CHK'D DATE | APPR'D DATE | SENIOR CO-ORDINATOR PARKS ASSET SERVICES BRANCH - FIELD SERVICES GROUP | | ASSOCIATED PLANS | | | | | | | | |



SLAB AND FOOTING PLAN
SCALE 1:50

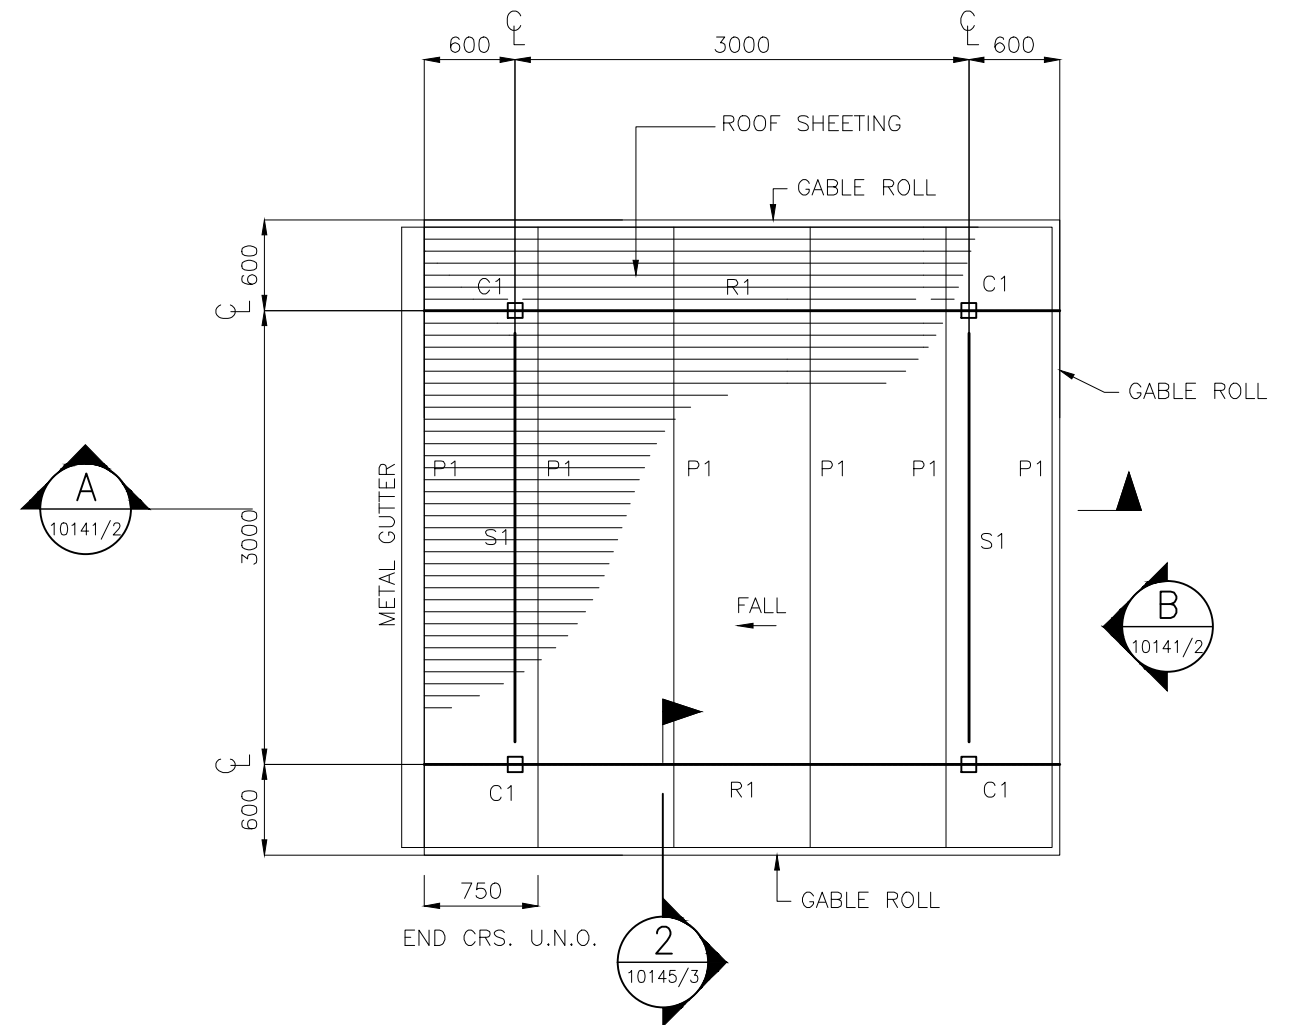


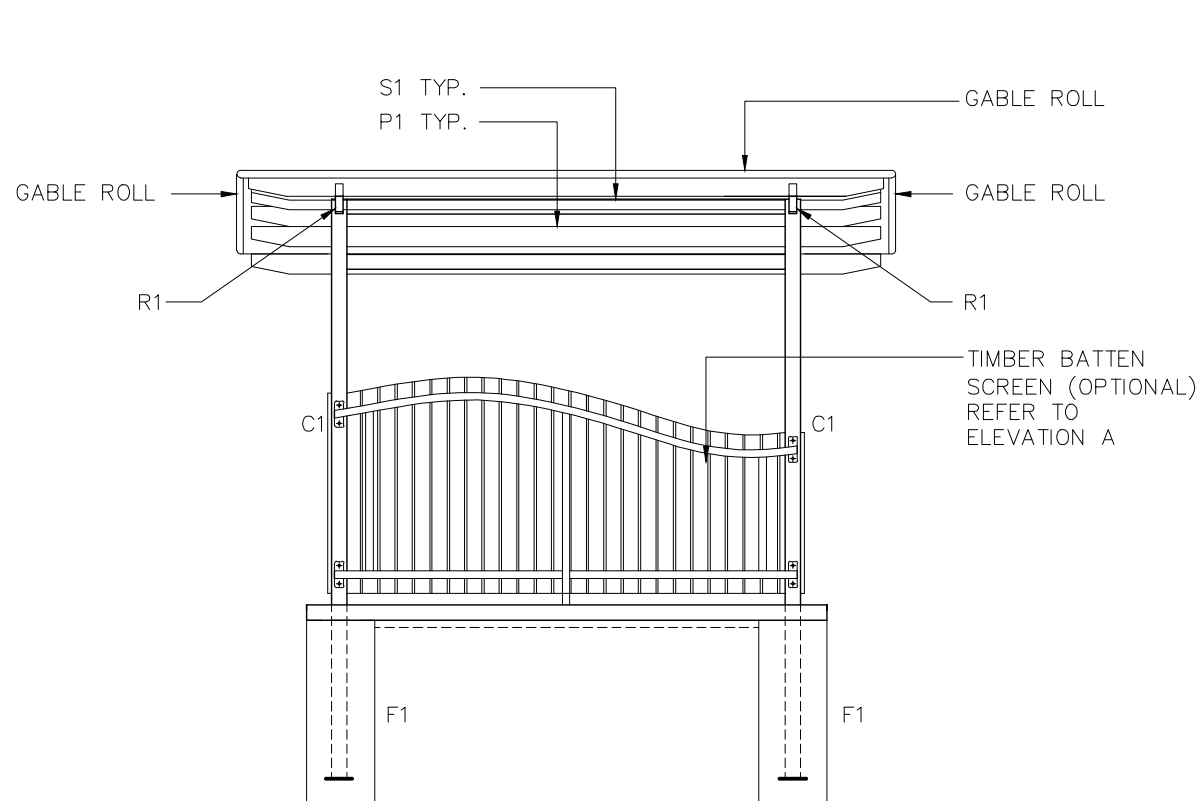
ROOF FRAMING PLAN
SCALE 1:50

GENERAL NOTES


1. REFER TO BSD-10145 SHEET 1 AND 2 FOR STRUCTURAL NOTES AND STEEL MEMBER SCHEDULE
2. REFER TO BSD-10145 SHEET 3 FOR TYPICAL FOOTING AND SLAB DETAILS.
3. REFER TO BSD-10145 SHEET 4 & 5 FOR SCREEN DETAILS IF SCREEN IS SPECIFIED FOR SHELTER.
4. (U) DENOTES UNDER

| STRUCTURAL DESIGN CERTIFICATION | | |
|---|---|--|
| DESIGN | DESIGN CHECK | AUTHORISED FOR ISSUE |
| Zhuangzhi Hu RPEQ:13885 2014.11.26 15:32:11+10'00' | D.Bateup RPEQ:13095 2014.11.27 08:32:11 +10'00' | Bala Balakumar RPEQ 3963 2014.11.27 08:32:11 +10'00' |
| BRISBANE CITY COUNCIL STANDARD DRAWING | | |
| SMALL SHELTER NATURAL AREA – PLAN SHEET 1 OF 2 | | SCALE AS SHOWN |
| | | DWG No. BSD-10141 |
| | | ORIGINAL SIZE A3 REVISION B |


| | | | | | | | | | | |
|-------|-----------------------|---------------|---------------|----------------|---|---------------------|--|------|---------|---|
| | | | | | DRAWING AUTHORISED FOR PUBLICATION | DESIGN | CP0 – P&D | DATE | NOV '14 |  |
| | | | | | Inga Condric 2015.06.04 14:47:44+10'00' for ASSET ENGINEERING MANAGER STRATEGIC ASSET MANAGEMENT | DRAWN | CP0 – P&D | DATE | NOV '14 | |
| | | | | | DESIGN APPROVED | CHECKED | BI – FSG – AS | DATE | NOV '14 | |
| B | Drawing Title Amended | FEB '16 | JUL '16 | JUL '16 | C.Wood SENIOR CO-ORDINATOR NATURAL ENVIRONMENT ASSET SERVICES/BRISBANE INFRASTRUCTURE | DRAWING FILENAME | BSD-10141 (B) Small Shelter – Natural area – Plan – Sheet 1 of 2.dwg | | | |
| A | ORIGINAL ISSUE | NOV '14 | NOV '14 | NOV '14 | | ASSOCIATED PLANS | BSD-10141-Sheet 2 | | | |
| ISSUE | AMENDMENT | DRAWN DATE | CHK'D DATE | APPR'D DATE | | | | | | |



ELEVATION B
SCALE: 1: 50

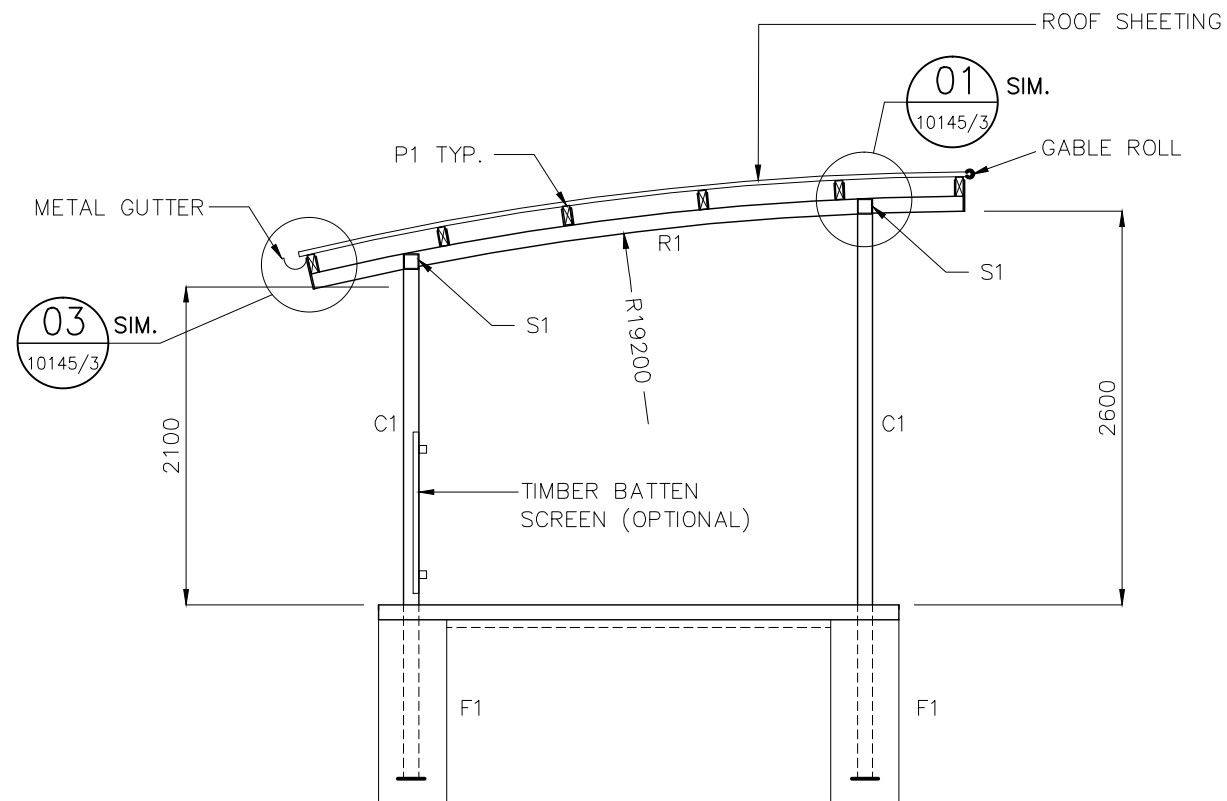

SECTION A
SCALE: 1: 50

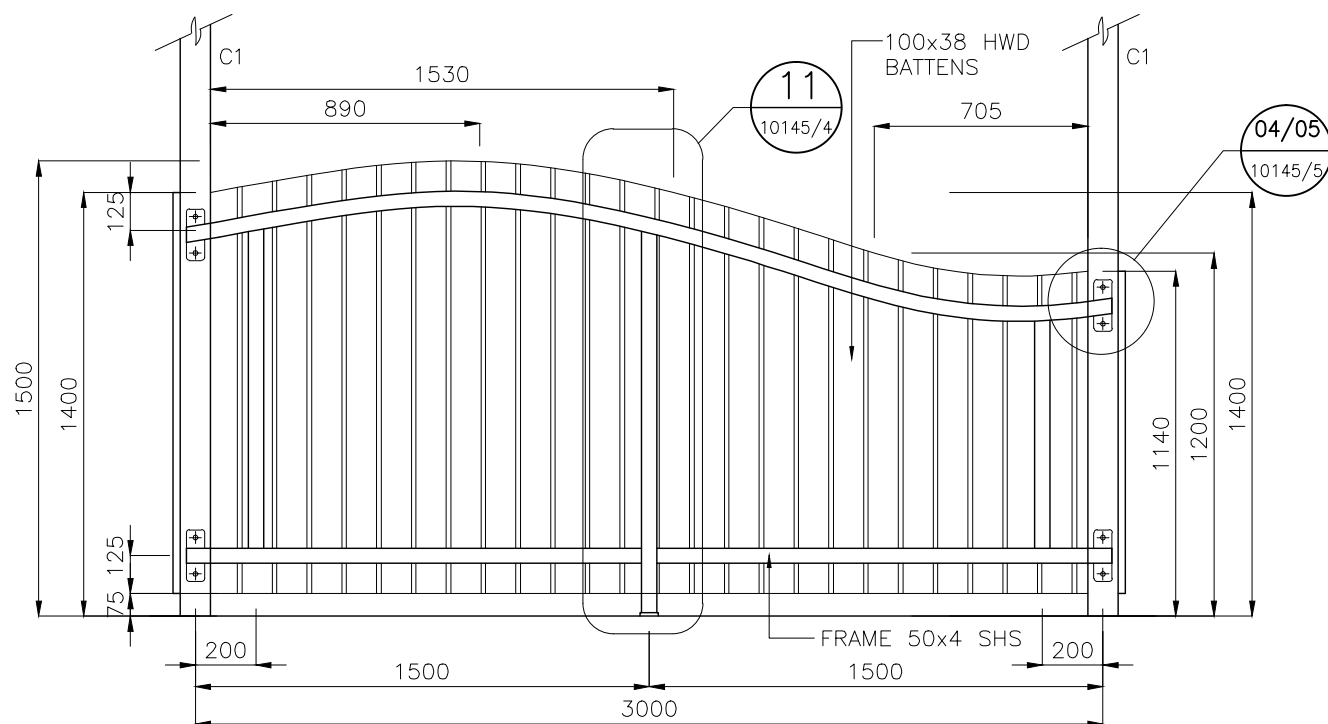

SCREEN ELEVATION C
SCALE: 1: 25

GENERAL NOTES

1. REFER TO BSD-10145 SHEET 1 AND 2 FOR STRUCTURAL NOTES AND STEEL MEMBER SCHEDULE
2. REFER TO BSD-10145 SHEET 3 FOR TYPICAL FOOTING AND SLAB DETAILS.
3. REFER TO BSD-10145 SHEET 4 & 5 FOR SCREEN DETAILS IF SCREEN IS SPECIFIED FOR SHELTER.
4. (U) DENOTES UNDER

STRUCTURAL DESIGN CERTIFICATION

| DESIGN | DESIGN CHECK | AUTHORISED FOR ISSUE |
|---|---|--|
| Zhuangzhi Hu RPEQ.13885 2014.11.26 15:32:30+10'00' | D.Bateup RPEQ.13095 2014.11.26 16:08:21+10'00' | Bala Balakumar RPEQ.3963 2014.11.27 08:33:06+10'00' |

BRISBANE CITY COUNCIL STANDARD DRAWING

**SMALL SHELTER – NATURAL AREA
ELEVATION AND SECTION
SHEET 2 OF 2**

| | |
|---------------|------------------|
| SCALE | AS SHOWN |
| DWG No. | BSD-10141 |
| ORIGINAL SIZE | A3 |
| REVISION | B |


DRAWING AUTHORISED FOR PUBLICATION

Inga Condric
2015.06.04 14:56:31+10'00'
for ASSET ENGINEERING MANAGER
STRATEGIC ASSET MANAGEMENT
DESIGN APPROVED
C.Wood
SENIOR CO-ORDINATOR NATURAL ENVIRONMENT
ASSET SERVICES/BRISBANE INFRASTRUCTURE

| | | | |
|------------------|--|------|---------|
| DESIGN | CP0 - P&D | DATE | NOV '14 |
| DRAWN | CP0 - P&D | DATE | NOV '14 |
| CHECKED | BI - FSG - AS | DATE | NOV '14 |
| DRAWING FILENAME | BSD-10141(B) Small Shelter - Natural area - Elevation and section - Sheet 2 of 2.dwg | | |
| ASSOCIATED PLANS | BSD-10141-Sheet 1 | | |




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|-------|-----------------------|------------|------------|-------------|
| B | Drawing Title Amended | FEB '16 | JUL '16 | JUL '16 |
| A | ORIGINAL ISSUE | NOV '14 | NOV '14 | NOV '14 |
| ISSUE | AMENDMENT | DRAWN DATE | CHK'D DATE | APPR'D DATE |

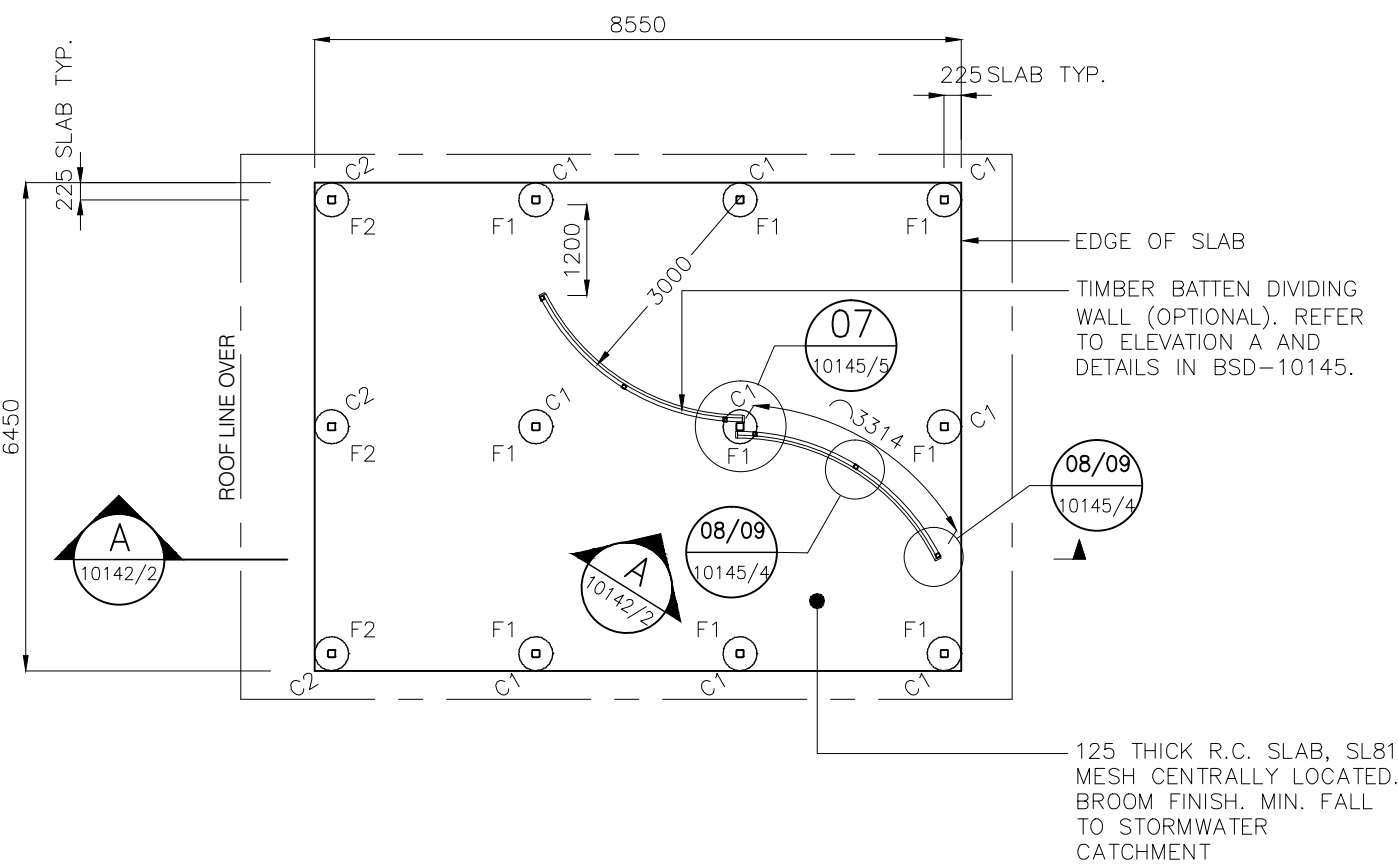

SLAB AND FOOTING PLAN
SCALE 1:100

PALRAM 'SUNTUF' CORRUGATED
POLYCARBONATE ROOF SHEETING
OR APPROVED EQUIVALENT, FIXED
AS PER MANUFACTURER'S SPEC.
COLOUR: SOLAR GREY
SPRING CURVE TO RADIUS

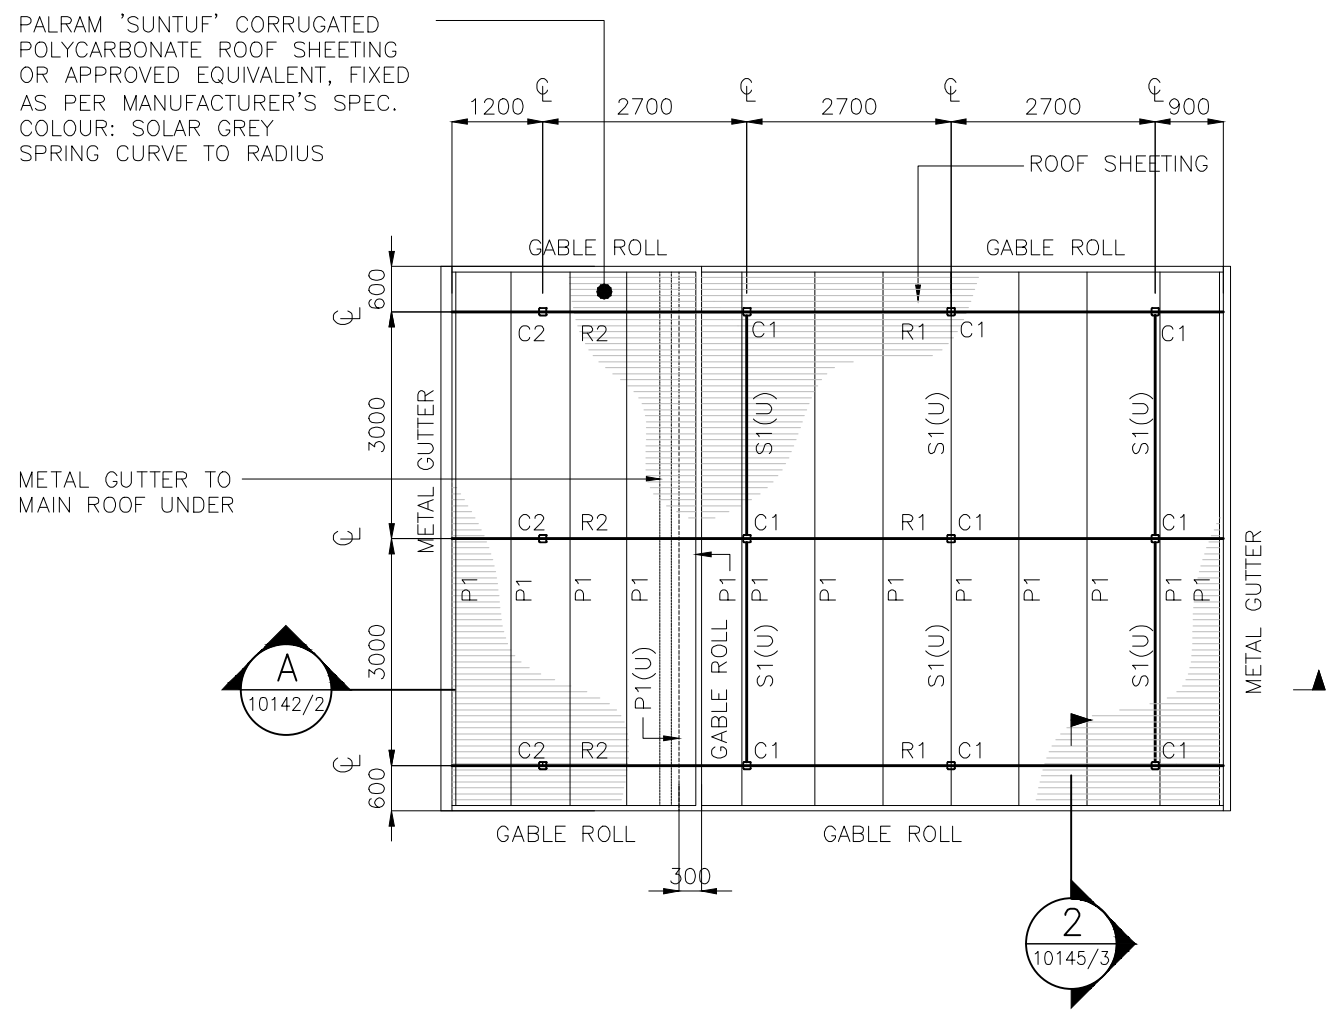


ROOF FRAMING PLAN
SCALE 1:100


GENERAL NOTES

1. REFER TO BSD-10145 SHEET 1 AND 2 FOR STRUCTURAL NOTES AND STEEL MEMBER SCHEDULE
2. REFER TO BSD-10145 SHEET 3 FOR TYPICAL FOOTING AND SLAB DETAILS.
3. REFER TO BSD-10145 SHEET 4 & 5 FOR SCREEN DETAILS IF SCREEN IS SPECIFIED FOR SHELTER.
4. (U) DENOTES UNDER


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| DESIGN | DESIGN CHECK | AUTHORISED FOR ISSUE |
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| BRISBANE CITY COUNCIL STANDARD DRAWING | | |
| MEDIUM/LARGE SHELTER NATURAL AREA – PLAN SHEET 1 OF 2 | | SCALE AS SHOWN |
| | | DWG No. BSD-10142 |
| | | ORIGINAL SIZE A3 REVISION B |

| | | | | | | | | | | |
|-------|-----------------------|---------------|---------------|----------------|---|---------------------|---|------|---------|---|
| | | | | | DRAWING AUTHORISED FOR PUBLICATION | DESIGN | CP0 - P&D | DATE | NOV '14 |  |
| | | | | | Inga Condric 2015.06.04 15:18:05+10'00' | DRAWN | CP0 - P&D | DATE | NOV '14 | |
| | | | | | for ASSET ENGINEERING MANAGER STRATEGIC ASSET MANAGEMENT | CHECKED | BI - FSG - AS | DATE | NOV '14 | |
| B | Drawing Title Amended | FEB '16 | JUL '16 | JUL '16 | DESIGN APPROVED | DRAWING FILENAME | BSD-10142 (B) Medium_large shelter - Natural area - Plan - Sheet 1 of 2.dwg | | | |
| A | ORIGINAL ISSUE | NOV '14 | NOV '14 | NOV '14 | C.Wood | ASSOCIATED PLANS | BSD-10142-Sheet 2 | | | |
| ISSUE | AMENDMENT | DRAWN DATE | CHK'D DATE | APPR'D DATE | SENIOR CO-ORDINATOR NATURAL ENVIRONMENT ASSET SERVICES/BRISBANE INFRASTRUCTURE | | | | | |



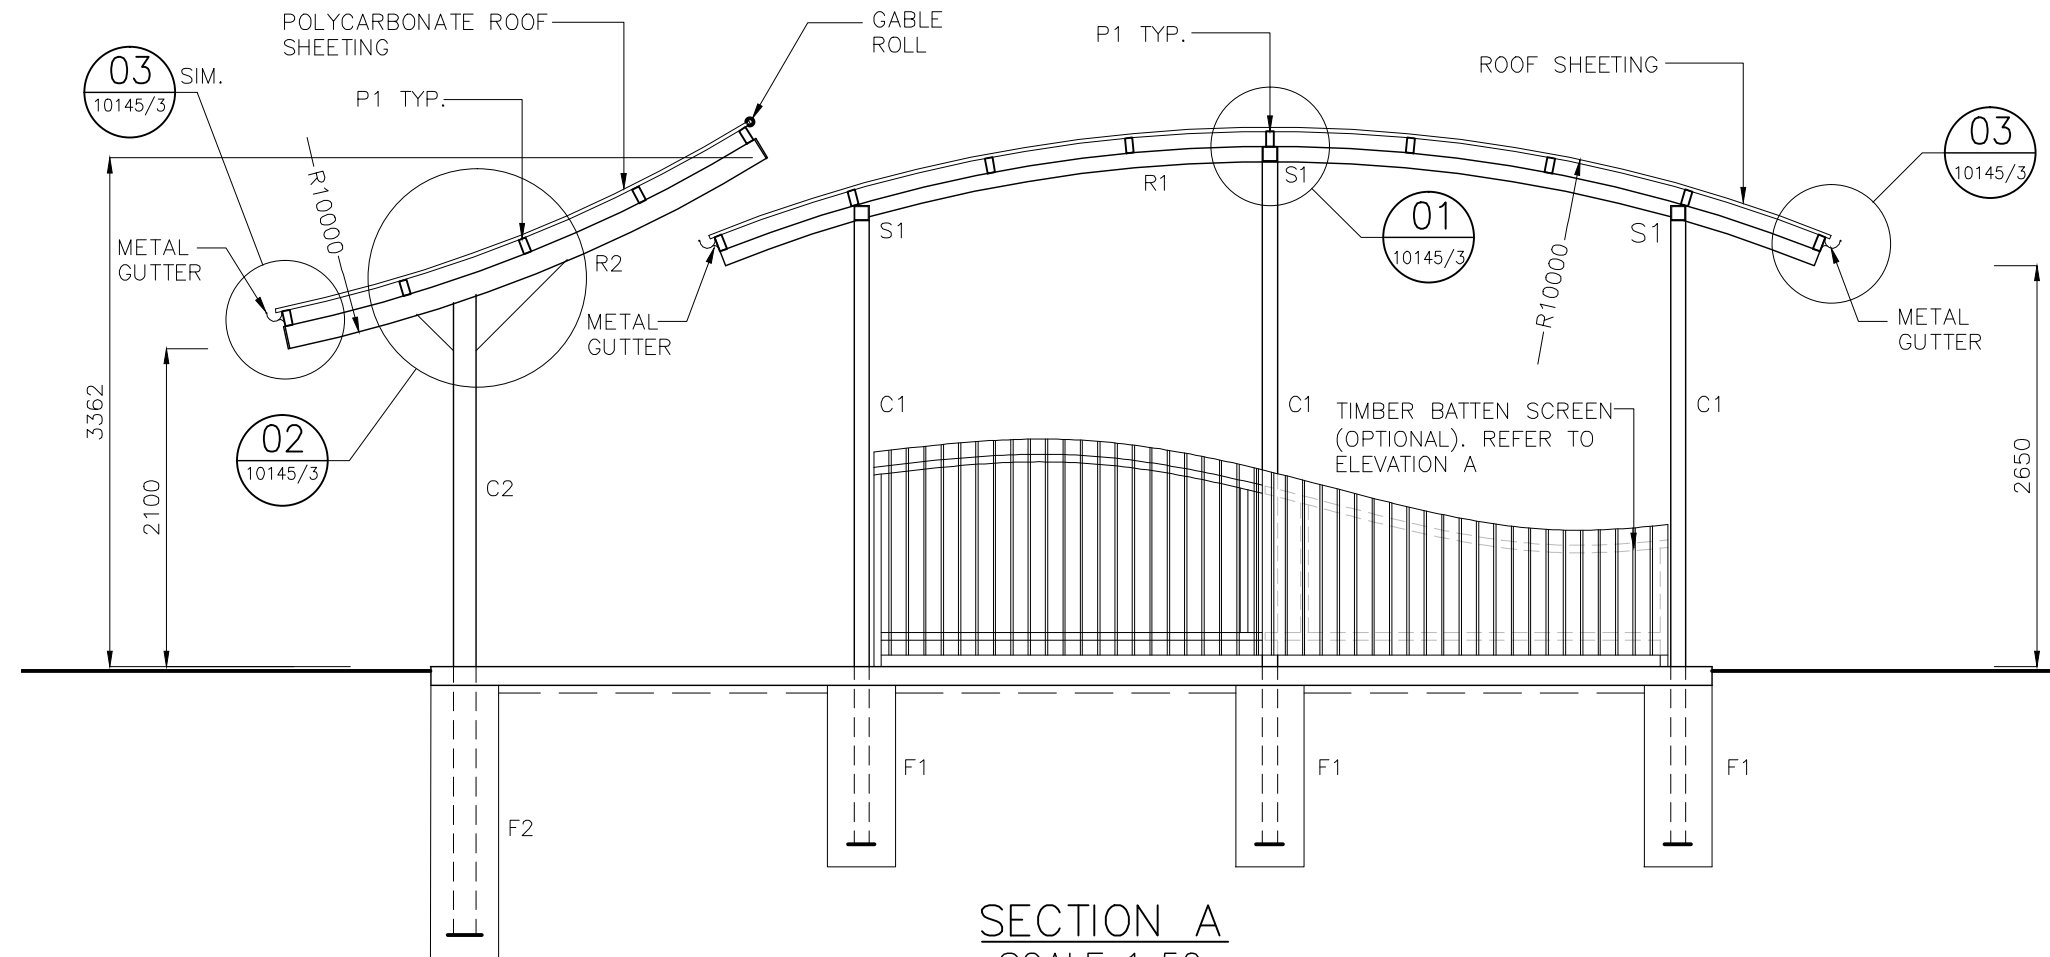

SECTION A
SCALE 1: 50

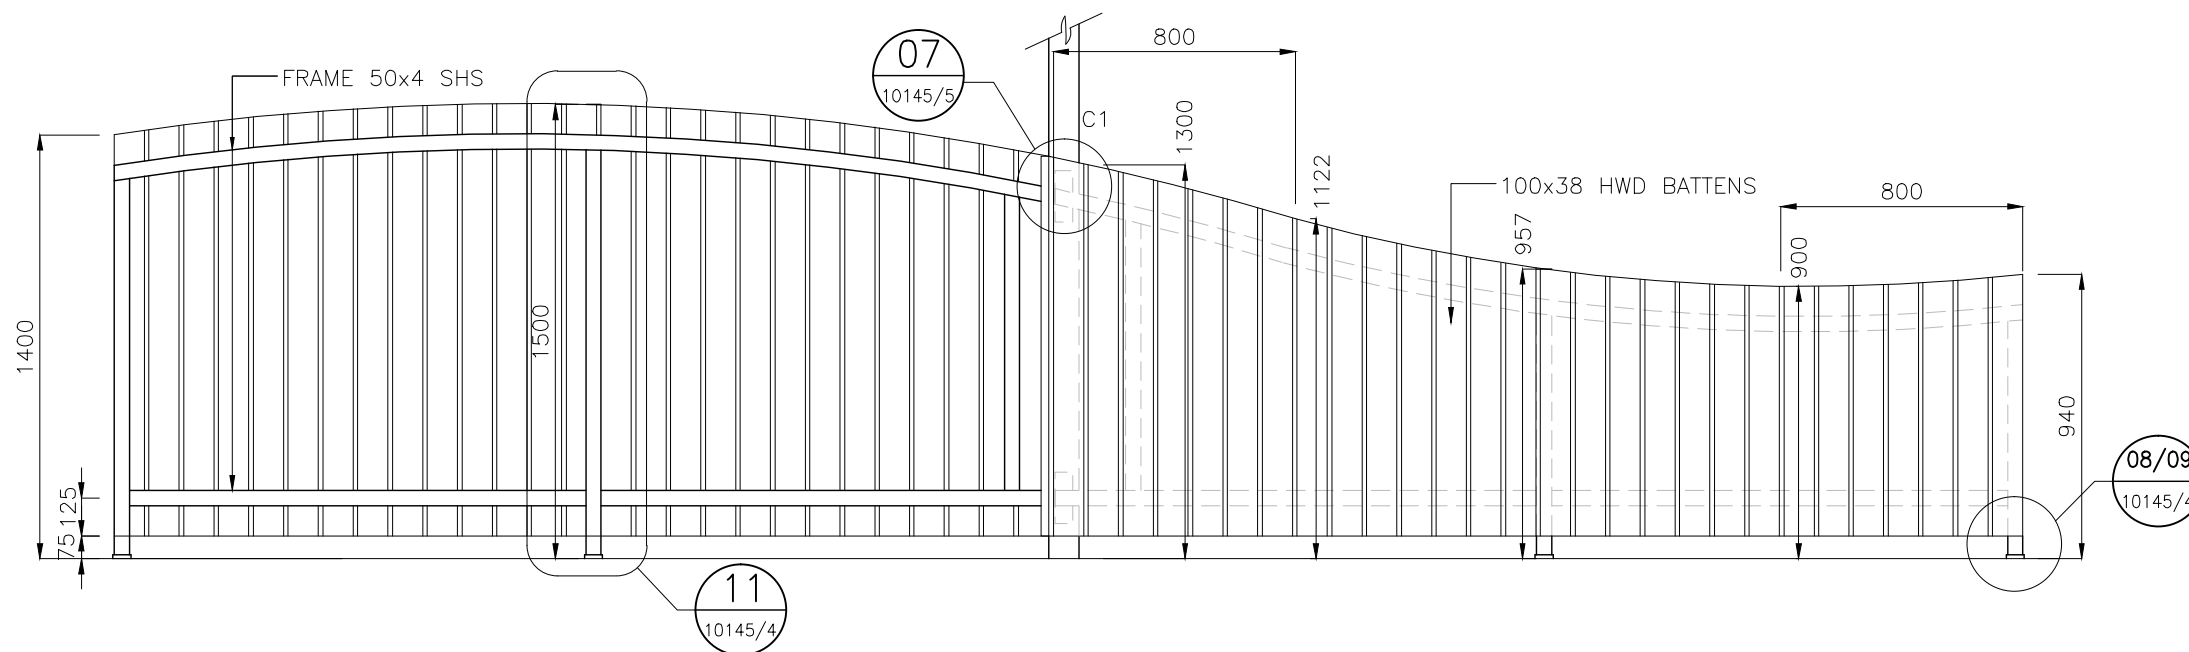

SCREEN ELEVATION A
SCALE 1: 25


GENERAL NOTES


1. REFER TO BSD-10145 SHEET 1 AND 2 FOR STRUCTURAL NOTES AND STEEL MEMBER SCHEDULE
2. REFER TO BSD-10145 SHEET 3 FOR TYPICAL FOOTING AND SLAB DETAILS.
3. REFER TO BSD-10145 SHEET 4 & 5 FOR SCREEN DETAILS IF SCREEN IS SPECIFIED FOR SHELTER.
4. (U) DENOTES UNDER

STRUCTURAL DESIGN CERTIFICATION


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| BRISBANE CITY COUNCIL STANDARD DRAWING | |
|---|---------------|
| MEDIUM/LARGE SHELTER – NATURAL AREA – ELEVATION & SECTION SHEET 2 OF 2 | |
| SCALE AS SHOWN | |
| DWG No. BSD-10142 | |
| ORIGINAL SIZE A3 | REVISION B |

| | | | | | | | | | | | |
|-------|-----------------------|---------------|---------------|----------------|--|---------------------|---------------------|---|---------|--|---------|
| | | | | | <div>DRAWING AUTHORISED FOR PUBLICATION</div> <div>Inga Candric 2015.06.04 15:19:37+10'00'</div> <div>for ASSET ENGINEERING MANAGER STRATEGIC ASSET MANAGEMENT</div> | DESIGN | CPO - P&D | DATE | NOV '14 |  <div>BRISBANE CITY</div> | |
| | | | | | | DRAWN | CPO - P&D | DATE | NOV '14 | | |
| | | | | | | DESIGN APPROVED | CHECKED | BI - FSG - AS | DATE | | NOV '14 |
| B | Drawing Title Amended | FEB '16 | JUL '16 | JUL '16 | | | DRAWING FILENAME | BSD-10142 BI Medium Large shelter - Natural area - Elevation and section - Sheet 2 of 2.dwg | | | |
| A | ORIGINAL ISSUE | NOV '14 | NOV '14 | NOV '14 | C.Wood | ASSOCIATED PLANS | BSD-10142-Sheet 1 | | | | |
| ISSUE | AMENDMENT | DRAWN DATE | CHK'D DATE | APPR'D DATE | SENIOR CO-ORDINATOR NATURAL ENVIRONMENT ASSET SERVICES/BRISBANE INFRASTRUCTURE | | | | | | |

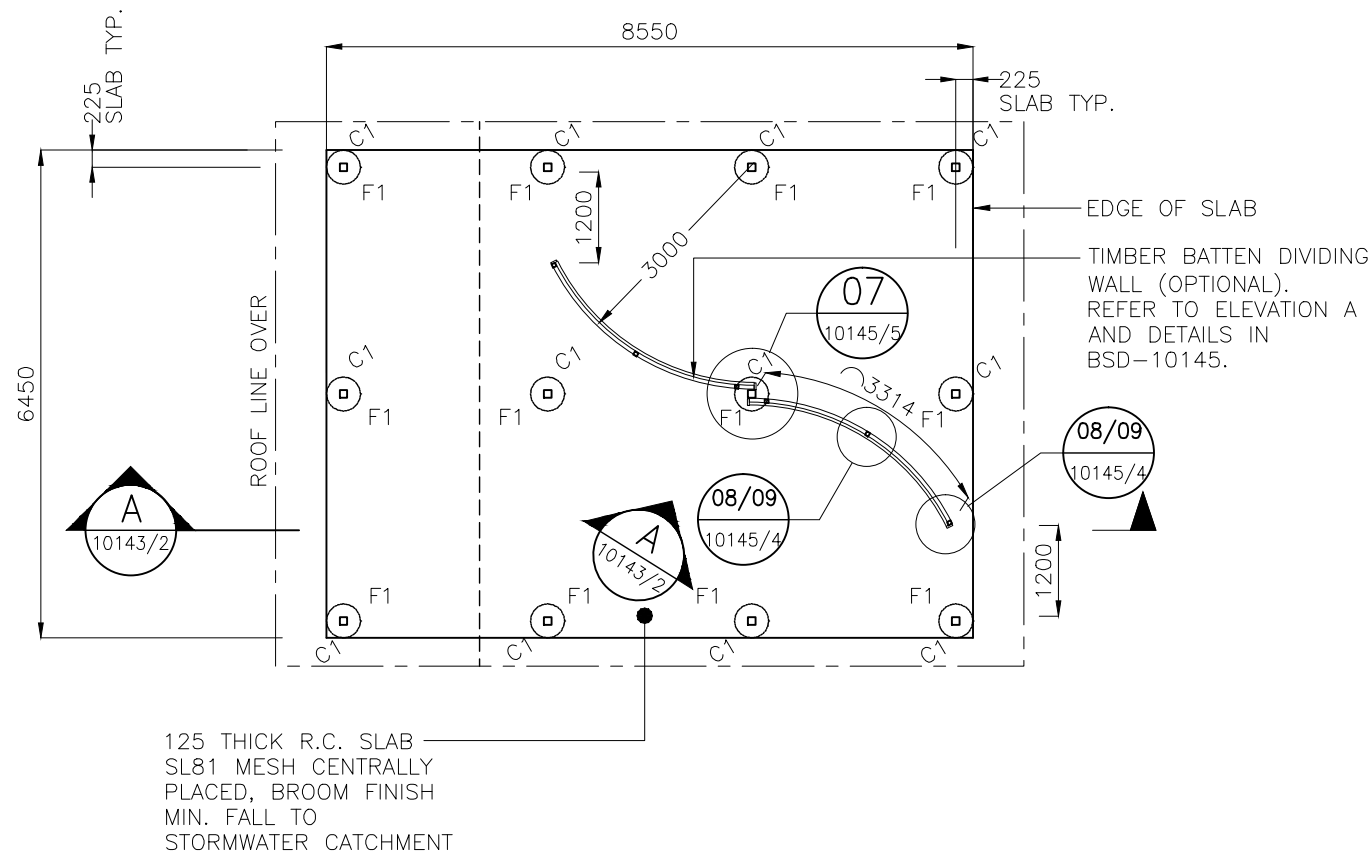

SLAB AND FOOTING PLAN
SCALE 1:100

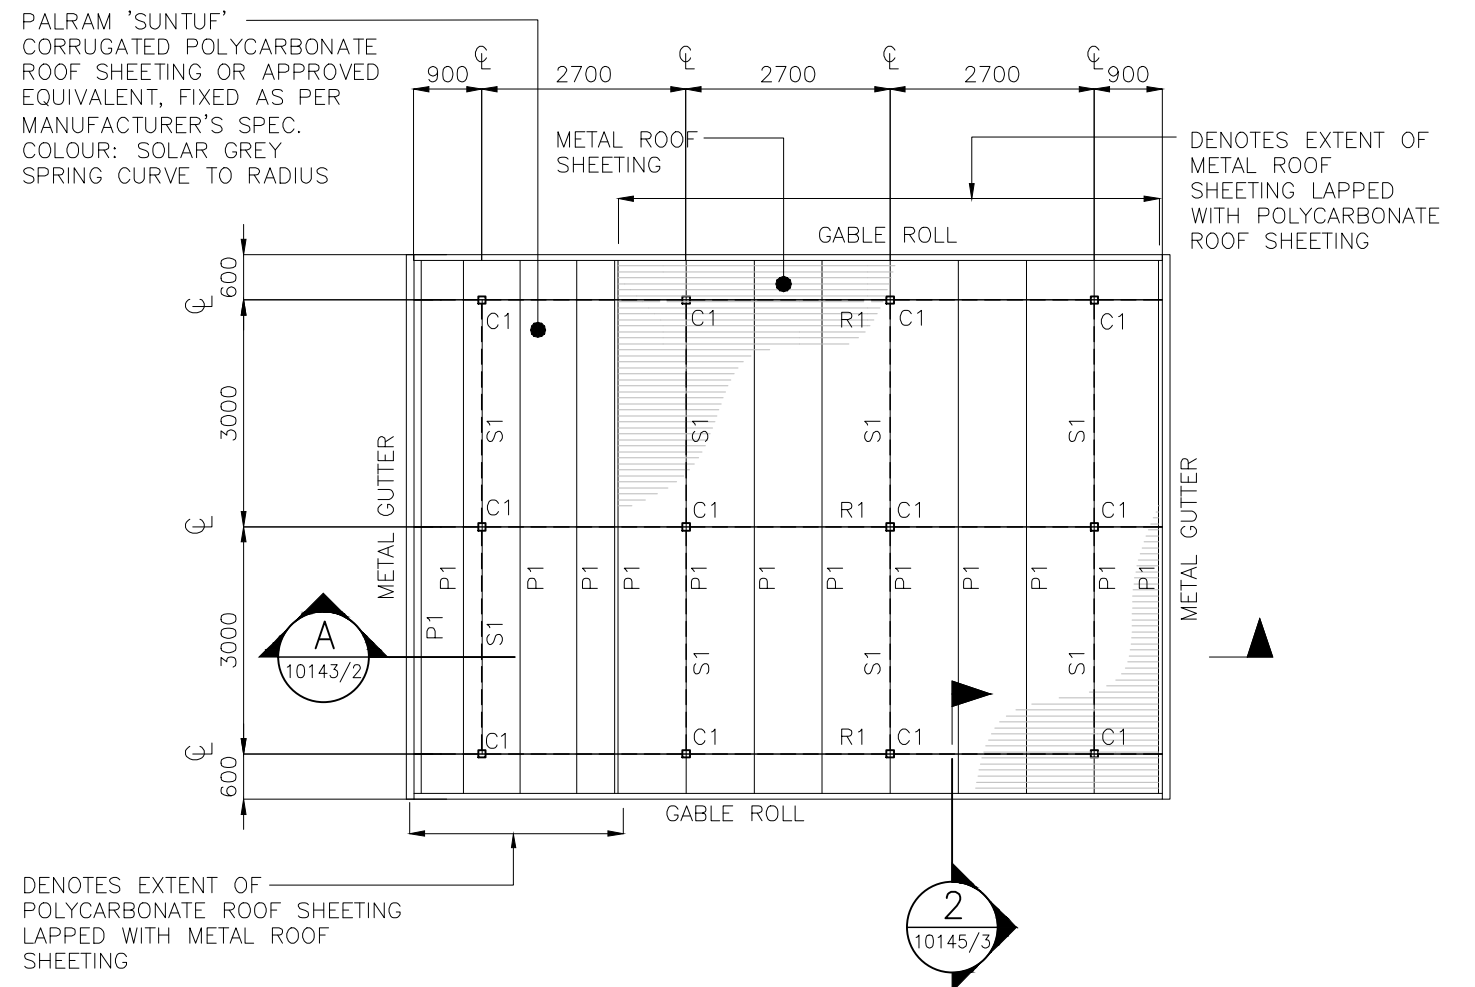

ROOF FRAMING PLAN
SCALE 1:100

GENERAL NOTES

1. REFER TO BSD-10145 SHEET 1 AND 2 FOR STRUCTURAL NOTES AND STEEL MEMBER SCHEDULE
2. REFER TO BSD-10145 SHEET 3 FOR TYPICAL FOOTING AND SLAB DETAILS.
3. REFER TO BSD-10145 SHEET 4 & 5 FOR SCREEN DETAILS IF SCREEN IS SPECIFIED FOR SHELTER.
4. (U) DENOTES UNDER


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| | | | | |
| B | Drawing Title Amended | FEB '16 | JUL '16 | JUL '16 |
| A | ORIGINAL ISSUE | NOV '14 | NOV '14 | NOV '14 |
| ISSUE | AMENDMENT | DRAWN DATE | CHK'D DATE | APPR'D DATE |

| |
|---|
| DRAWING AUTHORISED FOR PUBLICATION |
| Inga Cendric 2015.06.04 15:20:17+10'00' |
| for ASSET ENGINEERING MANAGER STRATEGIC ASSET MANAGEMENT |
| DESIGN APPROVED |
| C.Wood |
| SENIOR CO-ORDINATOR NATURAL ENVIRONMENT ASSET SERVICES/BRISBANE INFRASTRUCTURE |


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| DESIGN | CP0 - P&D | DATE | NOV '14 |
| DRAWN | CP0 - P&D | DATE | NOV '14 |
| CHECKED | BI - FSG - AS | DATE | NOV '14 |
| DRAWING FILENAME | BSD-10143 (B) Large shelter - Natural area - Plan - Sheet 1 of 2.dwg | | |
| ASSOCIATED PLANS | BSD-10143-Sheet 2 | | |



| STRUCTURAL DESIGN CERTIFICATION | | |
|---|---|--|
| DESIGN | DESIGN CHECK | AUTHORISED FOR ISSUE |
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| BRISBANE CITY COUNCIL STANDARD DRAWING | | SCALE AS SHOWN |
| LARGE SHELTER NATURAL AREA - PLAN SHEET 1 OF 2 | | DWG No. BSD-10143 |
| | | ORIGINAL SIZE A3 |
| | | REVISION B |

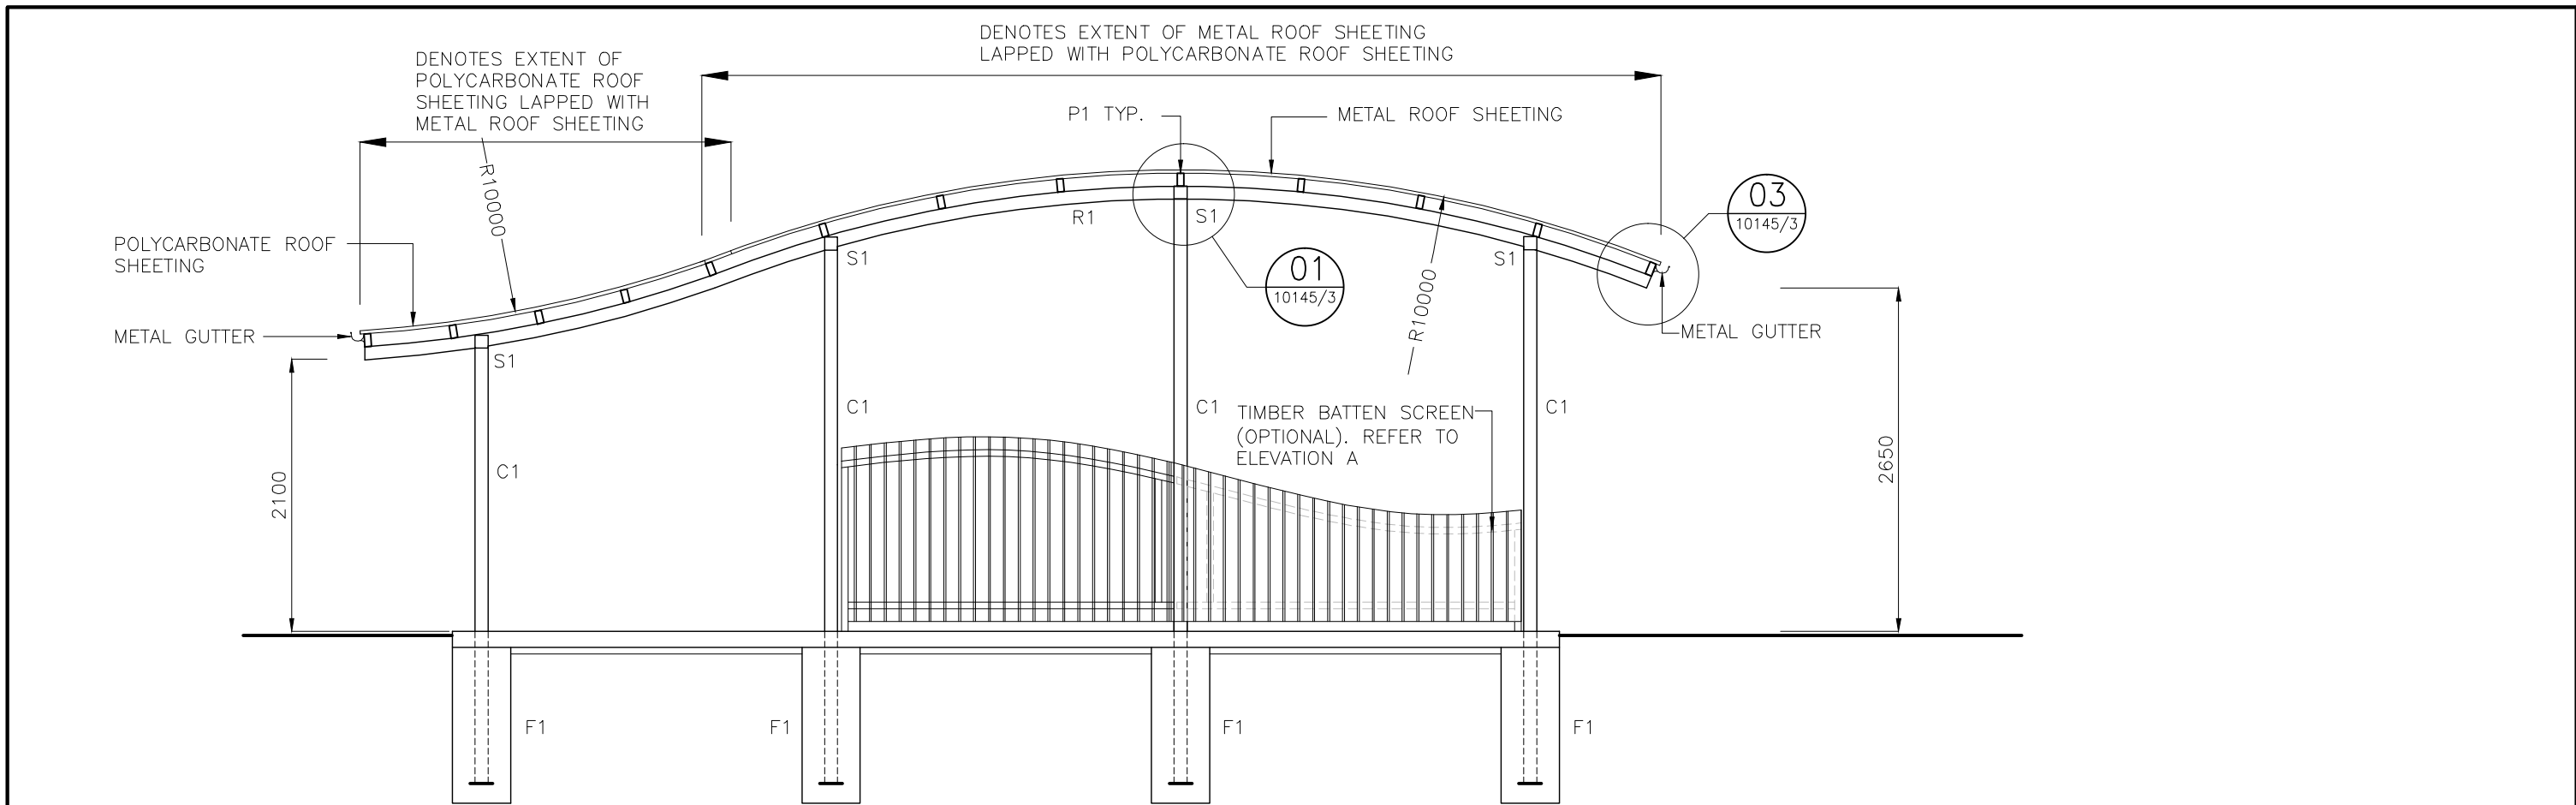

SECTION A
SCALE: 1: 50

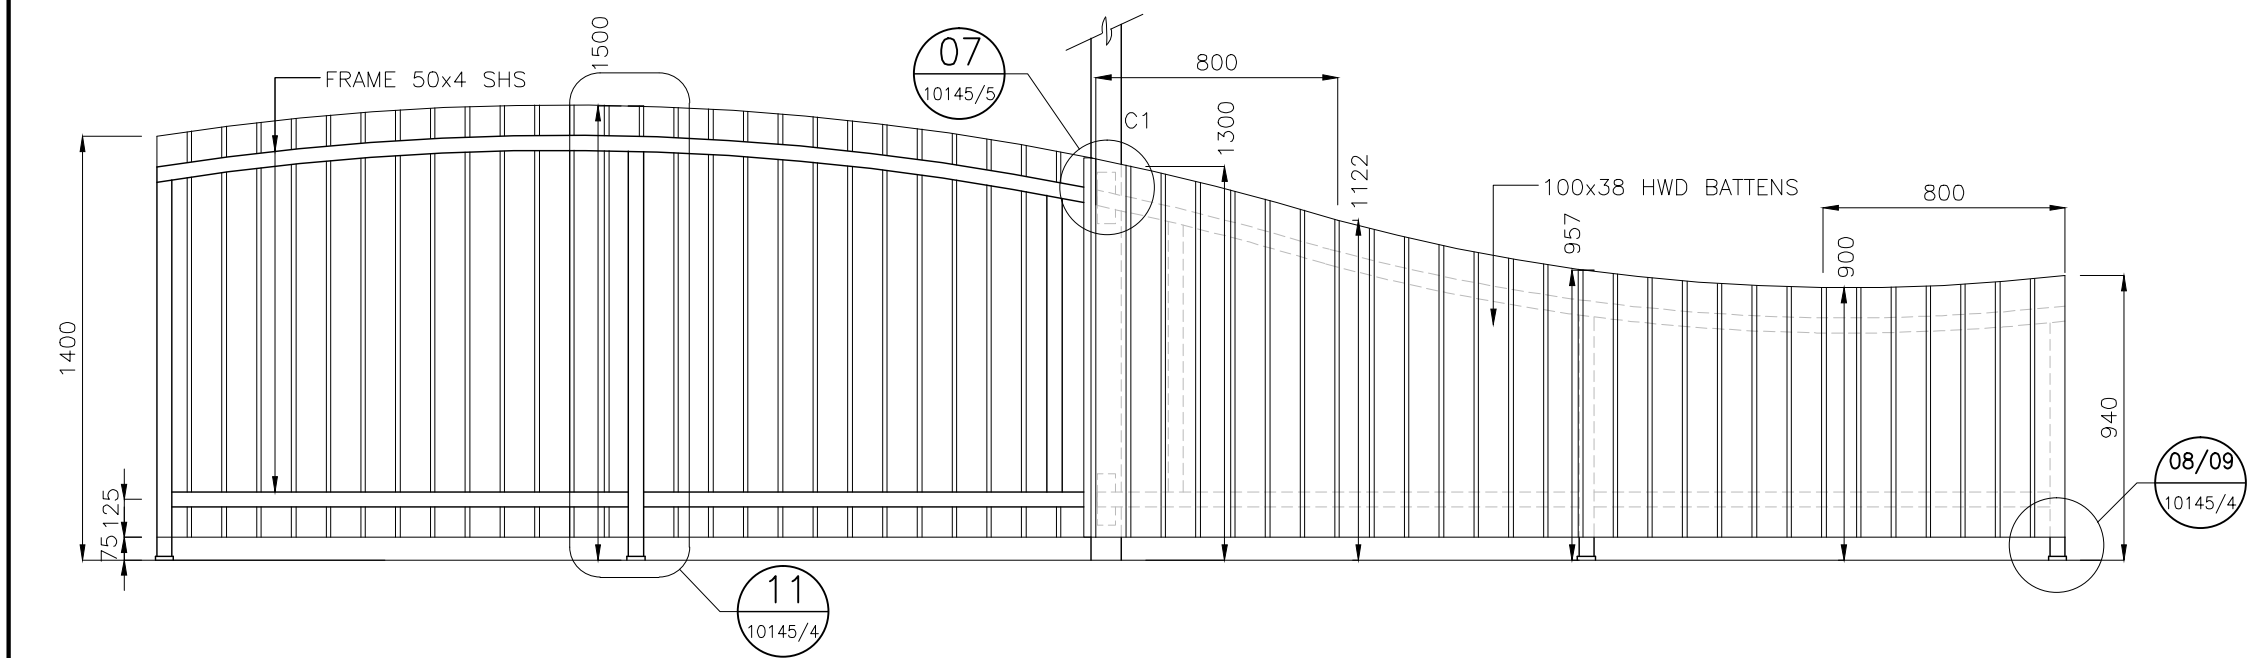


SCREEN ELEVATION A
SCALE 1: 25


GENERAL NOTES

1. REFER TO BSD-10145 SHEET 1 AND 2 FOR STRUCTURAL NOTES AND STEEL MEMBER SCHEDULE.
2. REFER TO BSD-10145 SHEET 3 FOR TYPICAL FOOTING AND SLAB DETAILS.
3. REFER TO BSD-10145 SHEET 4 & 5 FOR SCREEN DETAILS IF SCREEN IS SPECIFIED FOR SHELTER.
4. (U) DENOTES UNDER

| SCREEN ELEVATION A | | | | | | | | | |
|---|-----------------------|--|--|---------------|--|---|-------------------|--|--|
| SCALE 1: 25 | | | | | | | | | |
| STRUCTURAL DESIGN CERTIFICATION | | | | | | | | | |
| DESIGN | | | | | DESIGN CHECK | | | AUTHORISED FOR ISSUE | |
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| BRISBANE CITY COUNCIL STANDARD DRAWING | | | | | | | | | |
| LARGE SHELTER – NATURAL AREA ELEVATION & SECTION SHEET 2 OF 2 | | | | | SCALE AS SHOWN | | DWG No. BSD–10143 | | |
| | | | | | ORIGINAL SIZE A3 | | REVISION B | | |
| DRAWING AUTHORISED FOR PUBLICATION | | | | | DESIGN | CP0 - P&D | DATE | NOV '14 | |
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| for ASSET ENGINEERING MANAGER STRATEGIC ASSET MANAGEMENT | | | | | CHECKED | BI - FSG - AS | DATE | NOV '14 | |
| DESIGN APPROVED | | | | | DRAWING FILENAME | BSD-10143 (B) Large shelter - Natural area - Elevation and section - Sheet 2 of 2.dwg | | | |
| C.Wood | | | | | ASSOCIATED PLANS | BSD-10143-Sheet 1 | | | |
| SENIOR CO-ORDINATOR NATURAL ENVIRONMENT ASSET SERVICES/BRISBANE INFRASTRUCTURE | | | | | | | | | |
| B | Drawing Title Amended | | | FEB '16 | JUL '16 | JUL '16 | | | |
| A | ORIGINAL ISSUE | | | NOV '14 | NOV '14 | NOV '14 | | | |
| ISSUE | AMENDMENT | | | DRAWN DATE | CHK'D DATE | APPR'D DATE | | | |

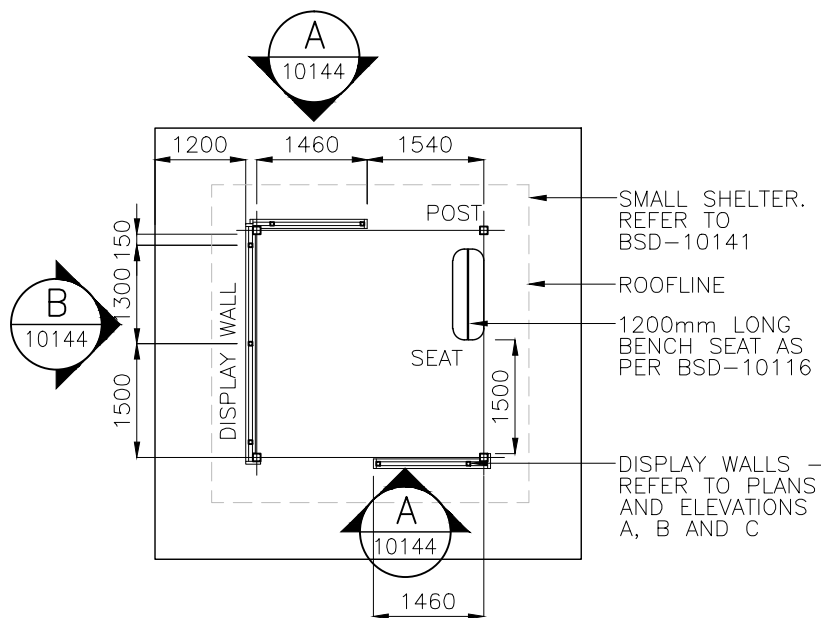


PLAN – OPTION 1
SCALE 1:100

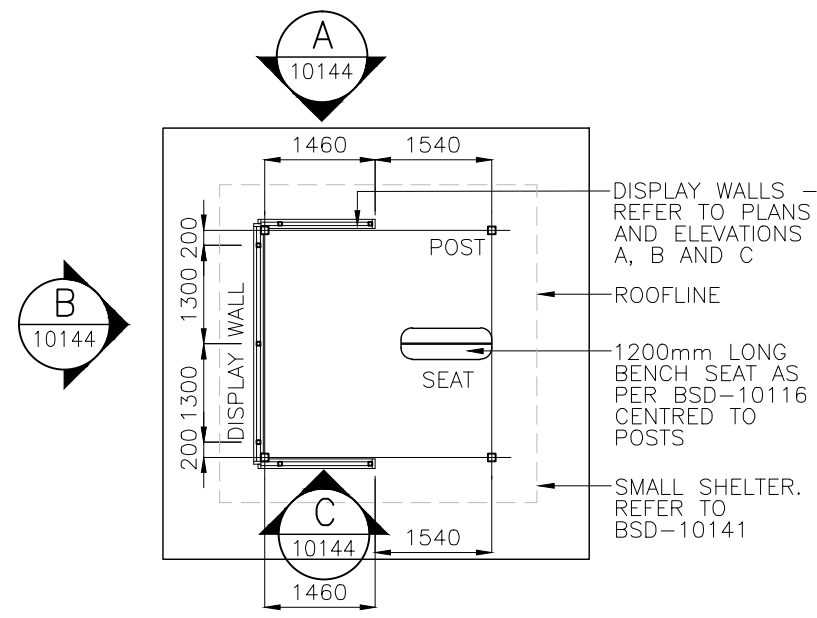


PLAN – OPTION 2
SCALE 1:100

NOTES


- INFORMATION SHELTER INCLUDES DISPLAY SCREENS WITHIN A SMALL SHELTER. FOR DETAILS RELATING TO THE SMALL SHELTER CONSTRUCTION REFER TO:
 - BSD-10141 SMALL SHELTER-NATURAL AREA-PLAN-SHEET 1 OF 2
 - BSD-10141 SMALL SHELTER-NATURAL AREA-ELEVATION AND SECTION-SHEET 2 OF 2
 - BSD-10145 SMALL/MEDIUM/LARGE SHELTERS-NATURAL AREA-GENERAL NOTES-SHEET 1 OF 5
 - BSD-10145 SMALL/MEDIUM/LARGE SHELTERS-GENERAL NOTES-SHEET 2 OF 5
 - BSD-10145 SMALL/MEDIUM/LARGE SHELTERS-NATURAL AREA-DETAILS-SHEET 3 OF 5
- FOR DISPLAY SCREEN DETAILS REFER TO:
 - BSD-10145 SMALL/MEDIUM/LARGE SHELTERS-NATURAL AREA-SCREEN DETAILS-SHEET 4 OF 5
 - BSD-10145 SMALL/MEDIUM/LARGE SHELTERS-NATURAL AREA-SCREEN DETAILS-SHEET 5 OF 5

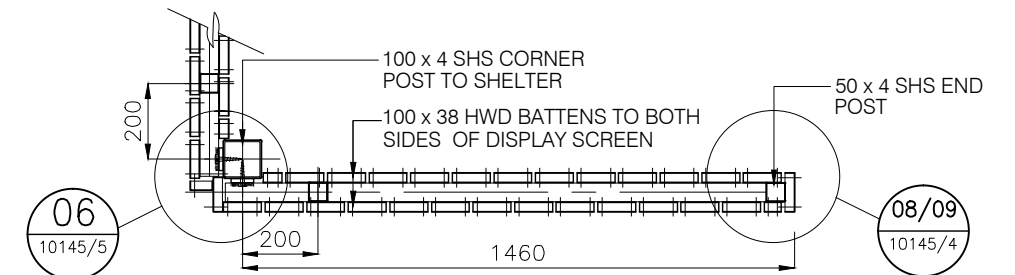


PLAN – TYPICAL DISPLAY SCREEN
SCALE 1:20

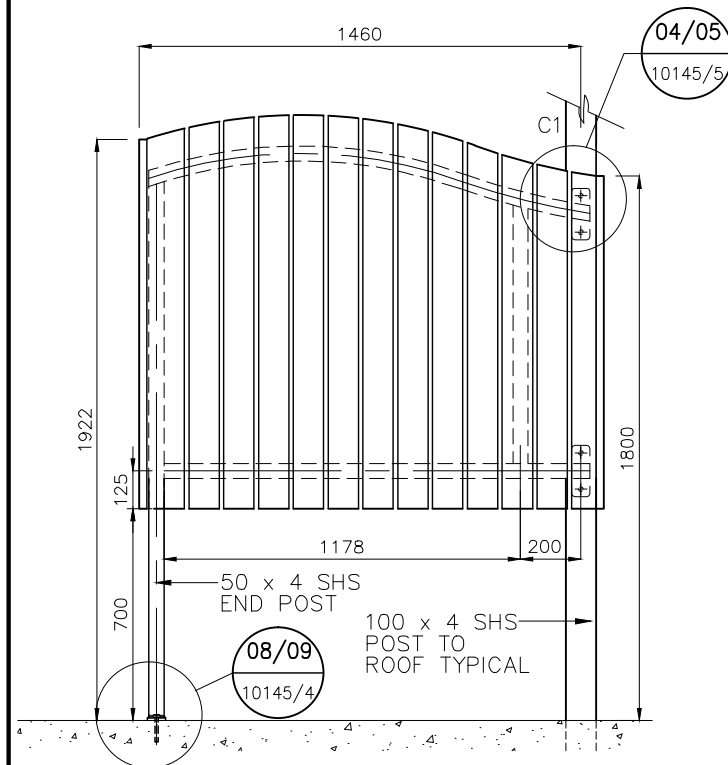

ELEVATION – VIEW A
SCALE 1:25

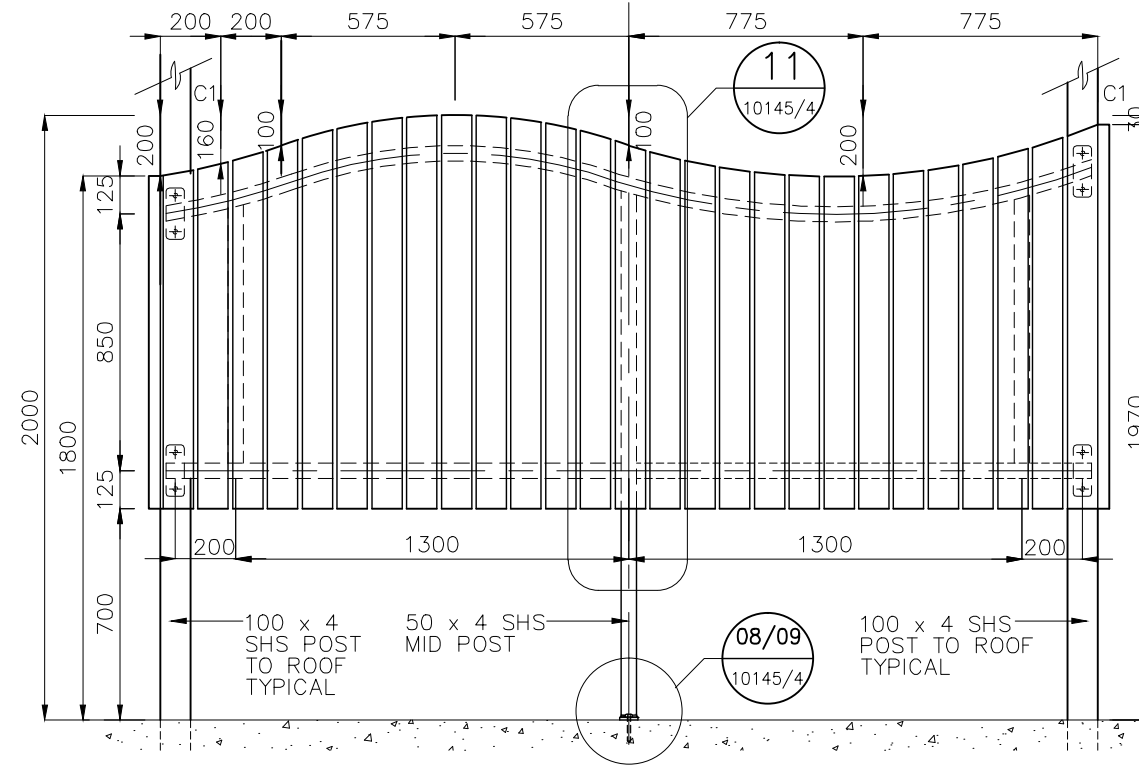

ELEVATION – VIEW B
SCALE 1:25

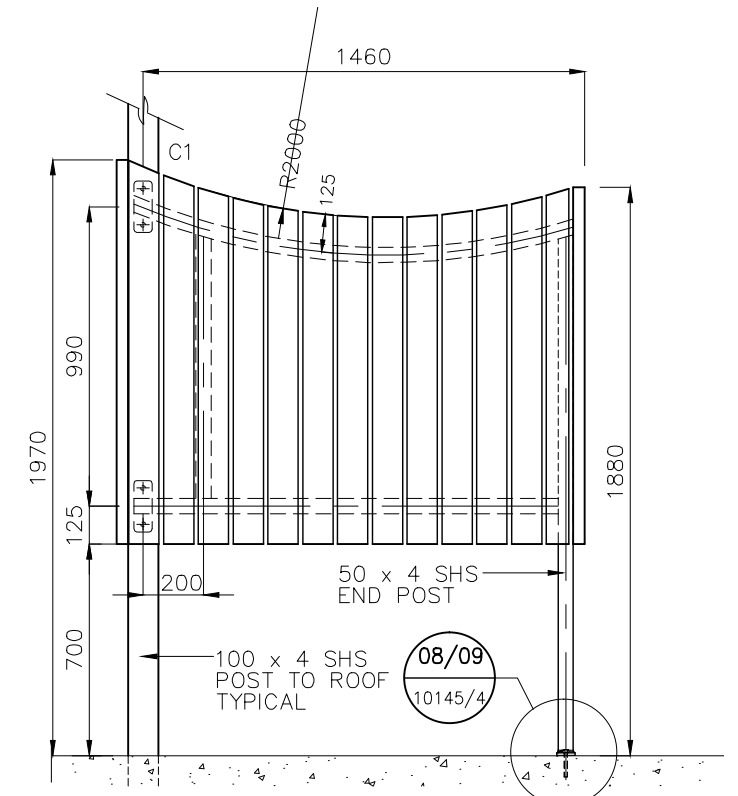

ELEVATION – VIEW C
SCALE 1:25

STRUCTURAL DESIGN CERTIFICATION

| DESIGN | DESIGN CHECK | AUTHORISED FOR ISSUE |
|---|---|--|
| Zhuangzhi Hu RPEQ.13885 2014.11.26 15:37:09+10'00' | D.Bateup RPEQ.13095 2014.11.26 16:11:50+10'00' | Bata Balakumar RPEQ.3963 2014.11.24 08:36:21+10'00' |

| BRISBANE CITY COUNCIL STANDARD DRAWING | |
|---|-----------------------------|
| SMALL INFORMATION SHELTER NATURAL AREA | SCALE AS SHOWN |
| | DWG No. BSD-10144 |
| | ORIGINAL SIZE A3 REVISION B |

| | | | | | | | | |
|---|--|--|--|--|------------------|--|--|--|
| DRAWING AUTHORISED FOR PUBLICATION | | | | | DESIGN | | DATE | |
| Inga Cendric 2015.06.04 15:21:53+10'00' | | | | | CP0 - P&D | | NOV '14 | |
| for ASSET ENGINEERING MANAGER STRATEGIC ASSET MANAGEMENT | | | | | DRAWN | | DATE | |
| DESIGN APPROVED | | | | | BI - FSG - AS | | NOV '14 | |
| C.Wood | | | | | CHECKED | | DATE | |
| SENIOR CO-ORDINATOR NATURAL ENVIRONMENT ASSET SERVICES/BRISBANE INFRASTRUCTURE | | | | | DRAWING FILENAME | | BSD-10144 (B) Small information shelter - Natural area.dwg | |
| | | | | | ASSOCIATED PLANS | | | |



| | | | | |
|-------|----------------|------------|------------|-------------|
| B | Notes Amended | FEB '16 | JUL '16 | JUL '16 |
| A | ORIGINAL ISSUE | NOV '14 | NOV '14 | NOV '14 |
| ISSUE | AMENDMENT | DRAWN DATE | CHK'D DATE | APPR'D DATE |

G1 THE BUILDER SHALL BE RESPONSIBLE FOR MAINTAINING STABILITY OF
THE STRUCTURE UNTIL COMPLETION OF CONSTRUCTION AND SHALL
G2 ENSURE THAT NO PART OF THE STRUCTURE IS OVERSTRESSED.
THE BUILDER SHALL CHECK ALL DIMENSIONS AND ALL EXISTING
G3 CONDITIONS BEFORE COMMENCING CONSTRUCTION.
ANY DAMAGE CAUSED BY THE CONTRACTOR SHALL BE MADE GOOD AT
THEIR OWN COST.
G4 ALL MATERIALS AND WORKMANSHIP SHALL BE IN ACCORDANCE WITH
THE CURRENT EDITIONS OF THE FOLLOWING AUSTRALIAN STANDARDS,
EXCEPT WHERE VARIED BY THE SPECIFICATIONS AND/OR DRAWINGS: –
AS 1684.2 (2010) RESIDENTIAL TIMBER FRAMED CONSTRUCTION
AS 1720.1 (2010) TIMBER STRUCTURES
AS 2870 (2011) RESIDENTIAL SLABS AND FOOTINGS
AS 3600 (2009) CONCRETE STRUCTURES
AS 3798 (2007) GUIDELINES ON EARTHWORKS FOR COMMERCIAL AND
RESIDENTIAL DEVELOPMENTS
AS 4100 (1998) STEEL STRUCTURES
G5 DIMENSIONS SHALL NOT BE OBTAINED BY SCALING THE STRUCTURAL
DRAWINGS.
G6 ALL DIMENSIONS ARE IN MILLIMETRES UNLESS NOTED OTHERWISE
G7 U.N.O. DENOTES UNLESS NOTED OTHERWISE.
G8 THE CONTRACTOR SHALL VISIT THE SITE PRIOR TO TENDERING TO
FAMILIARISE THEMSELVES WITH ACCESS SITE CONDITIONS
G9 THE CONTRACTOR MAY OFFER FOR CONSIDERATION ALTERNATIVE
PROVEN EQUAL PRODUCTS TO THOSE INDICATED. ALTERNATIVE
PRODUCTS ARE NOT TO ADVERSELY AFFECT THE PROJECT AND CANNOT
BE SUBSTITUTED WITHOUT PRIOR APPROVAL.
G10 EXISTING SERVICES TO BE LOCATED BEFORE CONSTRUCTION
COMMENCES.
G11 THIS DRAWING IS TO BE READ IN CONJUNCTION WITH SHEET 2 TO 5.
G12 CONSULT BCC ARCHITECT FOR COLOUR SCHEME OF THE STRUCTURE.

WIND LOADS : REGION B TERRAIN CATEGORY 1.5
 ULTIMATE WIND SPEED = 54.0 m/s
 DESIGN LIFE : 50 YEARS WITH ROUTINE MAINTENANCE.
 LIVE LOADS: : FLOOR = 5.0 kPa. ROOF= 0.25 kPa / 1.4 kN.
 NO SCREENS(IMPERMEABLE OR PERMEABLE BARRIERS) TO BE
 INSTALLED UNLESS SHOWN ON THE DRAWINGS.

TERRAIN CATEGORY 1.5 CORRESPONDS TO AN ENVIRONMENT WITH OPEN
 WATER SURFACES, SUBJECTED TO SHOALING WAVES AT SERVICEABILITY
 AND ULTIMATE WIND SPEEDS IN ALL WIND REGIONS.

- F1 ALL FOOTINGS ARE TO BE FOUNDED IN THE NATURAL UNDISTURBED SOIL PROFILE WITH A MINIMUM ALLOWABLE SOIL BEARING CAPACITY OF 100kPa UNLESS NOTED OTHERWISE. IF SITE CONDITION IS DIFFERENT, CONSULT A STRUCTURAL ENGINEER
- F2 SOIL TEST IS REQUIRED TO CONFIRM BEARING CAPACITY AND SITE CLASSIFICATION TO AS 2870.
- F3 FOUNDATIONS ARE TO BE CHECKED AND CERTIFIED BY A REGISTERED PROFESSIONAL GEOTECHNICAL ENGINEER, QUEENSLAND (RPEQ).
- F4 COMPACT AND PREPARE THE BASE TO PROVIDE A SOUND PLATFORM AND ANY ORGANIC, SOFT OR LOOSE MATERIALS REMOVED AND REPLACED WITH COMPACTED FILL – BCC SPECIFICATION S300 QUARRY PRODUCTS CLASS 1 MATERIAL.
- F5 THE BOTTOMS OF ALL FOOTINGS ARE TO BE CLEANED OF ALL LOOSE MATERIAL AND WATER PRIOR TO POURING CONCRETE.
- F6 SLABS ON GRADE SHALL BE UNDERLAIN WITH CONTINUOUS LAYER OF 200 MICRON (0.2mm) THICK POLYETHYLENE DAMPPROOF MEMBRANE AS PER AS 2870, LAPPED AND TAPED TO MANUFACTURER'S SPECIFICATION.

E1 STRIP ALL HUMUS MATERIAL FROM THE AREA OF THE BUILDING IMPRINT AND 1000 BEYOND.

E2 PROOF ROLL THE AREAS TO BE CONCRETED AND PAVED. REMOVE ANY WEAK MATERIAL.

E3 USE NON-HUMUS CUT MATERIAL OR IMPORTED APPROVED NON-REACTIVE SOIL AS FILL.

E4 COMPACTED FILL SHALL BE COMPACTED IN LAYERS NOT EXCEEDING 150mm LOOSE DEPTH TO 98% MAXIMUM DRY DENSITY IN ACCORDANCE WITH AS 1289. 5.1.1 (STANDARD COMPACTION). CARRY OUT DENSITY TESTS AT A RATE OF 2 PER LEVEL OF FILL. EVERY TEST MUST PASS.

C1 ALL WORKMANSHIP AND MATERIAL SHALL BE IN ACCORDANCE WITH 3600.

C2 ALL CONCRETE SHALL BE PREMIXED BY AN APPROVED SUPPLIER.

C3 ALL CEMENT SHALL BE TYPE GP OR GB.

C4 CONCRETE SPECIFICATION: NOMINAL AGGREGATE SIZE TO BE 20mm, SLUMP TO BE NOT GREATER THAN 80mm.

C5 CONCRETE STRENGTH AND CLEAR CONCRETE COVER TO REINFORCEMENT SHALL BE IN ACCORDANCE WITH THE FOLLOWING TABLE U.N.O.ELEMENT:

| F'C (MPa) | REINFORCEMENT COVER |
|-----------|---------------------|
| PIERS | 32 |
| SLAB | 32 |

CENTRALLY PLACED.

C6 ALL LAPS IN REINFORCEMENT SHALL BE AS SHOWN IN THE TABLE BELOW UNLESS NOTED OTHERWISE.

| BAR LAP LENGTH (mm) | |
|---------------------|-----|
| N12 | 500 |
| N16 | 650 |
| MESH | 350 |

C7 REINFORCEMENT SYMBOLS: R STRUCTURAL PLAIN ROUND GRADE 250R TO AS 4671.

| | |
|----|---|
| N | DEFORMED BAR GRADE D500N TO AS 4671. |
| SL | HARD DRAWN STEEL REINFORCING FABRIC GRADE D500L TO AS 4671. |

C8 SIZES OF CONCRETE ELEMENTS DO NOT INCLUDE THICKNESS OF APPLIED FINISHES.


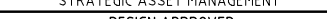

C9 NO HOLES, CHASES OR EMBEDMENT OF PIPES OTHER THAN THOSE SHOWN ON THE STRUCTURAL DRAWINGS SHALL BE MADE IN CONCRETE MEMBERS WITHOUT PRIOR APPROVAL BY THE SUPERINTENDENT.

C10 ALL CONCRETE SHALL BE COMPACTED USING A MECHANICAL VIBRATION PROCESS.

C11 ALL REINFORCEMENT SHALL BE SECURELY SUPPORTED IN ITS CORRECT POSITION DURING CONCRETING BY APPROVED BAR CHAIRS, SPACERS OR SUPPORT BARS.

C12 CONSTRUCTION JOINTS SHALL BE PROPERLY FORMED AND USED ONLY WHERE SHOWN OR SPECIFICALLY APPROVED BY THE SUPERINTENDENT.

A1 THE CONTRACTOR'S ENGINEER (RPEQ) SHALL UNDERTAKE INSPECTIONS DURING CONSTRUCTION TO ENSURE ALL CONSTRUCTION WORKS ARE IN ACCORDANCE WITH THE MOST CURRENT ISSUE OF THE STRUCTURAL DRAWINGS AND THE CONTRACT DOCUMENT. THE RPEQ SHALL CERTIFY ALL CONSTRUCTION WORK (FORM 16). ANY ALTERNATIVE TECHNIQUE USED IN CONSTRUCTION SHALL BE FOLLOWED BY A DESIGN CERTIFICATE (FORM 15) BY THE CONTRACTOR'S PROFESSIONAL ENGINEER (RPEQ).

| | | | | | |
|---|---|------------|------------|-------------|--|
| F-8 SLABS ON GRADE SHALL BE UNDERLAIN WITH CONTINUOUS LAYER OF 200 MICRON (0.2mm) THICK POLYETHYLENE DAMPPROOF MEMBRANE AS PER AS 2870, LAPPED AND TAPED TO MANUFACTURER'S SPECIFICATION. | | | | | |
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| B | Drawing Title Amended | FEB '16 | JUL '16 | JUL '16 | |
| A | ORIGINAL ISSUE | NOV '14 | NOV '14 | NOV '14 | |
| ISSUE | AMENDMENT | DRAWN DATE | CHK'D DATE | APPR'D DATE | |
| | | | | | <div style="text-align: center;"> DRAWING AUTHORISED FOR PUBLICATION  Inga Condric 2015.06.04 15:22:55+10'00" f0r ASSET ENGINEERING MANAGER STRATEGIC ASSET MANAGEMENT </div> |
| | | | | | <div style="text-align: center;"> DESIGN APPROVED  C.Wood SENIOR CO-ORDINATOR NATURAL ENVIRONMENT ASSET SERVICES/BRISBANE INFRASTRUCTURE </div> |
| DESIGN | CPO - P&D | DATE | NOV '14 | |  |
| DRAWN | CPO - P&D | DATE | NOV '14 | | |
| CHECKED | BI - FSG - AS | DATE | NOV '14 | | |
| DRAWING FILENAME | BSD-10145 B3 Small_Medium_Large shelters - Natural area - General notes - Sheet 1 of 5dwg | | | | |
| ASSOCIATED PLANS | BSD-10145-Sheets 2,3,4 & 5 | | | | |

STEELWORK NOTES

- S1. ALL WORKMANSHIP & MATERIALS SHALL BE IN ACCORDANCE WITH AS4100 & AS/NZS1554.
- S2. ALL STEEL SHALL BE IN ACCORDANCE WITH:
AS1163 GRADE C350LO FOR RECTANGULAR AND SQUARE HOLLOW SECTIONS UNO
- S3. ALL BOLTS TO BE METRIC HEXAGONAL TO AS 1252 U.N.O.
ALL BOLTS TO BE M16 4.6/S TO AS/NZS 1252 U.N.O.
ALL BOLTS TO BE HOT DIP GALVANISED TO AS 1214 U.N.O.
- S4. ALL CLEATS AND GUSSETS SHALL BE 10mm PLATE TO AS/NZS3678 GRADE 250 U.N.O.
- S5. METAL ROOF CLADDING TO BE 0.42 BMT LYSAGHT CUSTOM ORB WITH A COLORBOND FINISH OR APPROVED EQUAL FIXED AS PER MANUFACTURER'S SPECIFICATIONS – COLORBOND COLOUR AS PER SPECIFICATION.
- S6. ALL WELDS TO BE 6mm CONTINUOUS FILLET WELDS (CFW) STRUCTURAL PURPOSE (SP) WELDS U.N.O. ALL WELDS TO BE MADE USING E48XX OR W50X GRADE 1 (OR BETTER) ELECTRODES TO AS/NZS 1554. GRIND ALL CORNERS & WELDS SMOOTH.
- S7. ALL STEELWORK TO BE HOT DIP GALVANISED IN ACCORDANCE WITH AS/NZS 2312 HDG600 SPECIFICATION. SURFACE PREPARATION FOR CORROSION PROTECTION COATING IS TO BE CLASS 2½ TO AS 1627 AND PICKLED PRIOR GALVANISING. HOT DIPPED GALVANISED COATING SHALL BE IN ACCORDANCE WITH AS/NZS 4680.
- S8. ANY POST GALVANISING DAMAGE TO BE MADE GOOD WITH HIGH QUALITY TWO PACK EPOXY ZINC RICH PAINT CONFORMING TO AS/NZS 3750.9 WITH A MINIMUM DRY FILM THICKNESS OF 100 MICRONS. SURFACE PREPARATION TO BE ACCORDING TO PAINT MANUFACTURER'S RECOMMENDATIONS.
- S9. THE ENDS OF ALL TUBULAR OR HOLLOW MEMBERS ARE TO BE SEALED WITH 6mm THICK PLATES AND CONTINUOUS FILLET WELDED U.N.O.
- S10. PROTECTIVE COATINGS TO BE APPLIED AFTER ALL FABRICATION COMPLETED. NO WELDING ETC TO BE CARRIED OUT DURING OR AFTER APPLICATION OF COATING SYSTEM.
- S11. THE PRINCIPAL CONTRACTOR SHALL CONFER WITH THE FABRICATOR AND GALVANISER TO ENSURE VENT HOLES ARE PROVIDED IN ACCORDANCE WITH AS/NZS 4680.

| STEEL MEMBER SCHEDULE | |
|-----------------------|---|
| MARK | MEMBER |
| C1 | 100 x 4 SHS COLUMN |
| C2 | 150 x 6 SHS COLUMN |
| P1 | 100 x 50 x 4 RHS PURLINS, 900 MAX. INTERNAL CRS. U.N.O. |
| R1 | 100 x 4 SHS RAFTER |
| R2 | 150 x 6 SHS RAFTER |
| S1 | 100 x 4 SHS STRUT |


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| B | Drawing Title Amended | FEB '16 | JUL '16 | JUL '16 |
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| for ASSET ENGINEERING MANAGER STRATEGIC ASSET MANAGEMENT | | | |
| DESIGN APPROVED | | | |
| C.Wood | | | |
| SENIOR CO-ORDINATOR NATURAL ENVIRONMENT ASSET SERVICES/BRISBANE INFRASTRUCTURE | | | |


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| CHECKED | BI - FSG - AS | DATE | NOV '14 |
| DRAWING FILENAME | BSD-10145 BI Small_Medium_Large shelters - Natural area - General notes - Sheet 2 of 5.dwg | | |
| ASSOCIATED PLANS | BSD-10145-Sheets 1,3,4 & 5 | | |




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| BRISBANE CITY COUNCIL STANDARD DRAWING | | |
| SMALL/MEDIUM/LARGE SHELTERS NATURAL AREA – GENERAL NOTES SHEET 2 OF 5 | | SCALE N.T.S |
| | | DWG No. BSD–10145 |
| | | ORIGINAL SIZE A3 REVISION B |

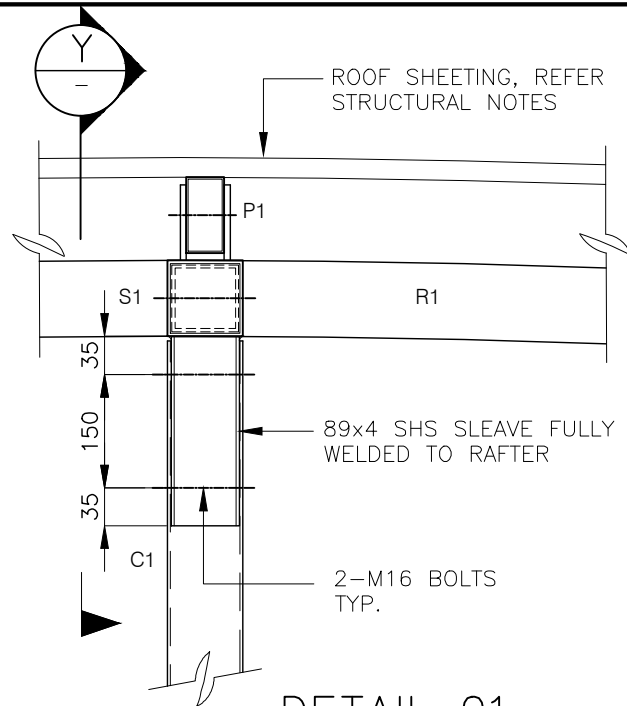


DETAIL 01
SCALE 1:10

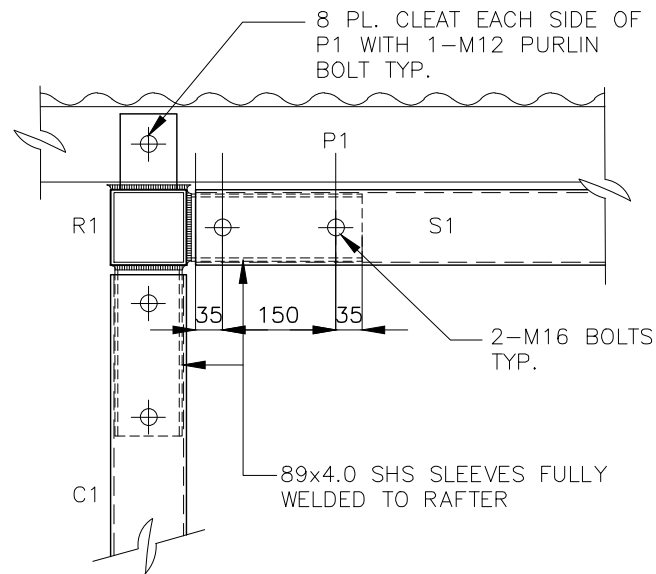


SECTION Y
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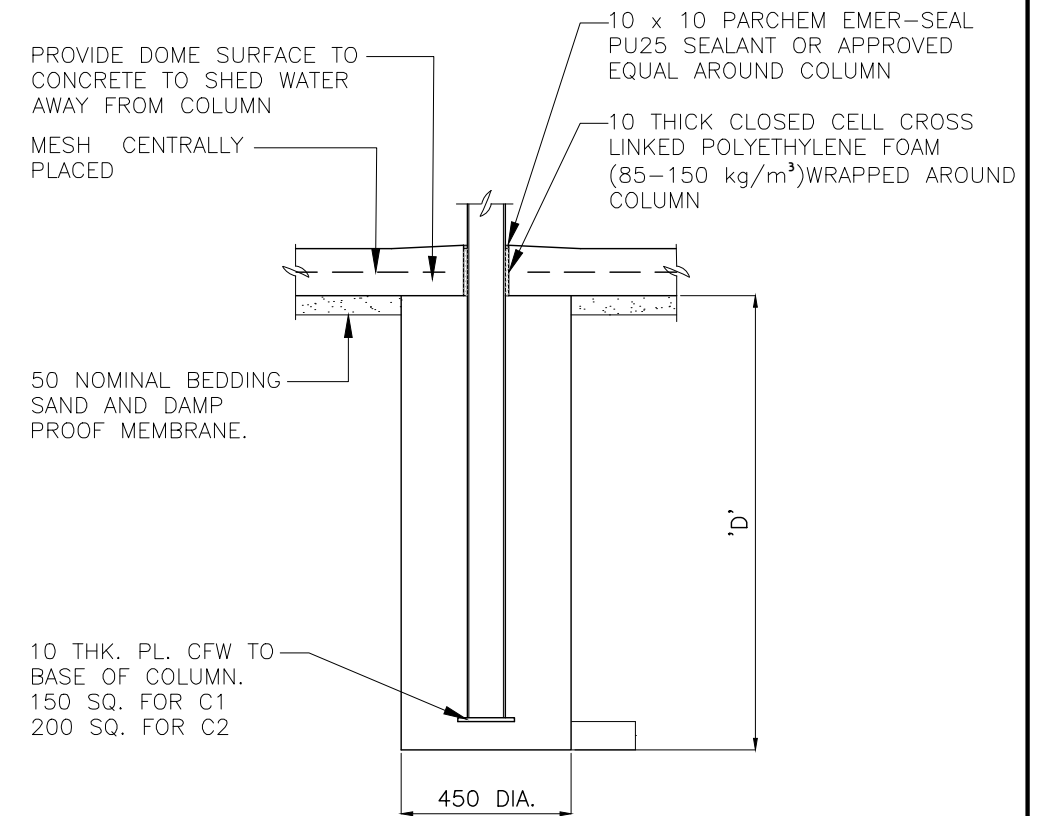
DETAIL 02
SCALE 1:10

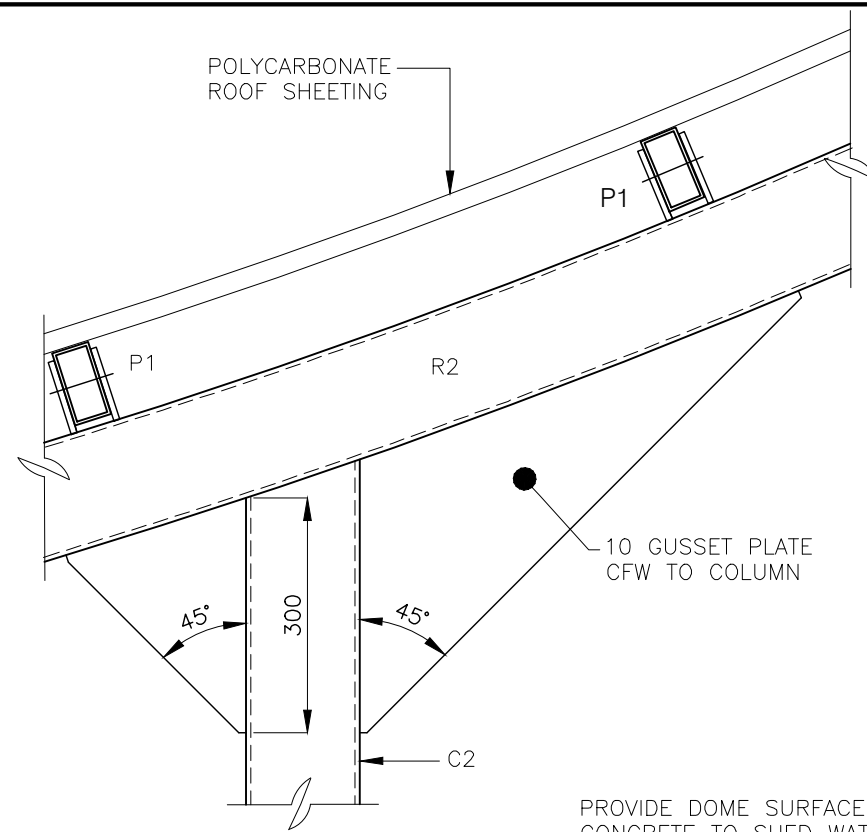

DETAIL 03
SCALE 1:10

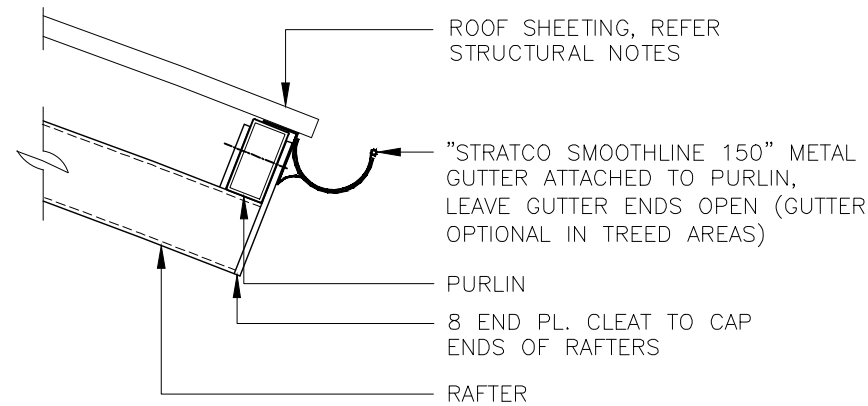


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SCALE 1:10

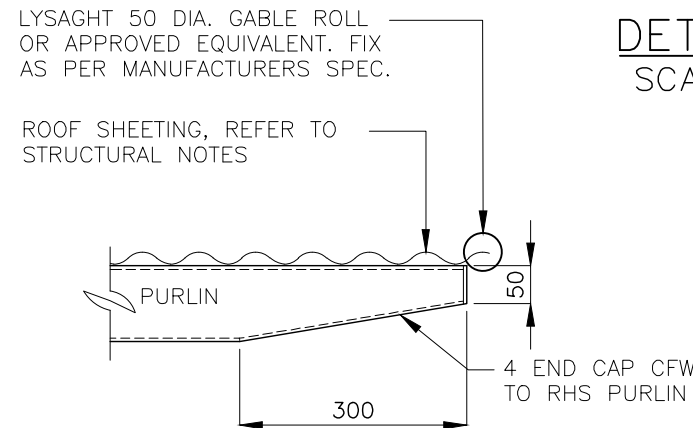

TYPICAL FOOTING DETAIL
SCALE 1:20


GENERAL NOTES


- REFER TO BSD-10145 SHEET 1 AND 2 FOR STRUCTURAL NOTES.
- REFER TO BSD-10145 SHEET 2 FOR STEEL MEMBER SCHEDULE.
- FOR SHELTER PLANS, SECTIONS AND ELEVATIONS REFER TO:
 - BSD-10141 - SMALL SHELTER - SHEETS 1 TO 2
 - BSD-10142 - MEDIUM/LARGE SHELTER - SHEETS 1 TO 2
 - BSD-10143 - LARGE SHELTER - SHEETS 1 TO 2
 - BSD-10144 - SMALL INFORMATION SHELTER

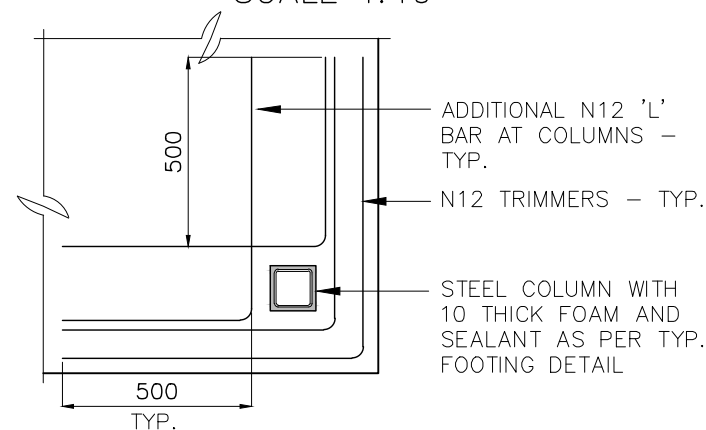


TYPICAL CORNER DETAIL
SCALE 1:20

| STRUCTURAL DESIGN CERTIFICATION | | | |
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| DESIGN | | DESIGN CHECK | AUTHORISED FOR ISSUE |
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| BRISBANE CITY COUNCIL STANDARD DRAWING | | | |
| SMALL/MEDIUM/LARGE SHELTERS NATURAL AREA – DETAILS SHEET 3 OF 5 | | | SCALE AS SHOWN |
| | | | DWG No. BSD-10145 |
| | | | ORIGINAL SIZE A3 |


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| | | | | | | DRAWN | CP0 - P&D | DATE | NOV '14 | |
| | | | | | | CHECKED | BI - FSG - AS | DATE | NOV '14 | |
| | | | | | | DRAWING FILENAME | BSD-10145 (B) Small_Medium_Large shelters - Natural area - Details - Sheet 3 of 5.dwg | | | |
| B | Drawing Title Amended | FEB '16 | JUL '16 | JUL '16 | ASSOCIATED PLANS | BSD-10145-Sheets 1,2,4 & 5 | | | | |
| A | ORIGINAL ISSUE | NOV '14 | NOV '14 | NOV '14 | | | | | | |
| ISSUE | AMENDMENT | DRAWN DATE | CHK'D DATE | APPR'D DATE | | | | | | |

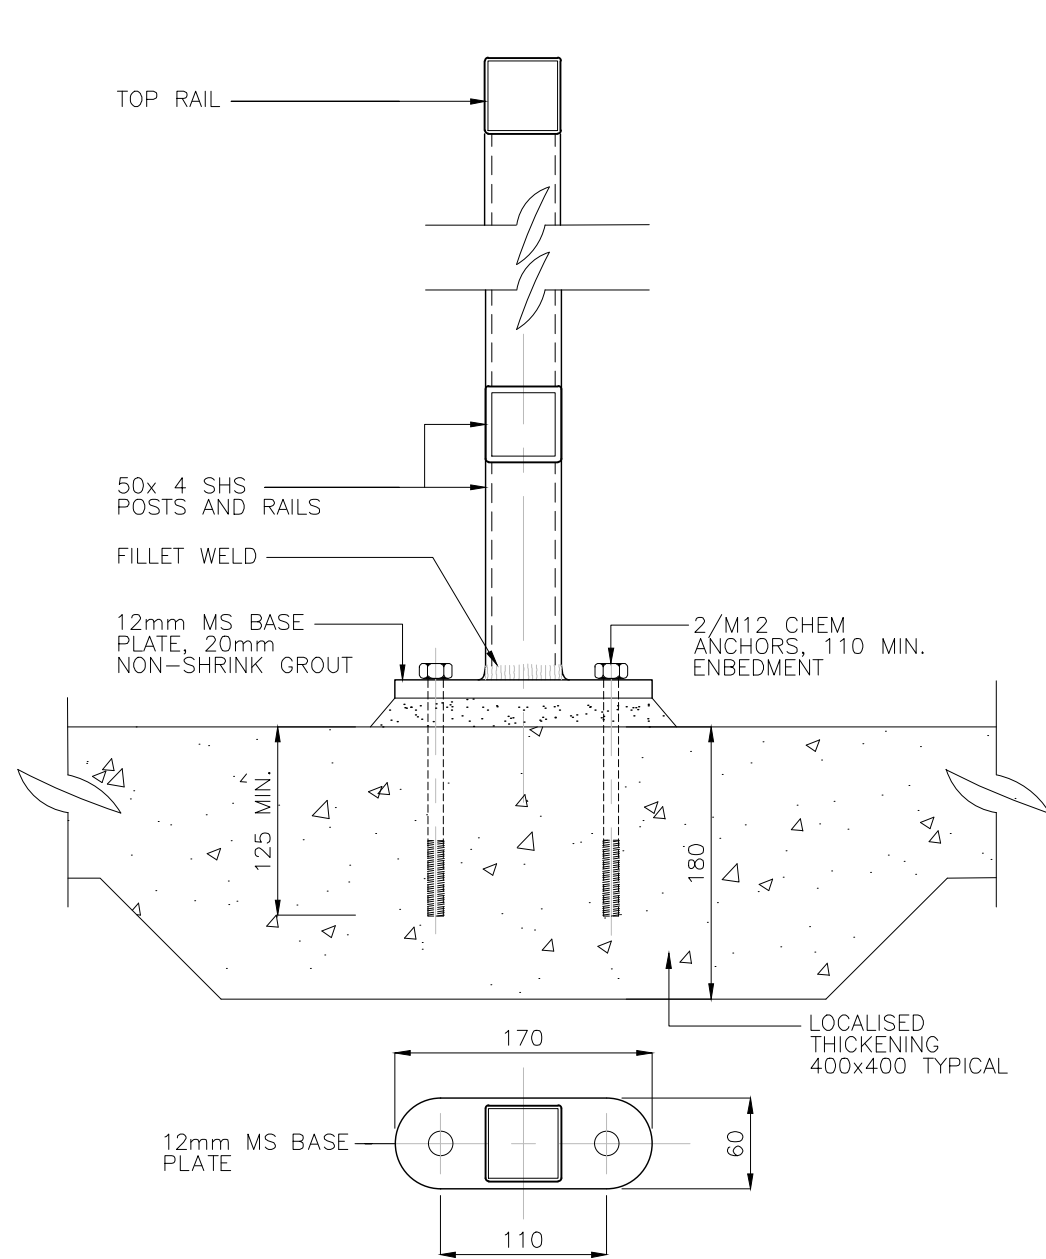

DETAIL 09 – SCREEN TO
MID/END POST DETAIL
SCALE 1:5

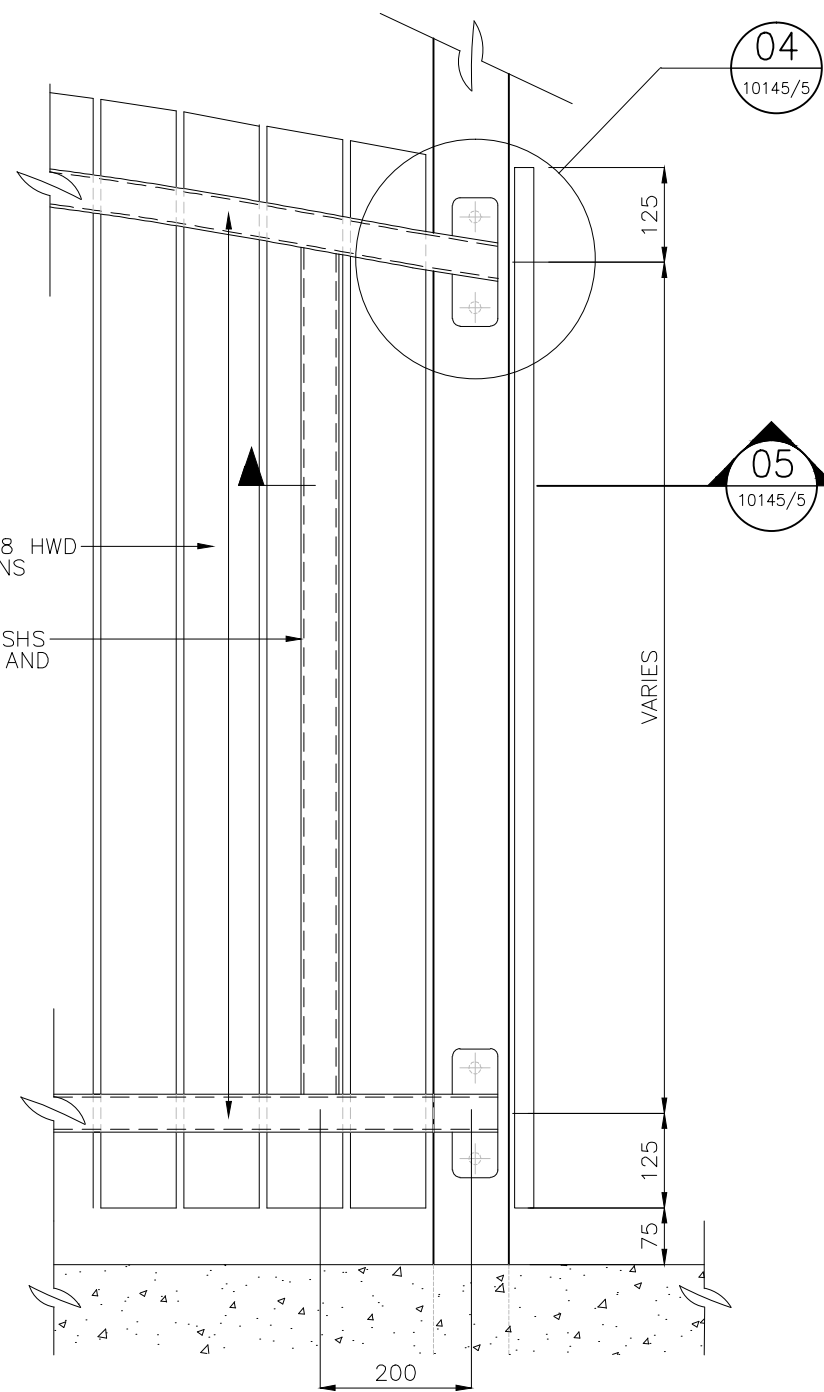

DETAIL 10 – SCREEN TO
SHELTER POST DETAIL
SCALE 1:10

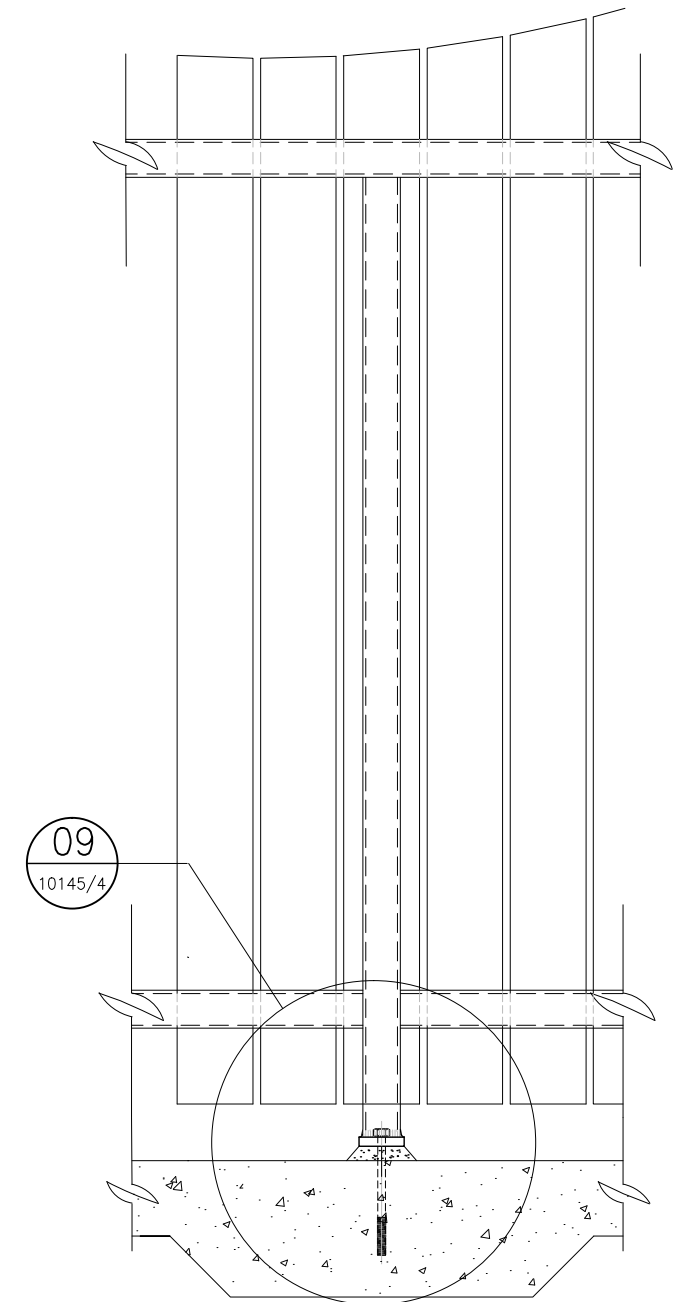

DETAIL 11 – SCREEN TO
MID-POST DETAIL
SCALE 1:10

GENERAL NOTES

1. REFER TO BSD-10145 SHEET 1 AND 2 FOR STRUCTURAL NOTES.
2. REFER TO BSD-10145 SHEET 3 & 5 FOR SHELTER AND SCREEN DETAILS.
3. FOR SHELTER PLANS, SECTIONS AND ELEVATIONS REFER TO:
 - BSD-10141 – SMALL SHELTER – SHEETS 1 TO 2
 - BSD-10142 – MEDIUM/LARGE SHELTER – SHEETS 1 TO 2
 - BSD-10143 – LARGE SHELTER – SHEETS 1 TO 2
 - BSD-10144 – SMALL INFORMATION SHELTER


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| B | Drawing Title Amended | FEB '16 | JUL '16 | JUL '16 |
| A | ORIGINAL ISSUE | NOV '14 | NOV '14 | NOV '14 |

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| C.Wood SENIOR CO-ORDINATOR NATURAL ENVIRONMENT ASSET SERVICES/BRISBANE INFRASTRUCTURE | | | |


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| CHECKED | BI - FSG - AS | DATE | NOV '14 |
| DRAWING FILENAME | BSD-10145 BI Small_Medium_Large shelters - Natural area - Screen details - Sheet 4 of 5.dwg | | |
| ASSOCIATED PLANS | BSD-10145-Sheets 1,2,3 & 5 | | |




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| BRISBANE CITY COUNCIL STANDARD DRAWING | | |
| SMALL/MEDIUM/LARGE SHELTERS NATURAL AREA – SCREEN DETAILS SHEET 4 OF 5 | | |
| SCALE | AS SHOWN | |
| DWG No. | BSD-10145 | |
| ORIGINAL SIZE | A3 | REVISION B |

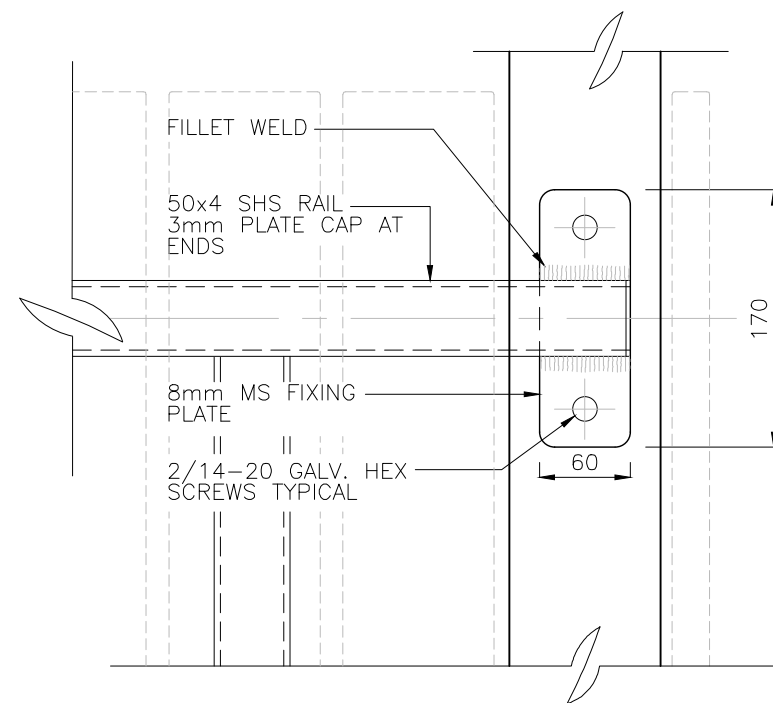


**DETAIL 04 – RAIL END CONNECTION
TO SHELTER POST – ELEVATION**
SCALE 1:5

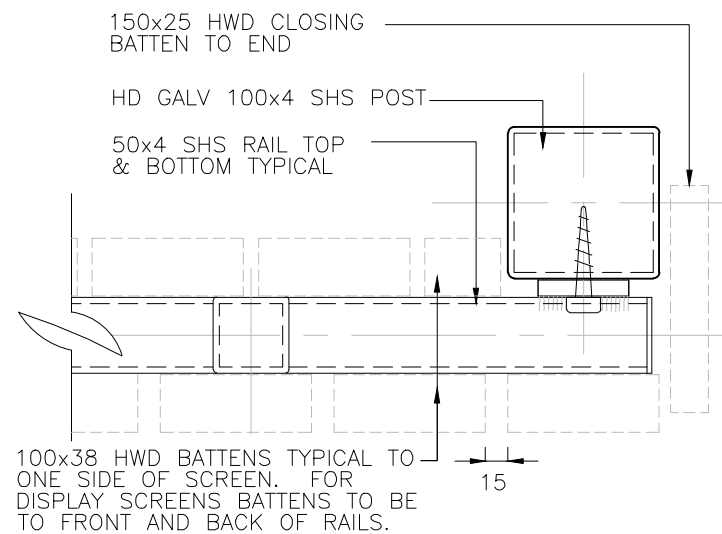


**DETAIL 05 – RAIL END CONNECTION
TO SHELTER POST – SECTION**
SCALE 1:5

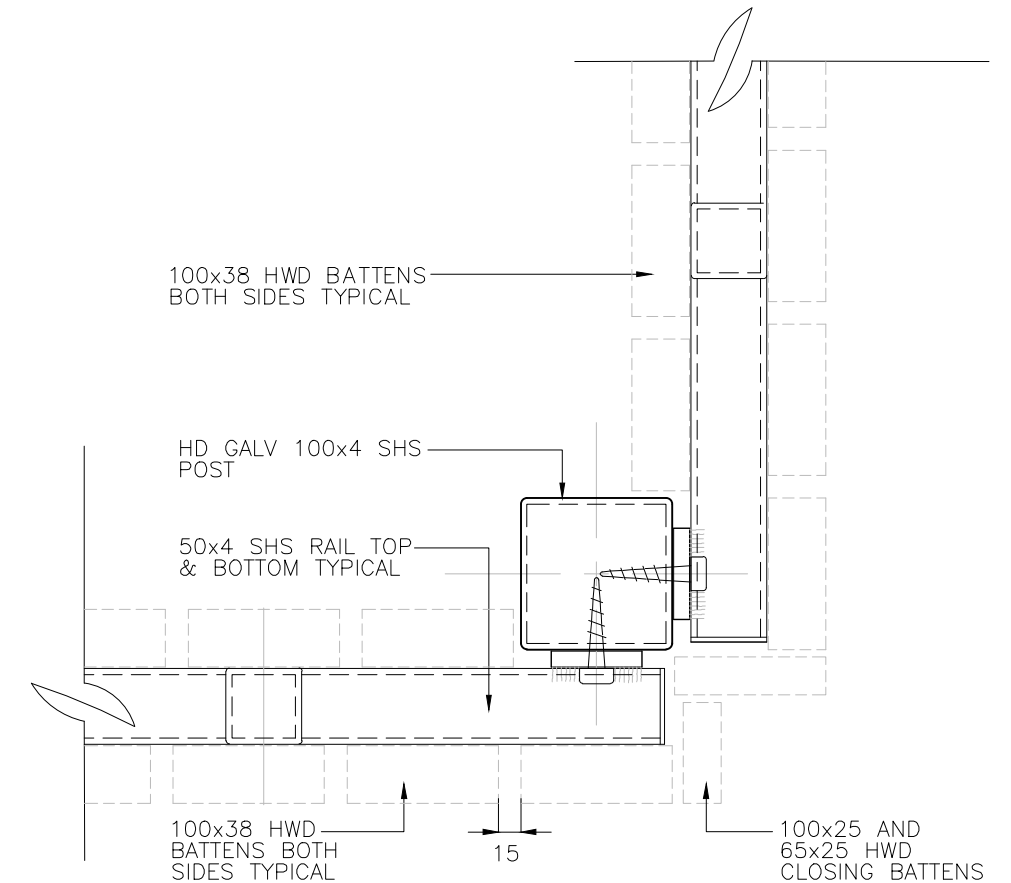

**DETAIL 06 – CORNER
DETAIL FOR DISPLAY
SCREENS TO SHELTER POST**
SCALE 1:5

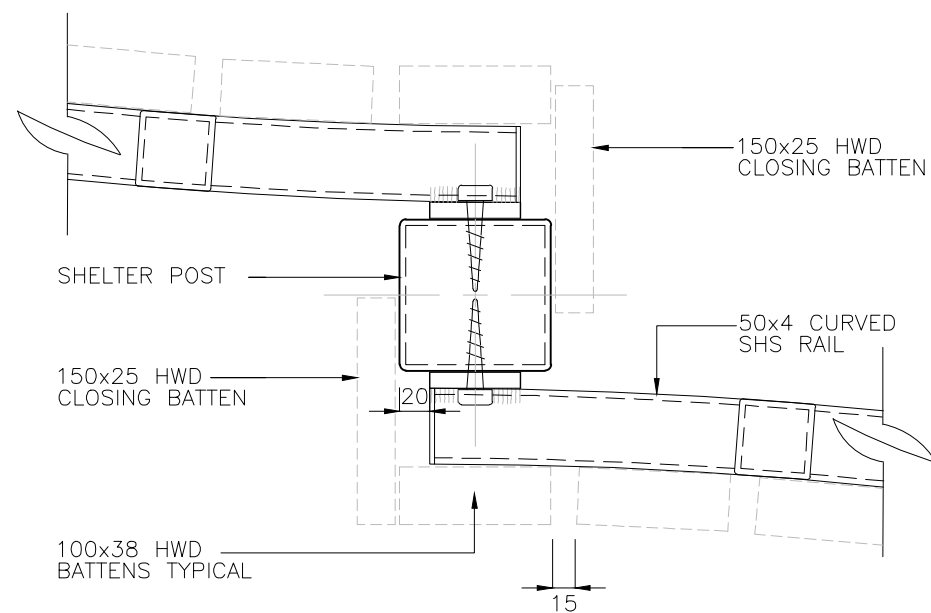

**DETAIL 07 – DIVIDING WALL – RAIL
CONNECTION TO SHELTER POST – SECTION**
SCALE 1:5

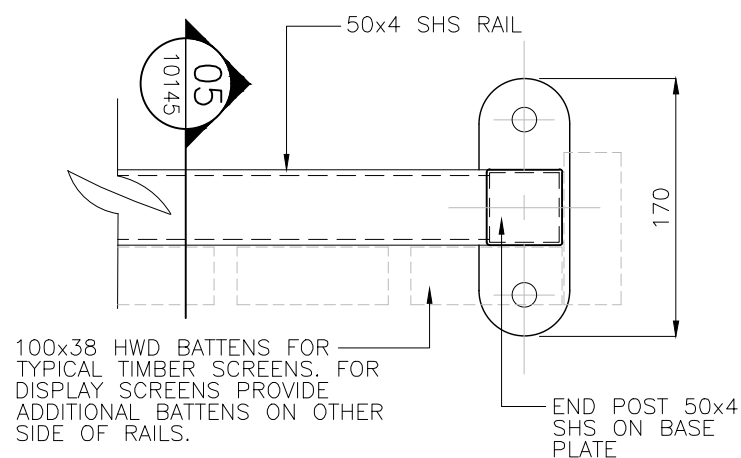

**DETAIL 08 – MID AND
END POST – BASE
PLATE – PLAN**
SCALE 1:5

GENERAL NOTES


- REFER TO BSD-10145 SHEET 1 AND 2 FOR STRUCTURAL NOTES.
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 - BSD-10143 – LARGE SHELTER – SHEETS 1 TO 2
 - BSD-10144 – SMALL INFORMATION SHELTER

STRUCTURAL DESIGN CERTIFICATION

| DESIGN | DESIGN CHECK | AUTHORISED FOR ISSUE |
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| BRISBANE CITY COUNCIL STANDARD DRAWING | |
|---|-----------------------------|
| SMALL/MEDIUM/LARGE SHELTERS NATURAL AREA – SCREEN DETAILS SHEET 5 OF 5 | SCALE AS SHOWN |
| | DWG No. BSD-10145 |
| | ORIGINAL SIZE A3 REVISION B |

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| | | | | | | CHECKED | BI - FSG - AS | DATE | NOV '14 |
| B | Drawing Title Amended | FEB '16 | JUL '16 | JUL '16 | DESIGN APPROVED C.Wood ----- SENIOR CO-ORDINATOR NATURAL ENVIRONMENT ASSET SERVICES/BRISBANE INFRASTRUCTURE | DRAWING FILENAME | BSD-10145 BI Small_Medium_Large shelters - Natural area - Screen details - Sheet 5 of 5.dwg | | |
| A | ORIGINAL ISSUE | NOV '14 | NOV '14 | NOV '14 | | ASSOCIATED PLANS | BSD-10145-Sheets 1,2,3 & 4 | | |
| ISSUE | AMENDMENT | DRAWN DATE | CHK'D DATE | APPR'D DATE | | | | | |



BRISBANE CITY



G1 THE BUILDER SHALL BE RESPONSIBLE FOR MAINTAINING STABILITY OF THE STRUCTURE UNTIL COMPLETION OF CONSTRUCTION AND SHALL ENSURE THAT NO PART OF THE STRUCTURE IS OVERSTRESSED.

G2 THE BUILDER SHALL CHECK ALL DIMENSIONS AND ALL EXISTING CONDITIONS BEFORE COMMENCING CONSTRUCTION.

G3 ANY DAMAGE CAUSED BY THE CONTRACTOR SHALL BE MADE GOOD AT THEIR OWN COST.

G4 ALL MATERIALS AND WORKMANSHIP SHALL BE IN ACCORDANCE WITH THE CURRENT EDITIONS OF THE FOLLOWING AUSTRALIAN STANDARDS, EXCEPT WHERE VARIED BY THE SPECIFICATIONS AND/OR DRAWINGS: —

AS 1684.2 (2010) RESIDENTIAL TIMBER FRAMED CONSTRUCTION

AS 1720.1 (2010) TIMBER STRUCTURES

AS 2870 (2011) RESIDENTIAL SLABS AND FOOTINGS

AS 3600 (2009) CONCRETE STRUCTURES

AS 3798 (2007) GUIDELINES ON EARTHWORKS FOR COMMERCIAL AND RESIDENTIAL DEVELOPMENTS

AS 4100 (1998) STEEL STRUCTURES

G5 DIMENSIONS SHALL NOT BE OBTAINED BY SCALING THE STRUCTURAL DRAWINGS.

G6 ALL DIMENSIONS ARE IN MILLIMETRES UNLESS NOTED OTHERWISE

G7 U.N.O. DENOTES UNLESS NOTED OTHERWISE.

G8 THE CONTRACTOR SHALL VISIT THE SITE PRIOR TO TENDERING TO FAMILIARISE THEMSELVES WITH ACCESS SITE CONDITIONS

G9 THE CONTRACTOR MAY OFFER FOR CONSIDERATION ALTERNATIVE PROVEN EQUAL PRODUCTS TO THOSE INDICATED. ALTERNATIVE PRODUCTS ARE NOT TO ADVERSELY AFFECT THE PROJECT AND CANNOT BE SUBSTITUTED WITHOUT PRIOR APPROVAL.

G10 EXISTING SERVICES TO BE LOCATED BEFORE CONSTRUCTION COMMENCES.

G11 THIS DRAWING IS TO BE READ IN CONJUNCTION WITH SHEET 2 TO 5.

G12 CONSULT BCC ARCHITECT FOR COLOUR SCHEME OF THE STRUCTURE.

WIND LOADS : REGION B TERRAIN CATEGORY 1.5
 ULTIMATE WIND SPEED = 54.0 m/s
 DESIGN LIFE : 50 YEARS WITH ROUTINE MAINTENANCE.
 LIVE LOADS: : FLOOR = 5.0 kPa. ROOF= 0.25 kPa / 1.4 kN.
 NO SCREENS(IMPERMEABLE OR PERMEABLE BARRIERS) TO BE
 INSTALLED UNLESS SHOWN ON THE DRAWINGS.

TERRAIN CATEGORY 1.5 CORRESPONDS TO AN ENVIRONMENT WITH OPEN WATER SURFACES, SUBJECTED TO SHOALING WAVES AT SERVICEABILITY AND ULTIMATE WIND SPEEDS IN ALL WIND REGIONS.

| | |
|----|---|
| F1 | ALL FOOTINGS ARE TO BE FOUNDED IN THE NATURAL UNDISTURBED SOIL PROFILE WITH A MINIMUM ALLOWABLE SOIL BEARING CAPACITY OF 100kPa UNLESS NOTED OTHERWISE. IF SITE CONDITION IS DIFFERENT, CONSULT A STRUCTURAL ENGINEER |
| F2 | SOIL TEST IS REQUIRED TO CONFIRM BEARING CAPACITY AND SITE CLASSIFICATION TO AS 2870. |
| F3 | FOUNDATIONS ARE TO BE CHECKED AND CERTIFIED BY A REGISTERED PROFESSIONAL GEOTECHNICAL ENGINEER, QUEENSLAND (RPEQ). |
| F4 | COMPACT AND PREPARE THE BASE TO PROVIDE A SOUND PLATFORM AND ANY ORGANIC, SOFT OR LOOSE MATERIALS REMOVED AND REPLACED WITH COMPACTED FILL – BCC SPECIFICATION S300 QUARRY PRODUCTS CLASS 1 MATERIAL. |
| F5 | THE BOTTOMS OF ALL FOOTINGS ARE TO BE CLEANED OF ALL LOOSE MATERIAL AND WATER PRIOR TO POURING CONCRETE. |
| F6 | SLABS ON GRADE SHALL BE UNDERLAIN WITH CONTINUOUS LAYER OF 200 MICRON (0.2mm) THICK POLYETHYLENE DAMPPROOF MEMBRANE AS PER AS 2870, LAPPED AND TAPED TO MANUFACTURER'S SPECIFICATION. |

E1 STRIP ALL HUMUS MATERIAL FROM THE AREA OF THE BUILDING IMPRINT AND 1000 BEYOND.

E2 PROOF ROLL THE AREAS TO BE CONCRETED AND PAVED. REMOVE ANY WEAK MATERIAL.

E3 USE NON-HUMUS CUT MATERIAL OR IMPORTED APPROVED NON-REACTIVE SOIL AS FILL.

E4 COMPACTED FILL SHALL BE COMPACTED IN LAYERS NOT EXCEEDING 150mm LOOSE DEPTH TO 98% MAXIMUM DRY DENSITY IN ACCORDANCE WITH AS 1289. 5.1.1 (STANDARD COMPACTION). CARRY OUT DENSITY TESTS AT A RATE OF 2 PER LEVEL OF FILL. EVERY TEST MUST PASS.

C1 ALL WORKMANSHIP AND MATERIAL SHALL BE IN ACCORDANCE WITH AS 3600.

C2 ALL CONCRETE SHALL BE PREMIXED BY AN APPROVED SUPPLIER.

C3 ALL CEMENT SHALL BE TYPE GP OR GB.

C4 CONCRETE SPECIFICATION: NOMINAL AGGREGATE SIZE TO BE 20mm, SLUMP TO BE NOT GREATER THAN 80mm.

C5 CONCRETE STRENGTH AND CLEAR CONCRETE COVER TO REINFORCEMENT SHALL BE IN ACCORDANCE WITH THE FOLLOWING TABLE U.N.O.ELEMENT:

| F'C (MPa) | REINFORCEMENT COVER |
|-----------|---------------------|
| PIERS | 32 |
| SLAB | 32 |

CENTRALLY PLACED.

C6 ALL LAPS IN REINFORCEMENT SHALL BE AS SHOWN IN THE TABLE BELOW UNLESS NOTED OTHERWISE.

| BAR LAP LENGTH (mm) | |
|---------------------|-----|
| N12 | 500 |
| N16 | 650 |
| MESH | 350 |

C7 REINFORCEMENT SYMBOLS: R STRUCTURAL PLAIN ROUND GRADE 250R TO AS 4671.

N DEFORMED BAR GRADE D500N TO AS 4671.

SL HARD DRAWN STEEL REINFORCING FABRIC GRADE D500L TO AS 4671.

C8 SIZES OF CONCRETE ELEMENTS DO NOT INCLUDE THICKNESS OF APPLIED FINISHES.

C9 NO HOLES, CHASES OR EMBEDMENT OF PIPES OTHER THAN THOSE SHOWN ON THE STRUCTURAL DRAWINGS SHALL BE MADE IN CONCRETE MEMBERS WITHOUT PRIOR APPROVAL BY THE SUPERINTENDENT.

C10 ALL CONCRETE SHALL BE COMPACTED USING A MECHANICAL VIBRATION PROCESS.


C11 ALL REINFORCEMENT SHALL BE SECURELY SUPPORTED IN ITS CORRECT POSITION DURING CONCRETING BY APPROVED BAR CHAIRS, SPACERS OR SUPPORT BARS.


C12 CONSTRUCTION JOINTS SHALL BE PROPERLY FORMED AND USED ONLY WHERE SHOWN OR SPECIFICALLY APPROVED BY THE SUPERINTENDENT.

- T1 ALL WORKMANSHIP AND MATERIAL SHALL BE IN ACCORDANCE WITH AS 1720 AND AS 1684.
- T2 TIMBER GRADES SHALL BE AS SHOWN ON THE DRAWINGS. ALL TIMBER TO BE SEASONED OR KILN DRIED GRADE MGP12 MINIMUM U.N.O WITH NATURAL DURABILITY CLASS 4 (ABOVE GROUND) OR BETTER.
- T3 ALL FASTENERS SHALL BE HOT DIP GALVANISED. BOLTS TO BE METRIC HEX-HEAD M16 MINIMUM WITH WASHERS U.N.O. CLEAT PLATES TO BE 10mm THICK U.N.O.
- T4 TIMBER JOINT GROUP JD4 OR BETTER.
- T5 ALL TIMBER SHALL BE FULLY DRESSED AND ALL EDGES, ENDS AND CORNERS TO BE 6mm DRESSED.
- T6 PROTECT ENDS OF EXPOSED MEMBERS. USE A HIGH QUALITY EXTERIOR PAINT FINISH.
- T7 ALL TIMBER FRAMING SHALL BE NATURALLY TERMITE RESISTANT OR TREATED USING LOSP OR ACQ CHEMICALS TO A HAZARD RESISTANCE LEVEL H3 IN ACCORDANCE WITH AS 1684.2 APPENDIX B.
- T8 ALL TIMBER TO BE STAINED OR PAINTED PRIOR TO FIXING INTO FINAL POSITION. REFER TO PROJECT SPECIFICATION FOR EACH PROJECT.


- S1. ALL WORKMANSHIP & MATERIALS SHALL BE IN ACCORDANCE WITH AS4100 & AS/NZS1554.
- S2. ALL STEEL SHALL BE IN ACCORDANCE WITH:
AS1163 GRADE C350LO FOR RECTANGULAR AND SQUARE HOLLOW SECTIONS UNO
- S3. ALL BOLTS TO BE METRIC HEXAGONAL TO AS 1252 U.N.O.
ALL BOLTS TO BE M16 4.6/S TO AS/NZS 1252 U.N.O.
ALL BOLTS TO BE HOT DIP GALVANISED TO AS 1214 U.N.O.
- S4. ALL CLEATS AND GUSSETS SHALL BE 10mm PLATE TO AS/NZS3678 GRADE 250 U.N.O.
- S5. METAL ROOF CLADDING TO BE 0.42 BMT LYSAGHT CUSTOM ORB WITH A COLORBOND FINISH OR APPROVED EQUAL FIXED AS PER MANUFACTURER'S SPECIFICATIONS - COLORBOND COLOUR AS PER SPECIFICATION.
- S6. ALL WELDS TO BE 6mm CONTINUOUS FILLET WELDS (CFW) STRUCTURAL PURPOSE (SP) WELDS U.N.O. ALL WELDS TO BE MADE USING E48XX OR W50X GRADE 1 (OR BETTER) ELECTRODES TO AS/NZS 1554. GRIND ALL CORNERS & WELDS SMOOTH.
- S7. ALL STEELWORK TO BE HOT DIP GALVANISED IN ACCORDANCE WITH AS/NZS 2312 HDG600 SPECIFICATION. SURFACE PREPARATION FOR CORROSION PROTECTION COATING IS TO BE CLASS 2½ TO AS 1627 AND PICKLED PRIOR GALVANISING. HOT DIPPED GALVANISED COATING SHALL BE IN ACCORDANCE WITH AS/NZS 4680.
- S8. ANY POST GALVANISING DAMAGE TO BE MADE GOOD WITH HIGH QUALITY TWO PACK EPOXY ZINC RICH PAINT CONFORMING TO AS/NZS 3750.9 WITH A MINIMUM DRY FILM THICKNESS OF 100 MICRONS. SURFACE PREPARATION TO BE ACCORDING TO PAINT MANUFACTURER'S RECOMMENDATIONS.
- S9. THE ENDS OF ALL TUBULAR OR HOLLOW MEMBERS ARE TO BE SEALED WITH 6mm THICK PLATES AND CONTINUOUS FILLET WELDED U.N.O.
- S10. PROTECTIVE COATINGS TO BE APPLIED AFTER ALL FABRICATION COMPLETED. NO WELDING ETC TO BE CARRIED OUT DURING OR AFTER APPLICATION OF COATING SYSTEM.
- S11. THE PRINCIPAL CONTRACTOR SHALL CONFER WITH THE FABRICATOR AND GALVANISER TO ENSURE VENT HOLES ARE PROVIDED IN ACCORDANCE WITH AS/NZS 4680.

A1 THE CONTRACTOR'S ENGINEER (RPEQ) SHALL UNDERTAKE INSPECTIONS DURING CONSTRUCTION TO ENSURE ALL CONSTRUCTION WORKS ARE IN ACCORDANCE WITH THE MOST CURRENT ISSUE OF THE STRUCTURAL DRAWINGS AND THE CONTRACT DOCUMENT. THE RPEQ SHALL CERTIFY ALL CONSTRUCTION WORK (FORM 16). ANY ALTERNATIVE TECHNIQUE USED IN CONSTRUCTION SHALL BE FOLLOWED BY A DESIGN CERTIFICATE (FORM 15) BY THE CONTRACTOR'S PROFESSIONAL ENGINEER (RPEQ).

| | | | | | | | | | | | | | | |
|-------|-----------------------|--|------------|------------|---|------------------|--|------|---------|---|--|-----------------------------|---------------|--|
| | | | | | DRAWING AUTHORISED FOR PUBLICATION | DESIGN | CPO - P&D | DATE | NOV '14 |  | BRISBANE CITY COUNCIL STANDARD DRAWING | | | |
| | | | | | Inga Condric 2015.06.04 15:29:02+10'00" for ASSET ENGINEERING MANAGER STRATEGIC ASSET MANAGEMENT | DRAWN | CPO - P&D | DATE | NOV '14 | | SIGN SHELTER – NATURAL AREA GENERAL NOTES SHEET 1 OF 3 | SCALE N.T.S. | | |
| B | Drawing Title Amended | | FEB '16 | JUL '16 | JUL '16 | CHECKED | BI - FSG - AS | DATE | NOV '14 | | | Dwg No. BSD-10146 | | |
| A | ORIGINAL ISSUE | | NOV '14 | NOV '14 | NOV '14 | DRAWING FILENAME | BSD-10146 (B) Sign shelter - Natural area - General notes - Sheet 1 of 3.dwg | | | | ORIGINAL SIZE A3 | | REVISION B | |
| ISSUE | AMENDMENT | | DRAWN DATE | CHK'D DATE | APPR'D DATE | ASSOCIATED PLANS | BSD-10146-Sheets 2 & 3 | | | | | | | |
| | | | | | | | | | | | | | | |

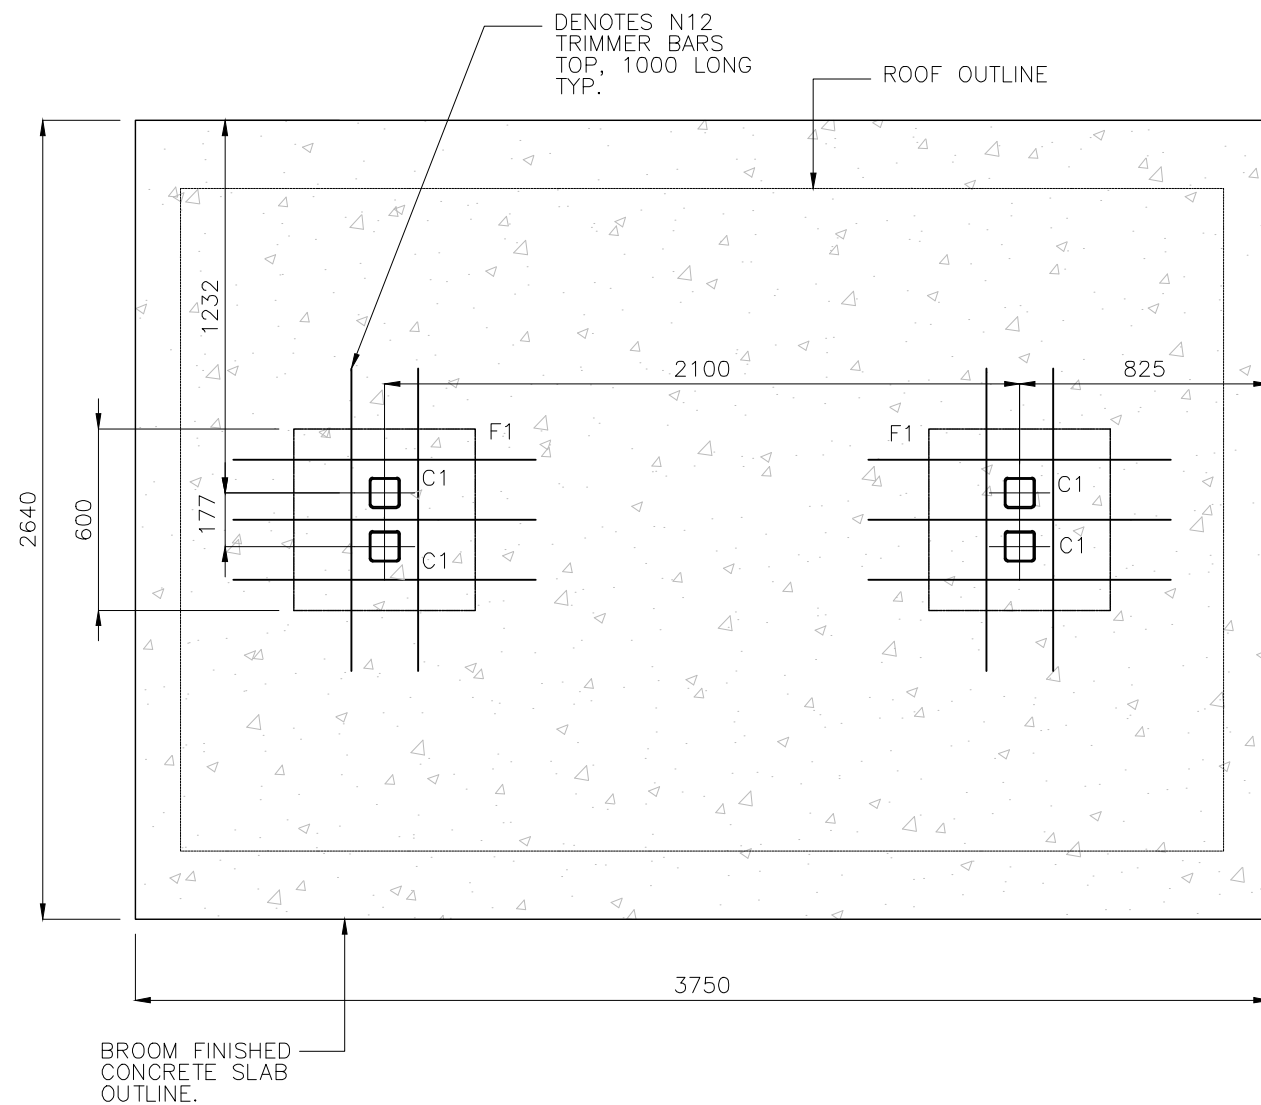

SLAB AND FOOTING PLAN
SCALE 1:25

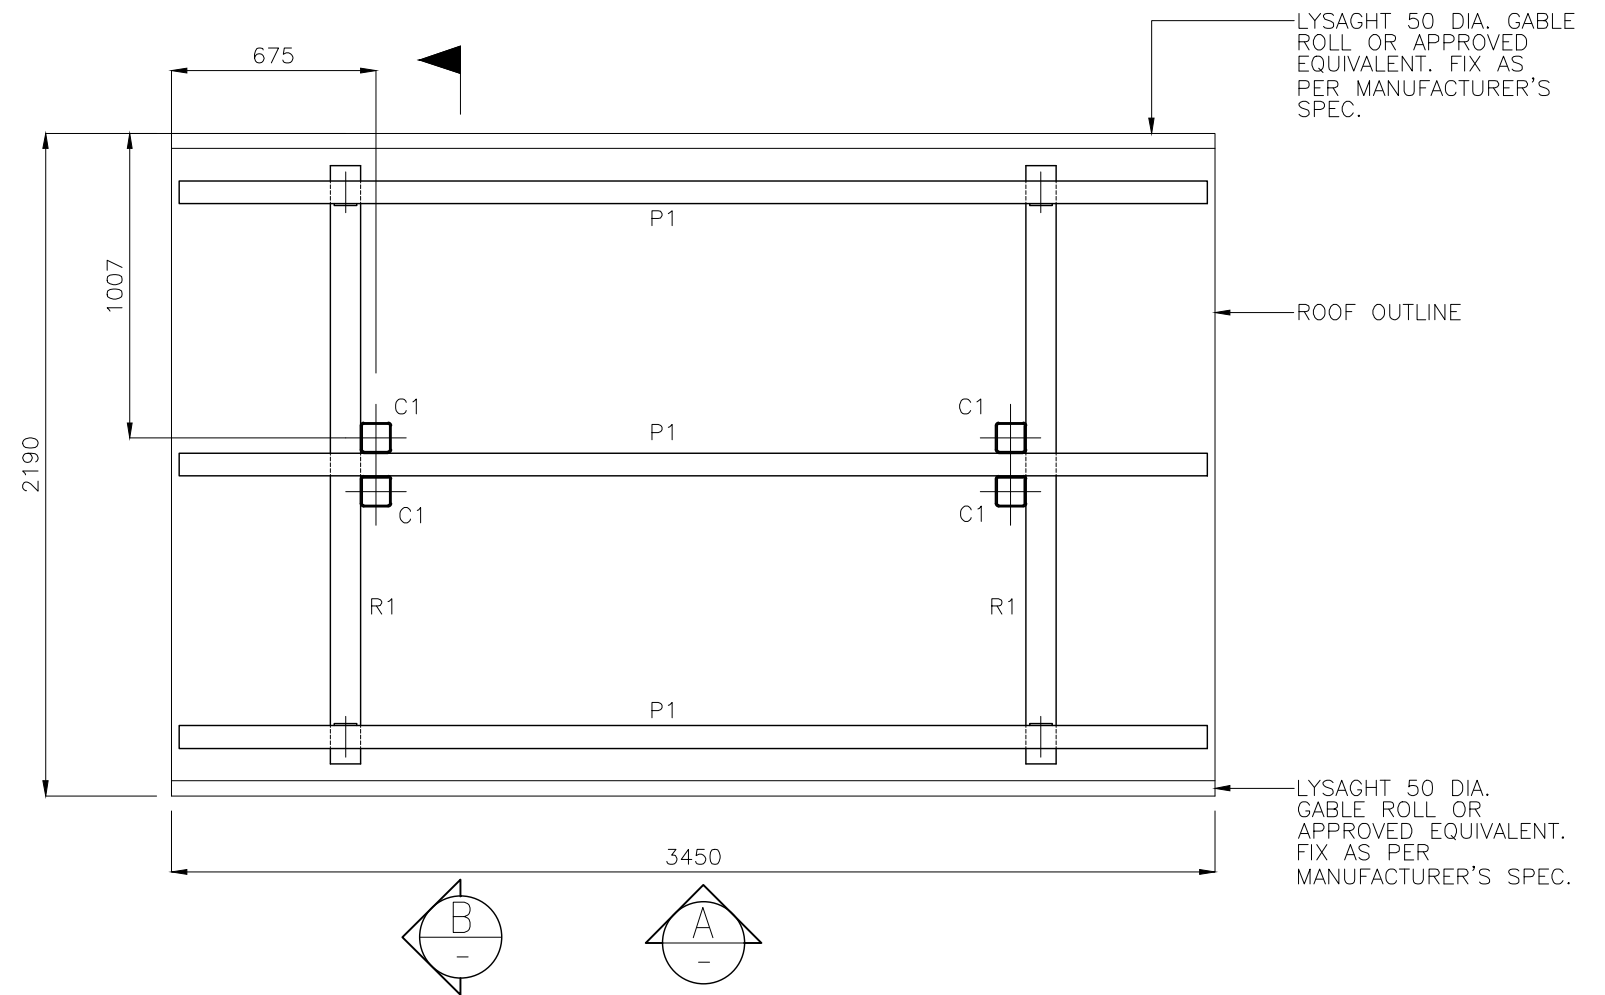

ROOF FRAMING PLAN
SCALE 1:25

MEMBER SCHEDULE

| MARK | MEMBER |
|------|-------------------------|
| B1 | 150 x 100 x 10 UA BEAM |
| C1 | 100 x 4 SHS COLUMN |
| H1 | 150 x 75 F17 HWD HEADER |
| P1 | 150 x 75 F17 HWD PURLIN |
| R1 | 152 x 76 x 5 RHS RAFTER |


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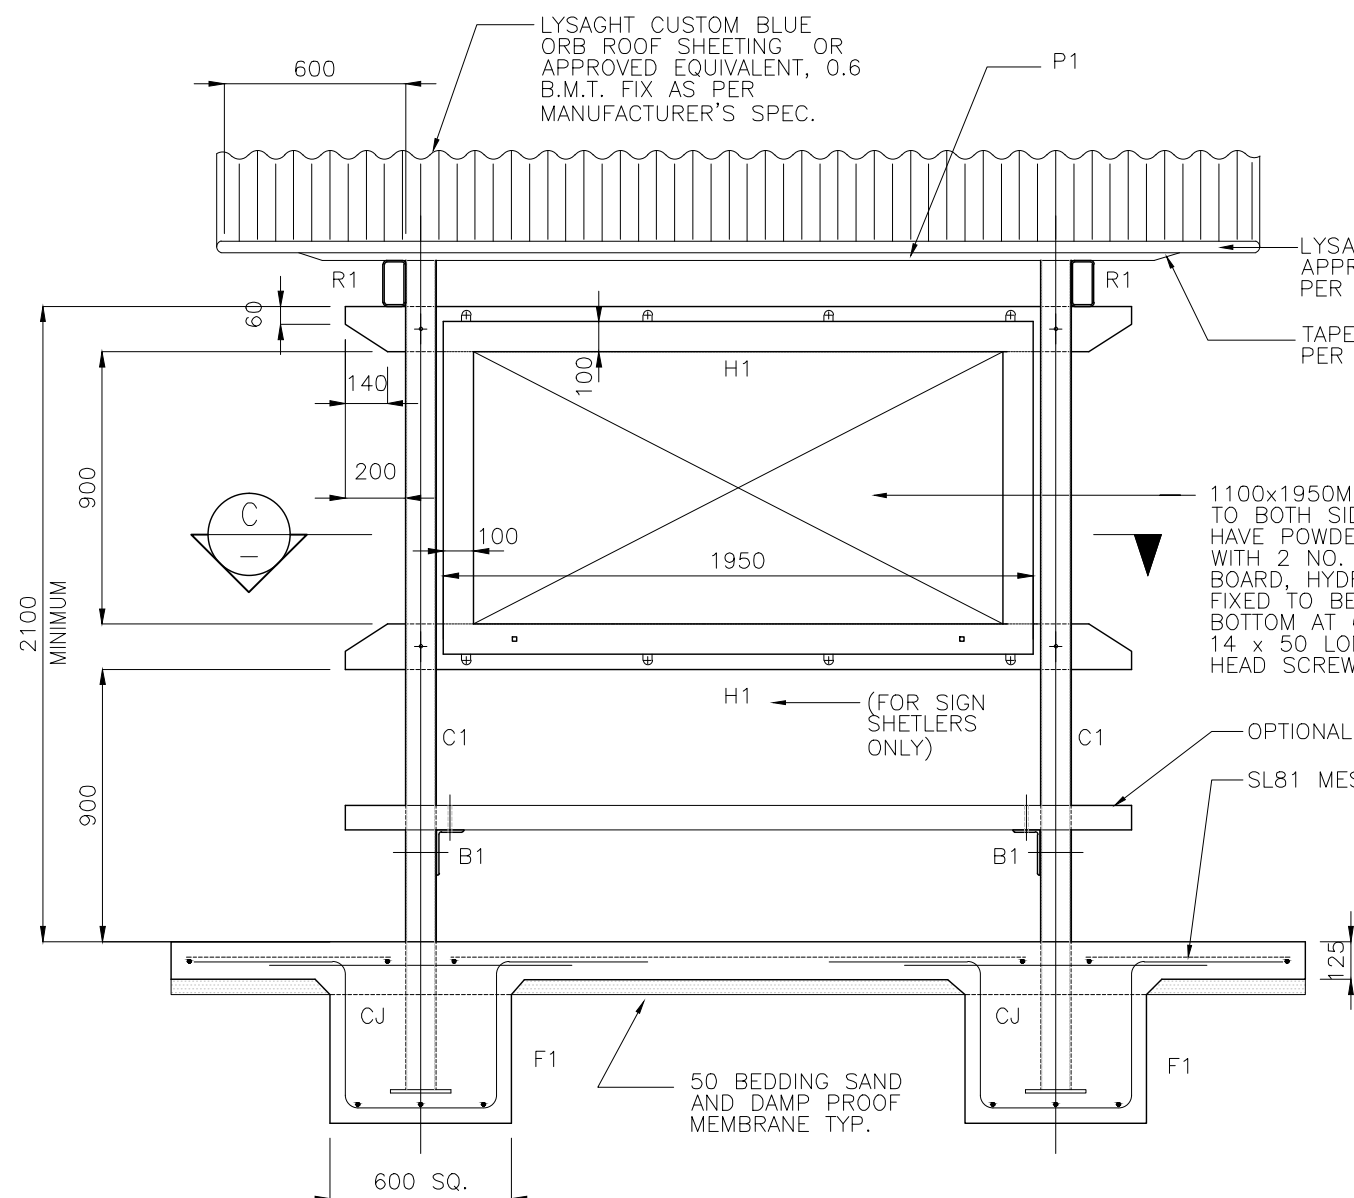
- REFER TO:
- BSD-10146-SIGN SHELTER-NATURAL AREA-SHEET 1 OF 3-GENERAL NOTES
 - BSD-10146-SIGN SHELTER-NATURAL AREA-SHEET 3 OF 3-ELEVATION AND SECTION

STRUCTURAL DESIGN CERTIFICATION


| DESIGN | DESIGN CHECK | AUTHORISED FOR ISSUE |
|--|---|--|
| D. Bateup RPEQ 13095 2014.11.26 16:17:40+10'00' | Zhuangzhi Hu RPEQ 13885 2014.11.26 16:30:37+10'00' | Bala Balakumar RPEQ 3963 2014.11.27 08:40:27+10'00' |

| BRISBANE CITY COUNCIL STANDARD DRAWING | |
|---|----------------------|
| SIGN SHELTER NATURAL AREA - PLAN SHEET 2 OF 3 | SCALE 1:25 |
| | DWG No. BSD-10146 |
| | ORIGINAL SIZE A3 |
| REVISION B | |

| | | | | | | | | | | |
|-------|-----------------------|---------------|---------------|----------------|--|---------------------|---|------|---------|--|
| | | | | | DRAWING AUTHORISED FOR PUBLICATION Inga Condric 2015.06.04 15:29:38+10'00" ----- for ASSET ENGINEERING MANAGER STRATEGIC ASSET MANAGEMENT | DESIGN | CP0 - P&D | DATE | NOV '14 |  BRISBANE CITY |
| | | | | | | DRAWN | CP0 - P&D | DATE | NOV '14 | |
| | | | | | | CHECKED | BI - FSG - AS | DATE | NOV '14 | |
| B | Drawing Title Amended | FEB '16 | JUL '16 | JUL '16 | DESIGN APPROVED C.Wood ----- SENIOR CO-ORDINATOR NATURAL ENVIRONMENT ASSET SERVICES/BRISBANE INFRASTRUCTURE | DRAWING FILENAME | BSD-10146 (B) Sign shelter - Natural area - Plan - Sheet 2 of 3.dwg | | | |
| A | ORIGINAL ISSUE | NOV '14 | NOV '14 | NOV '14 | | ASSOCIATED PLANS | BSD-10146-Sheets 1 & 3 | | | |
| ISSUE | AMENDMENT | DRAWN DATE | CHK'D DATE | APPR'D DATE | | | | | | |



ELEVATION — VIEW A
SCALE 1:25

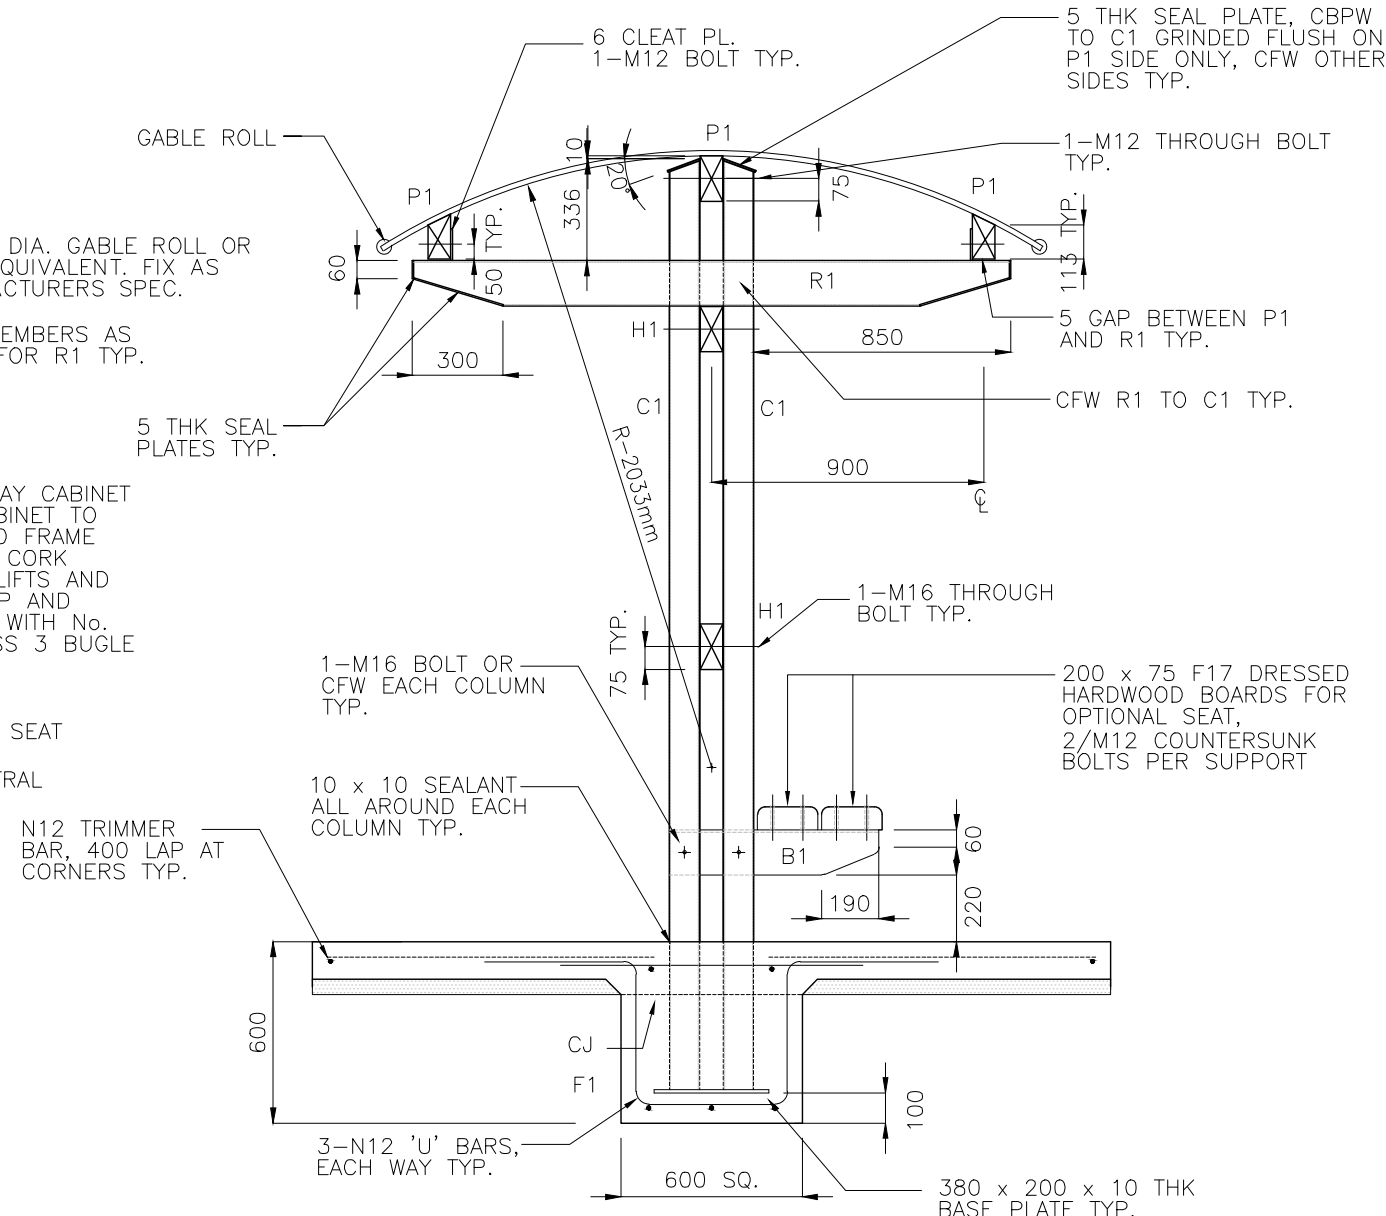

SECTION B
SCALE 1:25



OPTIONAL SEAT — SECTION C-C
SCALE 1:25

NOTES

- REFER TO:
- BSD-10146-SIGN SHELTER-NATURAL AREA-SHEET 1 OF 3-GENERAL NOTES
 - BSD-10146-SIGN SHELTER-NATURAL AREA-SHEET 2 OF 3-PLAN

STRUCTURAL DESIGN CERTIFICATION

| DESIGN | DESIGN CHECK | AUTHORISED FOR ISSUE |
|--|---|---|
| D. Bateup RPEQ 13095 2014.11.26 16:18:09+10'00' | Zhuangzhi Hu RPEQ 13885 2014.11.26 16:31:07+10'00' | Bala Balakumar RPEQ 13863 2014.11.27 08:41:00+10'00' |

| BRISBANE CITY COUNCIL STANDARD DRAWING | |
|--|----------------------|
| SIGN SHELTER — NATURAL AREA ELEVATION AND SECTION SHEET 3 OF 3 | |
| SCALE 1:25 | DWG No. BSD-10146 |
| ORIGINAL SIZE A3 | REVISION B |

| ISSUE | AMENDMENT | DRAWN DATE | CHK'D DATE | APPR'D DATE |
|-------|-----------------------|------------|------------|-------------|
| B | Drawing Title Amended | FEB '16 | JUL '16 | JUL '16 |
| A | ORIGINAL ISSUE | NOV '14 | NOV '14 | NOV '14 |

| DRAWING AUTHORISED FOR PUBLICATION |
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| Inga Condric 2015.06.04 15:30:19+10'00' |
| DESIGN APPROVED |
| C. Wood SENIOR CO-ORDINATOR NATURAL ENVIRONMENT ASSET SERVICES/BRISBANE INFRASTRUCTURE |

| DESIGN | CP0 - P&D | DATE | NOV '14 |
|------------------|--|------|---------|
| DRAWN | CP0 - P&D | DATE | NOV '14 |
| CHECKED | BI - FSG - AS | DATE | NOV '14 |
| DRAWING FILENAME | BSD-10146 (B) Sign shelter - Natural area - Section and elevation - Sheet 3 of 3.dwg | | |
| ASSOCIATED PLANS | BSD-10146-Sheets 1 & 2 | | |



GENERAL NOTES:

- G1 THE BUILDER SHALL BE RESPONSIBLE FOR MAINTAINING STABILITY OF THE STRUCTURE UNTIL COMPLETION OF CONSTRUCTION AND SHALL ENSURE THAT NO PART OF THE STRUCTURE IS OVERSTRESSED.
- G2 THE BUILDER SHALL CHECK ALL DIMENSIONS AND ALL EXISTING CONDITIONS BEFORE COMMENCING CONSTRUCTION.
- G3 ANY DAMAGE CAUSED BY THE CONTRACTOR SHALL BE MADE GOOD AT THEIR OWN COST.
- G4 ALL MATERIALS AND WORKMANSHIP SHALL BE IN ACCORDANCE WITH THE CURRENT EDITIONS OF THE FOLLOWING AUSTRALIAN STANDARDS, EXCEPT WHERE VARIED BY THE SPECIFICATIONS AND/OR DRAWINGS: – AS 1684.2 (2010) RESIDENTIAL TIMBER FRAMED CONSTRUCTION AS 1720.1 (2010) TIMBER STRUCTURES AS 2870 (2011) RESIDENTIAL SLABS AND FOOTINGS AS 3600 (2009) CONCRETE STRUCTURES AS 3798 (2007) GUIDELINES ON EARTHWORKS FOR COMMERCIAL AND RESIDENTIAL DEVELOPMENTS AS 4100 (1998) STEEL STRUCTURES
- G5 DIMENSIONS SHALL NOT BE OBTAINED BY SCALING THE STRUCTURAL DRAWINGS.
- G6 ALL DIMENSIONS ARE IN MILLIMETRES UNLESS NOTED OTHERWISE
- G7 U.N.O. DENOTES UNLESS NOTED OTHERWISE.
- G8 THE CONTRACTOR SHALL VISIT THE SITE PRIOR TO TENDERING TO FAMILIARISE THEMSELVES WITH ACCESS SITE CONDITIONS
- G9 THE CONTRACTOR MAY OFFER FOR CONSIDERATION ALTERNATIVE PROVEN EQUAL PRODUCTS TO THOSE INDICATED. ALTERNATIVE PRODUCTS ARE NOT TO ADVERSELY AFFECT THE PROJECT AND CANNOT BE SUBSTITUTED WITHOUT PRIOR APPROVAL.
- G10EXISTING SERVICES TO BE LOCATED BEFORE CONSTRUCTION COMMENCES.
- G11THIS DRAWING IS TO BE READ IN CONJUNCTION WITH SHEET 2 TO 5.
- G12CONSULT BCC ARCHITECT FOR COLOUR SCHEME OF THE STRUCTURE.

DESIGN CRITERIA:

WIND LOADS : REGION B TERRAIN CATEGORY 1.5
ULTIMATE WIND SPEED = 54.0 m/s
DESIGN LIFE : 50 YEARS WITH ROUTINE MAINTENANCE.
LIVE LOADS: : FLOOR = 5.0 kPa. ROOF= 0.25 kPa / 1.4 kN.
NO SCREENS(IMPERMEABLE OR PERMEABLE BARRIERS) TO BE INSTALLED UNLESS SHOWN ON THE DRAWINGS.

TERRAIN CATEGORY 1.5 CORRESPONDS TO AN ENVIRONMENT WITH OPEN WATER SURFACES, SUBJECTED TO SHOALING WAVES AT SERVICEABILITY AND ULTIMATE WIND SPEEDS IN ALL WIND REGIONS.

FOUNDATIONS AND SLAB ON GROUND:

- F1 ALL FOOTINGS ARE TO BE FOUNDED IN THE NATURAL UNDISTURBED SOIL PROFILE WITH A MINIMUM ALLOWABLE SOIL BEARING CAPACITY OF 100kPa UNLESS NOTED OTHERWISE. IF SITE CONDITION IS DIFFERENT, CONSULT A STRUCTURAL ENGINEER
- F2 SOIL TEST IS REQUIRED TO CONFIRM BEARING CAPACITY AND SITE CLASSIFICATION TO AS 2870.
- F3 FOUNDATIONS ARE TO BE CHECKED AND CERTIFIED BY A REGISTERED PROFESSIONAL GEOTECHNICAL ENGINEER, QUEENSLAND (RPEQ).
- F4 COMPACT AND PREPARE THE BASE TO PROVIDE A SOUND PLATFORM AND ANY ORGANIC, SOFT OR LOOSE MATERIALS REMOVED AND REPLACED WITH COMPACTED FILL – BCC SPECIFICATION S300 QUARRY PRODUCTS CLASS I MATERIAL.
- F5 THE BOTTOMS OF ALL FOOTINGS ARE TO BE CLEANED OF ALL LOOSE MATERIAL AND WATER PRIOR TO POURING CONCRETE.
- F6 SLABS ON GRADE SHALL BE UNDERLAIN WITH CONTINUOUS LAYER OF 200 MICRON (0.2mm) THICK POLYETHYLENE DAMPPROOF MEMBRANE AS PER AS 2870, LAPPED AND TAPED TO MANUFACTURER’S SPECIFICATION.

EARTHWORKS:

- E1 STRIP ALL HUMUS MATERIAL FROM THE AREA OF THE BUILDING IMPRINT AND 1000 BEYOND.
- E2 PROOF ROLL THE AREAS TO BE CONCRETED AND PAVED. REMOVE ANY WEAK MATERIAL.
- E3 USE NON–HUMUS CUT MATERIAL OR IMPORTED APPROVED NON–REACTIVE SOIL AS FILL.
- E4 COMPACTED FILL SHALL BE COMPACTED IN LAYERS NOT EXCEEDING 150mm LOOSE DEPTH TO 98% MAXIMUM DRY DENSITY IN ACCORDANCE WITH AS 1289. 5.1.1 (STANDARD COMPACTION). CARRY OUT DENSITY TESTS AT A RATE OF 2 PER LEVEL OF FILL. EVERY TEST MUST PASS.

CONCRETE NOTES:

- C1 ALL WORKMANSHIP AND MATERIAL SHALL BE IN ACCORDANCE WITH AS 3600.
- C2 ALL CONCRETE SHALL BE PREMIXED BY AN APPROVED SUPPLIER.
- C3 ALL CEMENT SHALL BE TYPE GP OR GB.
- C4 CONCRETE SPECIFICATION: NOMINAL AGGREGATE SIZE TO BE 20mm, SLUMP TO BE NOT GREATER THAN 80mm.
- C5 CONCRETE STRENGTH AND CLEAR CONCRETE COVER TO REINFORCEMENT SHALL BE IN ACCORDANCE WITH THE FOLLOWING TABLE U.N.O.ELEMENT:
- | | |
|-----------|----------------------|
| F'C (MPa) | REINFORCEMENT COVER |
| PIERS | 32 75 |
| SLAB | 32 CENTRALLY PLACED. |
- C6 ALL LAPS IN REINFORCEMENT SHALL BE AS SHOWN IN THE TABLE BELOW UNLESS NOTED OTHERWISE.
- | |
|---------------------|
| BAR LAP LENGTH (mm) |
| N12 500 |
| N16 650 |
| MESH 350 |
- C7 REINFORCEMENT SYMBOLS: R STRUCTURAL PLAIN ROUND GRADE 250R TO AS 4671.
N DEFORMED BAR GRADE D500N TO AS 4671.
SL HARD DRAWN STEEL REINFORCING FABRIC GRADE D500L TO AS 4671.
- C8 SIZES OF CONCRETE ELEMENTS DO NOT INCLUDE THICKNESS OF APPLIED FINISHES.
- C9 NO HOLES, CHASES OR EMBEDMENT OF PIPES OTHER THAN THOSE SHOWN ON THE STRUCTURAL DRAWINGS SHALL BE MADE IN CONCRETE MEMBERS WITHOUT PRIOR APPROVAL BY THE SUPERINTENDENT.
- C10 ALL CONCRETE SHALL BE COMPACTED USING A MECHANICAL VIBRATION PROCESS.
- C11ALL REINFORCEMENT SHALL BE SECURELY SUPPORTED IN ITS CORRECT POSITION DURING CONCRETING BY APPROVED BAR CHAIRS, SPACERS OR SUPPORT BARS.
- C12 CONSTRUCTION JOINTS SHALL BE PROPERLY FORMED AND USED ONLY WHERE SHOWN OR SPECIFICALLY APPROVED BY THE SUPERINTENDENT.

TIMBER NOTES:


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- T2 TIMBER GRADES SHALL BE AS SHOWN ON THE DRAWINGS. ALL TIMBER TO BE SEASONED OR KILN DRIED GRADE MGP12 MINIMUM U.N.O WITH NATURAL DURABILITY CLASS 4 (ABOVE GROUND) OR BETTER.
- T3 ALL FASTENERS SHALL BE HOT DIP GALVANISED. BOLTS TO BE METRIC HEX–HEAD M16 MINIMUM WITH WASHERS U.N.O. CLEAT PLATES TO BE 10mm THICK U.N.O.
- T4 TIMBER JOINT GROUP JD4 OR BETTER.
- T5 ALL TIMBER SHALL BE FULLY DRESSED AND ALL EDGES, ENDS AND CORNERS TO BE 6mm DRESSED.
- T6 PROTECT ENDS OF EXPOSED MEMBERS. USE A HIGH QUALITY EXTERIOR PAINT FINISH.
- T7 ALL TIMBER FRAMING SHALL BE NATURALLY TERMITE RESISTANT OR TREATED USING LOSP OR ACQ CHEMICALS TO A HAZARD RESISTANCE LEVEL H3 IN ACCORDANCE WITH AS 1684.2 APPENDIX B.
- T8 ALL TIMBER TO BE STAINED OR PAINTED PRIOR TO FIXING INTO FINAL POSITION. REFER TO PROJECT SPECIFICATION FOR EACH PROJECT.


STEELWORK NOTES

- S1. ALL WORKMANSHIP & MATERIALS SHALL BE IN ACCORDANCE WITH AS4100 & AS/NZS1554.
- S2. ALL STEEL SHALL BE IN ACCORDANCE WITH: AS1163 GRADE C350LO FOR RECTANGULAR AND SQUARE HOLLOW SECTIONS UNO
- S3. ALL BOLTS TO BE METRIC HEXAGONAL TO AS 1252 U.N.O. ALL BOLTS TO BE M16 4.6/S TO AS/NZS 1252 U.N.O. ALL BOLTS TO BE HOT DIP GALVANISED TO AS 1214 U.N.O.
- S4. ALL CLEATS AND GUSSETS SHALL BE 10mm PLATE TO AS/NZS3678 GRADE 250 U.N.O.
- S5. METAL ROOF CLADDING TO BE 0.42 BMT LYSAGHT CUSTOM ORB WITH A COLORBOND FINISH OR APPROVED EQUAL FIXED AS PER MANUFACTURER’S SPECIFICATIONS – COLORBOND COLOUR AS PER SPECIFICATION.
- S6. ALL WELDS TO BE 6mm CONTINUOUS FILLET WELDS (CFW) STRUCTURAL PURPOSE (SP) WELDS U.N.O. ALL WELDS TO BE MADE USING E48XX OR W50X GRADE 1 (OR BETTER) ELECTRODES TO AS/NZS 1554. GRIND ALL CORNERS & WELDS SMOOTH.
- S7. ALL STEELWORK TO BE HOT DIP GALVANISED IN ACCORDANCE WITH AS/NZS 2312 HDG600 SPECIFICATION. SURFACE PREPARATION FOR CORROSION PROTECTION COATING IS TO BE CLASS 2½ TO AS 1627 AND PICKLED PRIOR GALVANISING. HOT DIPPED GALVANISED COATING SHALL BE IN ACCORDANCE WITH AS/NZS 4680.
- S8. ANY POST GALVANISING DAMAGE TO BE MADE GOOD WITH HIGH QUALITY TWO PACK EPOXY ZINC RICH PAINT CONFORMING TO AS/NZS 3750.9 WITH A MINIMUM DRY FILM THICKNESS OF 100 MICRONS. SURFACE PREPARATION TO BE ACCORDING TO PAINT MANUFACTURER’S RECOMMENDATIONS.
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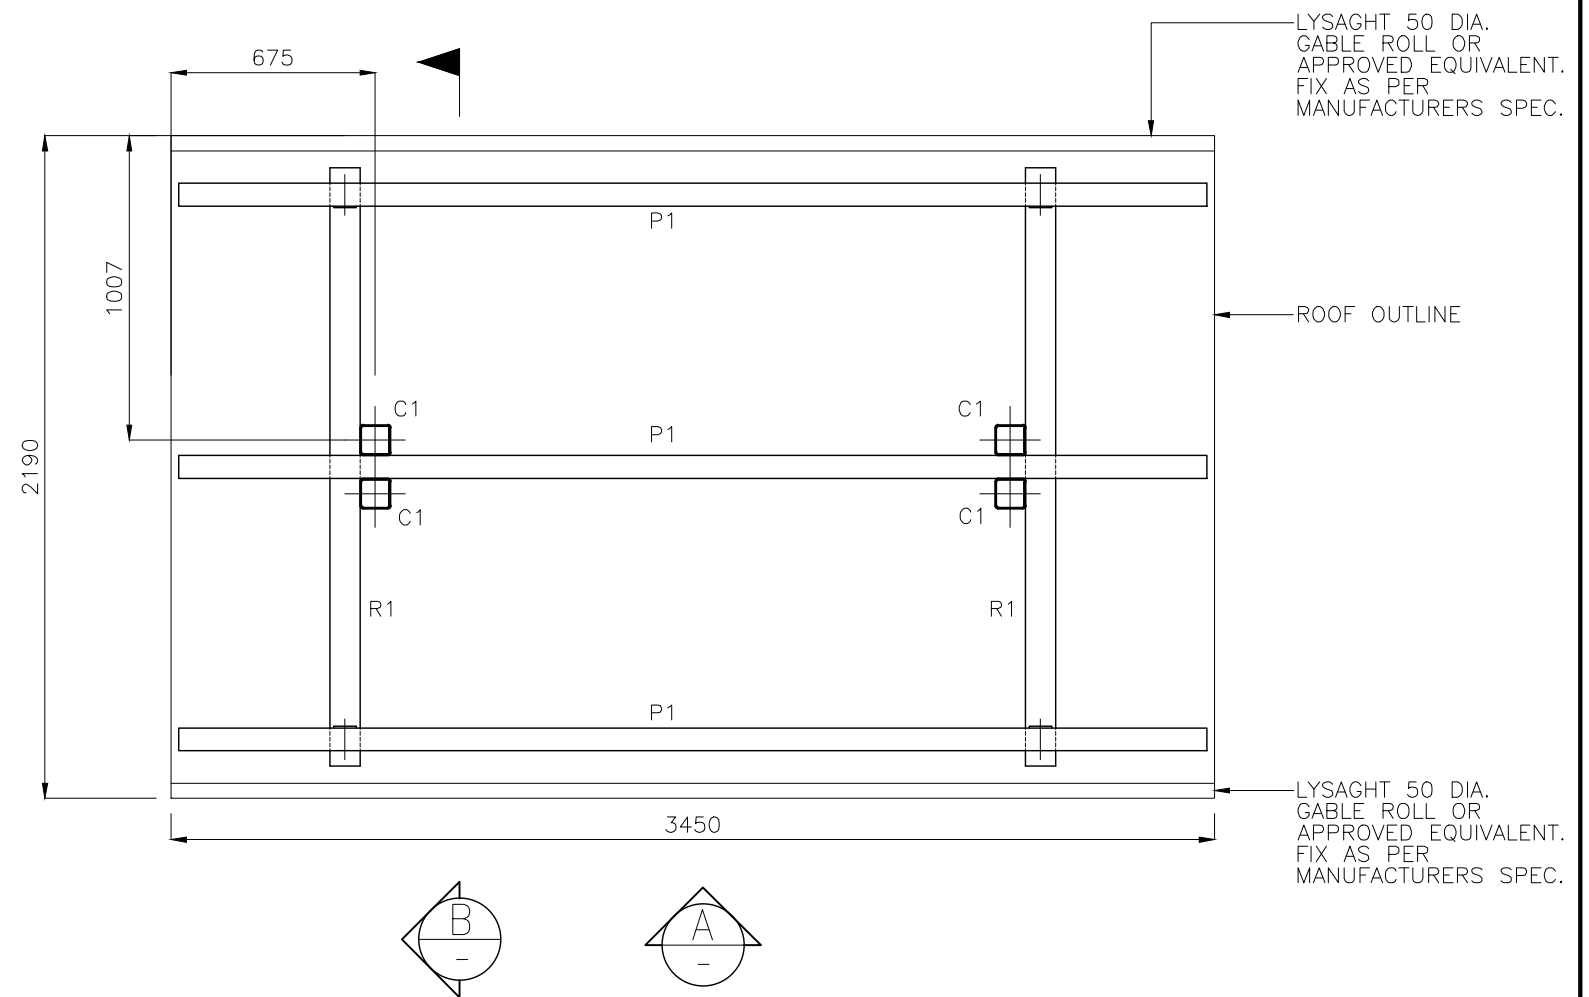
INSPECTION AND CERTIFICATION NOTES:

- A1 THE CONTRACTOR’S ENGINEER (RPEQ) SHALL UNDERTAKE INSPECTIONS DURING CONSTRUCTION TO ENSURE ALL CONSTRUCTION WORKS ARE IN ACCORDANCE WITH THE MOST CURRENT ISSUE OF THE STRUCTURAL DRAWINGS AND THE CONTRACT DOCUMENT. THE RPEQ SHALL CERTIFY ALL CONSTRUCTION WORK (FORM 16). ANY ALTERNATIVE TECHNIQUE USED IN CONSTRUCTION SHALL BE FOLLOWED BY A DESIGN CERTIFICATE (FORM 15) BY THE CONTRACTOR’S PROFESSIONAL ENGINEER (RPEQ).

| | | | | | | | | | | | | | | | |
|-------|-----------------------|---------------|---------------|----------------|---|--|---------------------|--|------|---------|---|--|---|----------------------|--|
| | | | | | DRAWING AUTHORISED FOR PUBLICATION | | DESIGN | CP0 – P&D | DATE | NOV '14 |  | BRISBANE CITY COUNCIL STANDARD DRAWING | | | |
| | | | | | Inga Condric 2015.06.04 15:30:55+10'00' | | DRAWN | CP0 – P&D | DATE | NOV '14 | | BARBEQUE SHELTER NATURAL AREA – GENERAL NOTES SHEET 1 OF 3 | | SCALE N.T.S | |
| | | | | | for ASSET ENGINEERING MANAGER STRATEGIC ASSET MANAGEMENT | | CHECKED | BI – FSG – AS | DATE | NOV '14 | | | | DWG No. BSD–10147 | |
| B | Drawing Title Amended | FEB '16 | JUL '16 | JUL '16 | DESIGN APPROVED | | DRAWING FILENAME | BSD-10147 (B) Barbeque shelter - Natural area - General notes - Sheet 1 of 3.dwg | | | | ORIGINAL SIZE | | REVISION | |
| A | ORIGINAL ISSUE | NOV '14 | NOV '14 | NOV '14 | C.Wood | | ASSOCIATED PLANS | BSD-10147-Sheets 2 & 3 | | | | A3 | B | | |
| ISSUE | AMENDMENT | DRAWN DATE | CHK'D DATE | APPR'D DATE | SENIOR CO-ORDINATOR NATURAL ENVIRONMENT ASSET SERVICES/BRISBANE INFRASTRUCTURE | | | | | | | | | | |

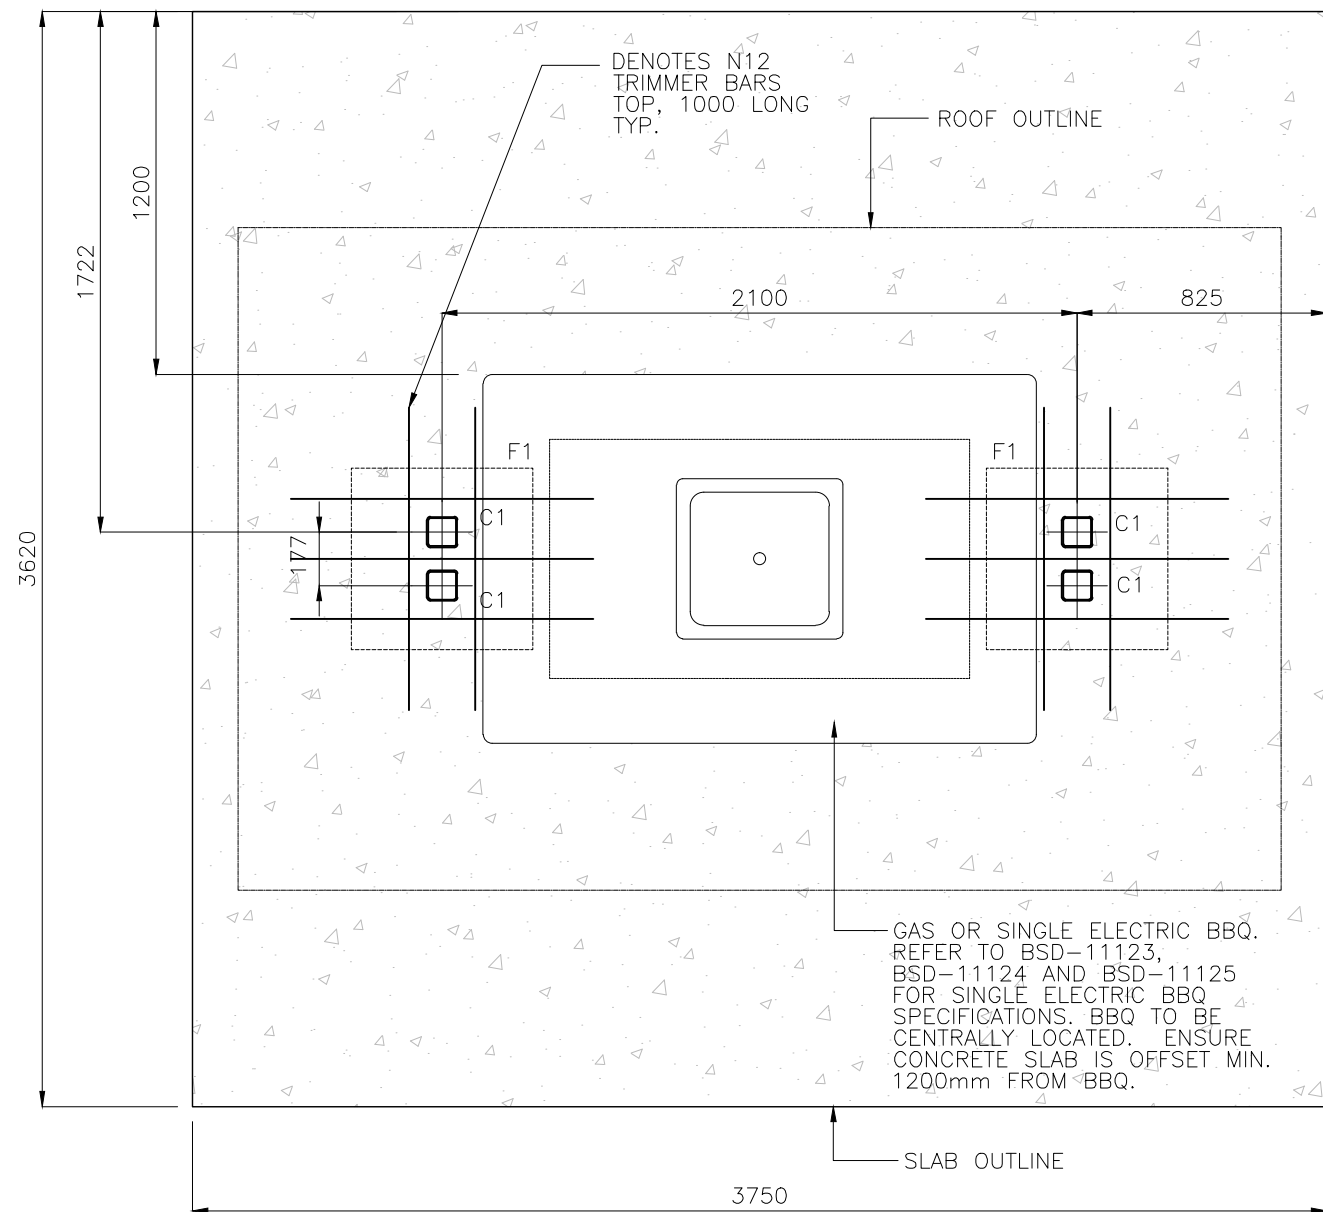

SLAB AND FOOTING
PLAN
SCALE 1:50




ROOF FRAMING PLAN
SCALE 1:50


| MEMBER SCHEDULE | |
|-----------------|-------------------------|
| MARK | MEMBER |
| C1 | 100 x 4 SHS COLUMN |
| H1 | 150 x 75 F17 HWD HEADER |
| P1 | 150 x 75 F17 HWD PURLIN |
| R1 | 152 x 76 x 5 RHS RAFTER |

NOTES


- REFER TO:
- BSD-10147-BARBEQUE SHELTER-NATURAL AREA-SHEET 1 OF 3-GENERAL NOTES
 - BSD-10147-BARBEQUE SHELTER-NATURAL AREA-SHEET 3 OF 3-ELEVATION AND SECTION

| STRUCTURAL DESIGN CERTIFICATION | | |
|---|---|---|
| DESIGN | DESIGN CHECK | AUTHORISED FOR ISSUE |
| D. Bateup RPEQ 13095 2014.11.26 16:20:44+10'00' | Zhuangzhi Hu RPEQ 13885 2014.11.26 16:31:51+10'00' | Bala Balakumar RPEQ 3963 2014.11.27 08:42:01+10'00' |
| BRISBANE CITY COUNCIL STANDARD DRAWING | | |
| BARBEQUE SHELTER – NATURAL AREA – PLAN SHEET 2 OF 3 | | SCALE AS SHOWN DWG No. BSD-10147 ORIGINAL SIZE A3 REVISION B |

| | | | | | | | | | | |
|-------|-----------------------|---------------|---------------|----------------|--|---------------------|---|------|---------|---|
| | | | | | DRAWING AUTHORISED FOR PUBLICATION Inga Condric 2015.06.04 15:31:41+10'00" ----- for ASSET ENGINEERING MANAGER STRATEGIC ASSET MANAGEMENT | DESIGN | CP0 - P&D | DATE | NOV '14 |  |
| | | | | | | DRAWN | CP0 - P&D | DATE | NOV '14 | |
| | | | | | | CHECKED | BI - FSG - AS | DATE | NOV '14 | |
| B | Drawing Title Amended | FEB '16 | JUL '16 | JUL '16 | DESIGN APPROVED C.Wood | DRAWING FILENAME | BSD-10147 (B) Barbeque shelter - Natural area - Plan - Sheet 2 of 3.dwg | | | |
| A | ORIGINAL ISSUE | NOV '14 | NOV '14 | NOV '14 | | ASSOCIATED PLANS | BSD-10147-Sheets 1 & 3 | | | |
| ISSUE | AMENDMENT | DRAWN DATE | CHK'D DATE | APPR'D DATE | SENIOR CO-ORDINATOR NATURAL ENVIRONMENT ASSET SERVICES/BRISBANE INFRASTRUCTURE | | | | | |

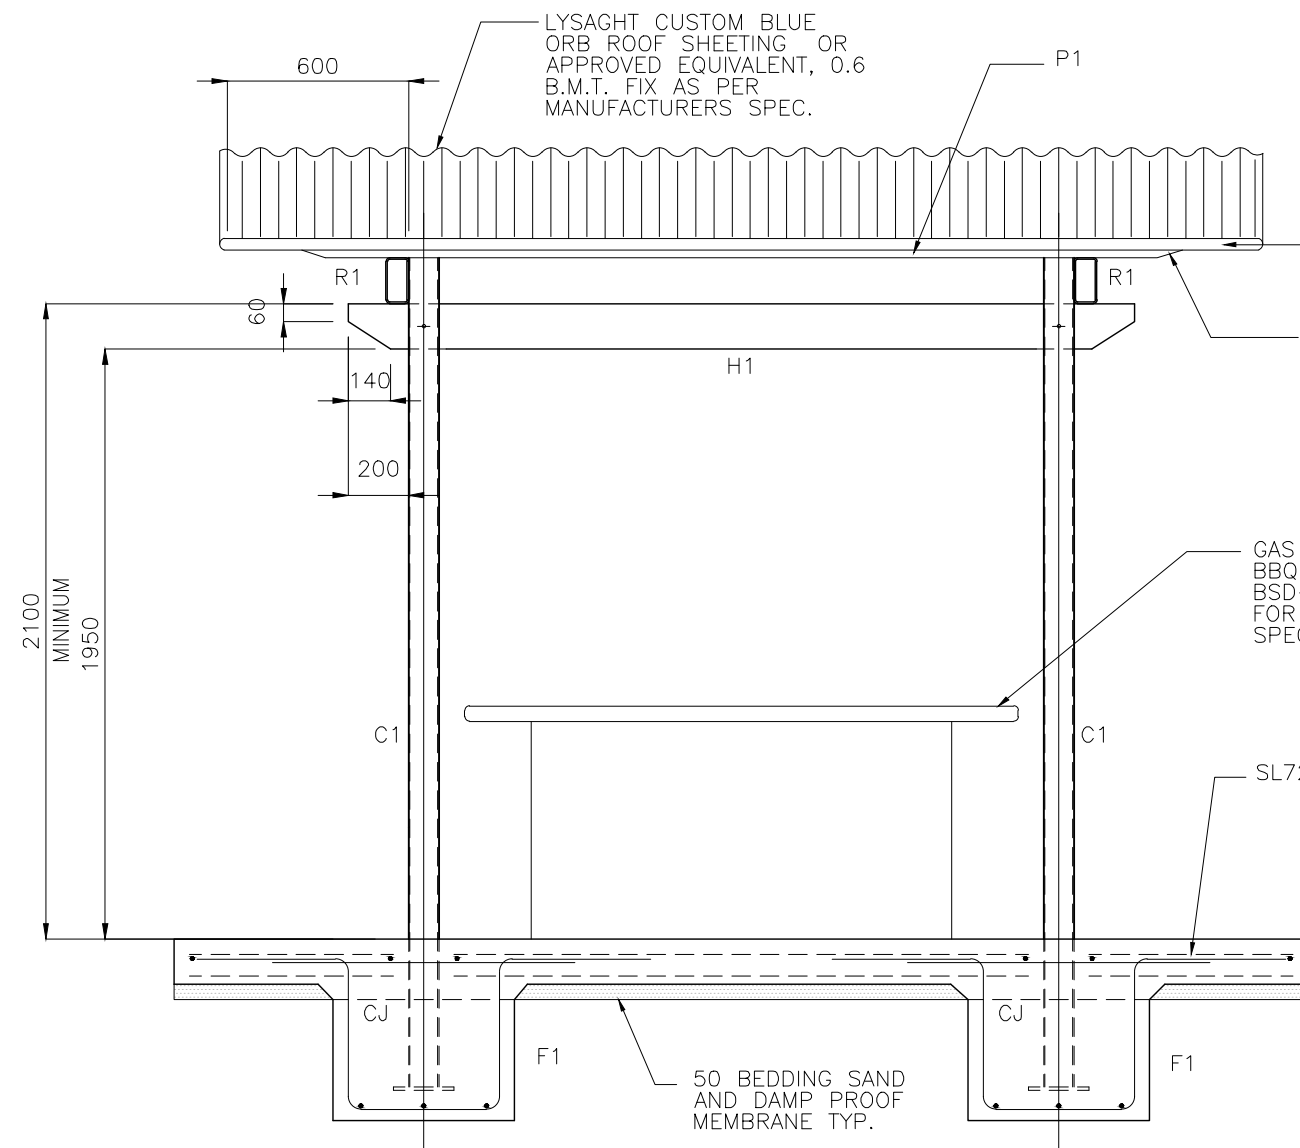

ELEVATION A
SCALE 1:25

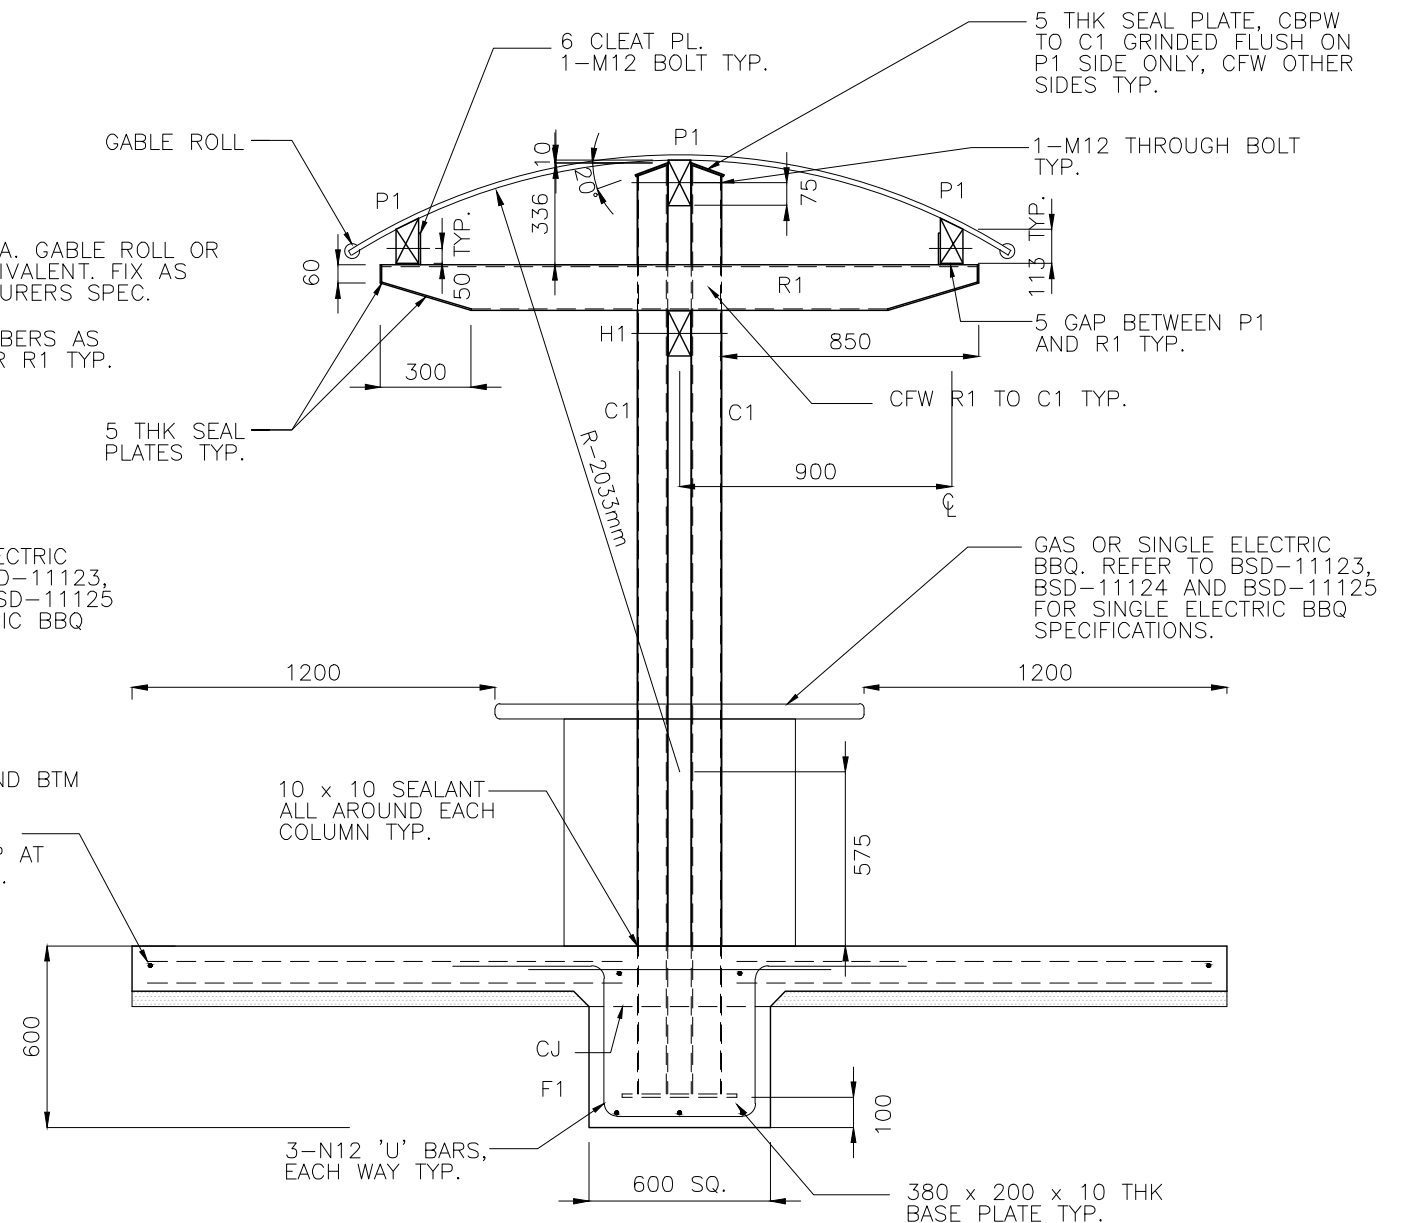

SECTION B
SCALE 1:25

NOTES

- REFER TO:
- BSD-10147-BARBEQUE SHELTER-NATURAL AREA-SHEET 1 OF 3-GENERAL NOTES
 - BSD-10147-BARBEQUE SHELTER-NATURAL AREA-SHEET 2 OF 3-PLAN

STRUCTURAL DESIGN CERTIFICATION

| DESIGN | DESIGN CHECK | AUTHORISED FOR ISSUE |
|--|---|--|
| D. Bateup RPEQ 13095 2014.11.26 16:21:18+10'00' | Zhuangzhi Hu RPEQ 13885 2014.11.26 16:32:16+10'00' | Bala Balakumar RPEQ 3963 2014.11.27 08:42:33+10'00' |

| BRISBANE CITY COUNCIL STANDARD DRAWING | |
|---|---------------|
| BARBEQUE SHELTER – NATURAL AREA – ELEVATION AND SECTION SHEET 3 OF 3 | |
| SCALE AS SHOWN DWG No. BSD-10147 ORIGINAL SIZE A3 | REVISION B |

| ISSUE | AMENDMENT | DRAWN DATE | CHK'D DATE | APPR'D DATE |
|-------|-----------------------|------------|------------|-------------|
| B | Drawing Title Amended | FEB '16 | JUL '16 | JUL '16 |
| A | ORIGINAL ISSUE | NOV '14 | NOV '14 | NOV '14 |

| DRAWING AUTHORISED FOR PUBLICATION | |
|---|--|
| Inga Condric 2015.06.04 15:32:25+10'00' for ASSET ENGINEERING MANAGER STRATEGIC ASSET MANAGEMENT DESIGN APPROVED C.Wood SENIOR CO-ORDINATOR NATURAL ENVIRONMENT ASSET SERVICES/BRISBANE INFRASTRUCTURE | |

| DESIGN | CP0 - P&D | DATE | NOV '14 |
|------------------|--|------|---------|
| DRAWN | CP0 - P&D | DATE | NOV '14 |
| CHECKED | BI - FSG - AS | DATE | NOV '14 |
| DRAWING FILENAME | BSD-10147 (B) Barbeque shelter - Natural area - Elevation and section - Sheet 3 of 3.dwg | | |
| ASSOCIATED PLANS | BSD-10147-Sheets 1 & 2 | | |



GENERAL NOTES & SPECIFICATION

- G1.

ENSURE BASKETBALL COURTS ARE LOCATED AND LANDSCAPED IN ACCORDANCE WITH DETAILED LANDSCAPE PLAN, AND PARKS CHAPTER OF INFRASTRUCTURE DESIGN PLANNING SCHEME POLICY.
- G2.

AUSTRALIAN STANDARDS SHALL BE IN ACCORDANCE WITH THE CURRENT EDITIONS OF THE REFERENCED AUSTRALIAN STANDARDS EXCEPT WHERE VARIED BY SPECIFICATIONS AND/OR DRAWINGS.
- G3.

MATERIAL CHOICES ARE TO BE DETERMINED ON THE GROUNDS OF SUSTAINABILITY, LOW MAINTENANCE, VANDAL RESISTANCE, ENVIRONMENTALLY FRIENDLY COMPOSITE MATERIALS, PRODUCT AVAILABILITY AND SUITABILITY TO THE CLIMATIC CONDITIONS AND PRACTICALITY, WHERE POSSIBLE, MATERIALS ARE TO BE LOCALLY MADE OR SOURCED RATHER THAN IMPORTED FROM OVERSEAS UNLESS SPECIFIED OTHERWISE.
- G4.

COURT TO BE SET OUT TO ENSURE WATER DOES NOT POND ON SURFACE.
- G5.

THIS IS A SCALED VERSION OF A FULL COURT. FULL COURT DIMENSIONS (PLAYING SURFACE ONLY) ARE 28 mx15 m.
- G6.

A MINIMUM 2m SAFETY CLEARANCE, FREE FROM OBSTACLES INCLUDING TREES, POLES, ETC. REQUIRED ALONG BOTH SIDES OF THE COURT.
- G7.

COURT LINE MARKING TO BE 50 mm WIDTH, WHITE COMPLETED IN SUITABLE SLIP RESISTANT MATERIAL. MATERIAL FOR LINE MARKING SHALL BE APPLIED AT A MAXIMUM THICKNESS OF 500 μ m.
- G8.

ENSURE MOWN HEIGHT OF GRASS (TURF) AREAS FINISH FLUSH WITH PLAYING SURFACE.
- G9.

ENSURE PARK ELEMENTS ARE CLEANED OF CONCRETE SLURRY OR SPRAY WHEN INSTALLED TO PREVENT STAINING OR DAMAGE TO APPLIED FINISHES.
- G10.

REFER BSD-10212 FOR TOPSOIL AND TURFING NOTES.
- G11.

ALL DIMENSIONS IN MILLIMETRES (U.N.O.).

SITE NOTES

- S1.

DURING CONSTRUCTION THE CONTRACTOR SHALL ENSURE THAT ALL STRUCTURES AND FOOTINGS ARE MAINTAINED IN A SAFE AND STABLE CONDITION. WORKPLACE HEALTH AND SAFETY REGULATION MUST BE ADHERED TO ON ALL SITES, AT ALL TIMES.
- S2.

SITE TO BE LEFT TIDY & ALL EXCESS FILL/MATERIAL IS TO BE REMOVED BY THE CONTRACTOR OR AS DIRECTED BY SUPERINTENDENT.
- S3.

CONTRACTOR MUST NOTIFY COUNCIL OFFICER IN CHARGE 48 HOURS PRIOR TO COMMENCEMENT OF WORK ON SITE, TO INSPECT THE CONCRETE POUR AND FINAL INSPECTION.
- S4.

WHERE APPLICABLE - INCORPORATE SITE FURNITURE TO PERIMETER OF COURT. MAINTAIN A MINIMUM OF 2m TURF CLEAR ZONE TO PERIMETER OF COURT. NO TREES OR FURNITURE TO BE INSTALLED IN THIS CLEAR ZONE. ENSURE PARK ELEMENTS ARE LOCATED IN ACCORDANCE WITH LANDSCAPE PLAN & SUBDIVISION AND DEVELOPMENT GUIDELINES.

CONCRETE WORKS

- C1.

ALL WORKMANSHIP & MATERIALS SHALL COMPLY WITH THE CURRENT AUSTRALIAN STANDARDS IN PARTICULAR AS 3600, AND ANY REQUIREMENTS OF THE LANDSCAPE ARCHITECT.
- C2.

SLAB TO BE 125mm THICK N25 GRADE CONCRETE. CONCRETE SHALL BE NORMAL CLASS CONCRETE UNLESS DIRECTED OTHERWISE. N25 SHALL MEAN NORMAL CLASS CONCRETE WITH A 28 DAY CHARACTERISTIC STRENGTH OF 25MPA. CONCRETE MIX DESIGN SHALL BE SUBMITTED TO THE SITE SUPERINTENDENT FOR APPROVAL FIVE (5) DAYS PRIOR TO ORDERING.
- C3.

ALL CEMENT TO BE TYPE GP OR GB TO AS 3972 UNLESS SPECIFIED OTHERWISE.
- C4.

SUPPLY AND LAY SL82 MESH SUPPORTED BY 60mm BAR CHAIRS. MESH TO OVERLAP 200mm.
- C5.

HARD DRAWN STEEL REINFORCING FABRIC GRADE D500L TO AS 4671.
- C6.

ENSURE EVEN GRADE FALLS MIN. 1:50 TO PAVEMENT FINISHED SURFACE.
- C7.

POLE FOOTING MINIMUM 400 x 400 x 800 mm BELOW SLAB. REFER MANUFACTURERS SPECIFICATION.
- C8.

OPTIONAL COURT PAVEMENT FINISH (WHERE SPECIFIED) TO BE SYNTHETIC PAVEMENT SURFACE APPLIED AS PER MANUFACTURERS SPECIFICATION. COLOUR SELECTION IN ACCORDANCE WITH STANDARD BCC PAINT COLOURS.
- C9.

PROVIDE SAWN JOINTS (SJ) AT 5.5M CENTRES (MAX.) IN EACH DIRECTION AS PER BSD-5206.

EQUIPMENT & FIXTURES NOTES

- E1.

SUPPLY AND INSTALL HOOP, BACKBOARD AND POST IN ACCORDANCE WITH QLD. BASKETBALL INCORPORATED REQUIREMENTS AND ISSUE STRUCTURAL ENGINEER'S CERTIFICATION UPON COMPLETION.
- E2.

ALL PROPRIETARY FIXINGS SHALL BE INSTALLED TO MANUFACTURERS SPECIFICATIONS.
- E3.

FOR BASKETBALL HOOP, POST AND POST SLEEVE. SUPPLIER TO BE APPROVED BY COUNCIL REPRESENTATIVE PRIOR TO INSTALLATION. REFER UMS 711 FOR CONTACT DETAILS.
- E4.

SLEEVE TO BE INSTALLED TO SUIT POST SIZE FOR EASY REMOVAL AND INSPECTION.
- E5.

THE BASKETBALL HOOP WILL BE FREE OF NET HOOKS TO REDUCE THE POSSIBILITY OF ENTRAPMENT OF FINGERS OR JEWELLERY. ATTACHMENTS FOR OTHER SPORTS ARE NOT TO BE ADDED TO THE REAR OF THE BASKETBALL POSTS.
- E6.


THE BACKING BOARD IS TO BE FIBREGLASS AND IS TO HAVE ROUNDED CORNERS AND BE FREE OF SHARP EDGES.
- E7.


BOLT ENDS OF THE BACKBOARD MOUNTING PLATE ARE TO BE CUT OFF FLUSH TO REDUCE THE POSSIBILITY OF LACERATION INJURIES. TAMPER PROOF BOLTS AND NUTS ARE TO BE USED FOR ATTACHING ALL FIXTURES AND FITTINGS.
- E8.


SECURE THE POST TO THE SLEEVE USING STAINLESS STEEL TAMPER PROOF BOLTS AND NUTS, ENSURING THE POST IS AT THE CORRECT ALIGNMENT TO THE COURT. CUT OFF EXCESS BOLT THREADS.
- E9.


POWDER COAT POST, STAYS AND HOOP, OR OTHER FINISH AS SPECIFIED. UNLESS OTHERWISE SPECIFIED, HOOP, POSTS AND STAYS TO BE POWDER COATED. REFER BSD-10003 FOR SPECIFIC COLOUR.

REFER TO BSD-10211 - SHEET 2
OF 2 FOR BASKET BALL COURT
DETAILS

| | | | | | | | | | | | | | |
|-------|-----------------------|---------------|---------------|----------------|---|---------------------|---|------|---------|---|---|--|---|
| | | | | | DRAWING AUTHORISED FOR PUBLICATION PAUL COTTON SIGNATURE ON ORIGINAL DATED 03/09/04 MANAGER INFRASTRUCTURE MANAGEMENT R.P.E.Q: 2546 | DESIGN | Std Dwgs WG | DATE | OCT '13 |  | BRISBANE CITY COUNCIL STANDARD DRAWING | | |
| | | | | | | DRAWN | CPO - P&D | DATE | OCT '13 | | SCALE AS SHOWN | | |
| | | | | | DESIGN APPROVED LAUREN TEMPLEMAN SIGNATURE ON ORIGINAL DATED 31/08/04 | CHECKED | | DATE | OCT '13 | | BASKETBALL HALFCOURT GENERAL NOTES SHEET 1 OF 2 | | |
| B | Drawing Title Amended | FEB '16 | JUL '16 | JUL '16 | | DRAWING FILENAME | BSD-10211 (B) Basketball halfcourt - General notes - Sheet 1 of 2.dwg | | | | ORIGINAL SIZE | | |
| A | ORIGINAL ISSUE | OCT '13 | OCT '13 | OCT '13 | | ASSOCIATED PLANS | SUPERSEDES NOTES ON UMS-783 & 784 | | | | REVISION | | |
| ISSUE | AMENDMENT | DRAWN DATE | CHK'D DATE | APPR'D DATE | CLIENT POSITION PRICIPAL PROGRAM OFFICER PARKS | | | | | | A3 | | B |

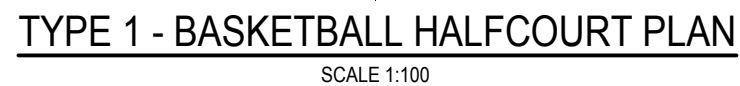

| | | | | | | | | | | | | | | | | |
|-------|--|------------|------------|-------------|--|------------------|--|------|---------|---|--|--|--|-------------------|-----------|--|
| | | | | | DRAWING AUTHORISED FOR PUBLICATION PAUL COTTON SIGNATURE ON ORIGINAL DATED 03/09/04 _____ MANAGER INFRASTRUCTURE MANAGEMENT R.P.E.O: 2546 | DESIGN | Std Dwgs WG | DATE | OCT '13 |  | BRISBANE CITY COUNCIL STANDARD DRAWING BASKETBALL HALFCOURT PLANS AND POST DETAILS SHEET 2 OF 2 | | | SCALE AS SHOWN | | |
| C | Obsolete Drawing Reference Removed from Section Detail | JAN '19 | APR '19 | APR '19 | _____ LAUREN TEMPLEMAN SIGNATURE ON ORIGINAL DATED 31/08/04 _____ CLIENT POSITION PRICIPAL PROGRAM OFFICER PARKS | DRAWN | CPO - P&D | DATE | OCT '13 | | | | | DWG No. | BSD-10211 | |
| B | Drawing Title Amended | FEB '16 | JUL '16 | JUL '16 | | CHECKED | | DATE | OCT '13 | | | | | ORIGINAL SIZE | REVISION | |
| A | ORIGINAL ISSUE | OCT '13 | OCT '13 | OCT '13 | | DRAWING FILENAME | BSD-10211 (C) Basketball halfcourt - Plans and post details - Sheet 2 of 2.dwg | | | | | | | A3 | C | |
| ISSUE | AMENDMENT | DRAWN DATE | CHK'D DATE | APPR'D DATE | | ASSOCIATED PLANS | SUPERSEDES PLANS ON UMS-783 & 784 | | | | | | | | | |

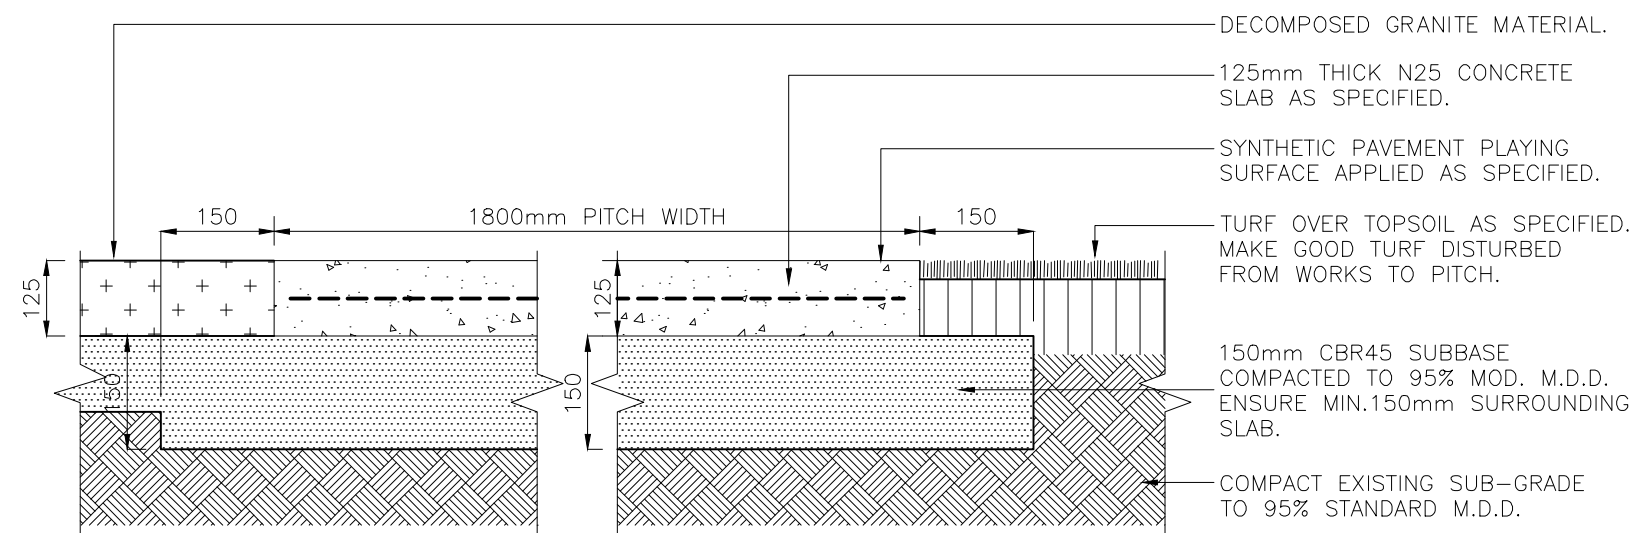


DECO EDGE OPTION

TURF EDGE OPTION


CONCRETE SLAB – SECTION A-A

SCALE 1:10

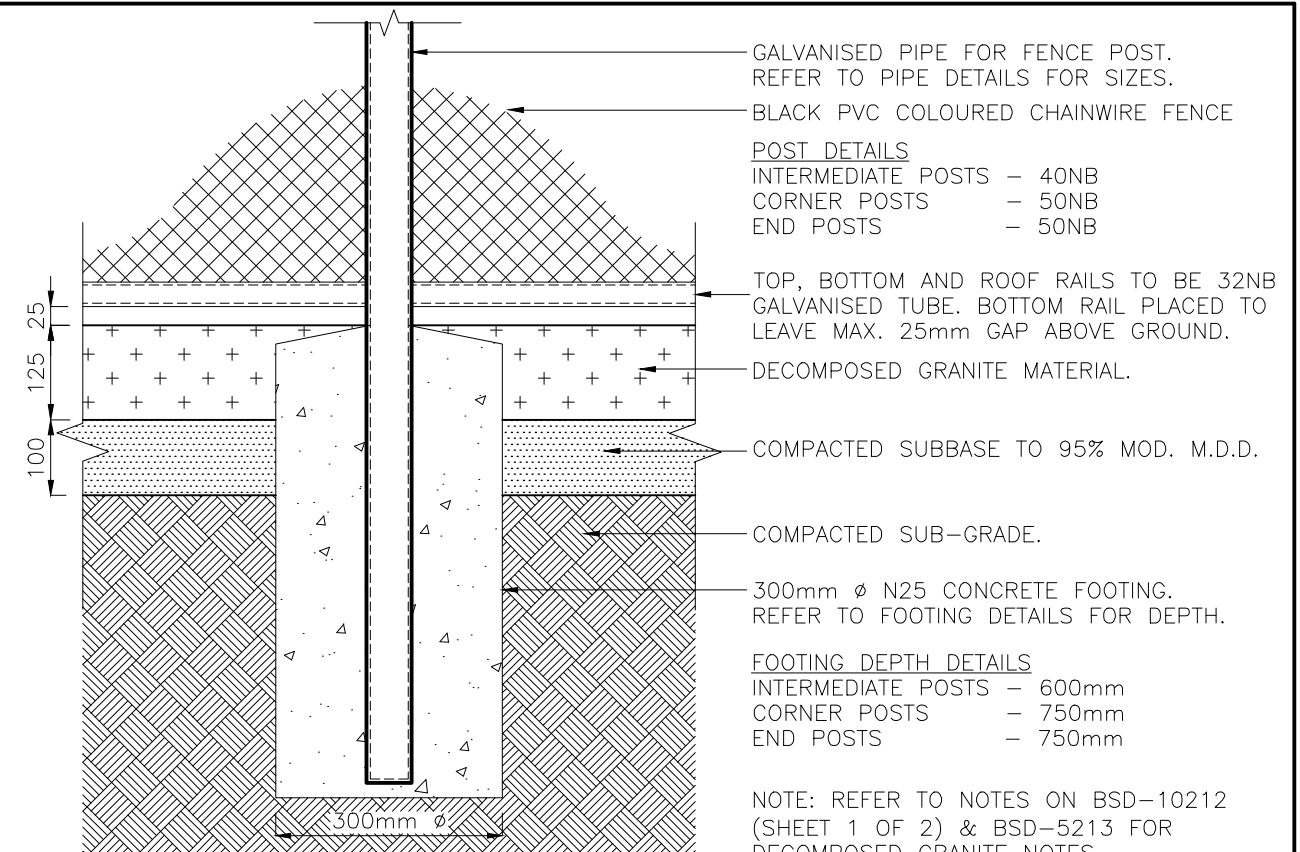

POST FOOTING


SCALE 1:10



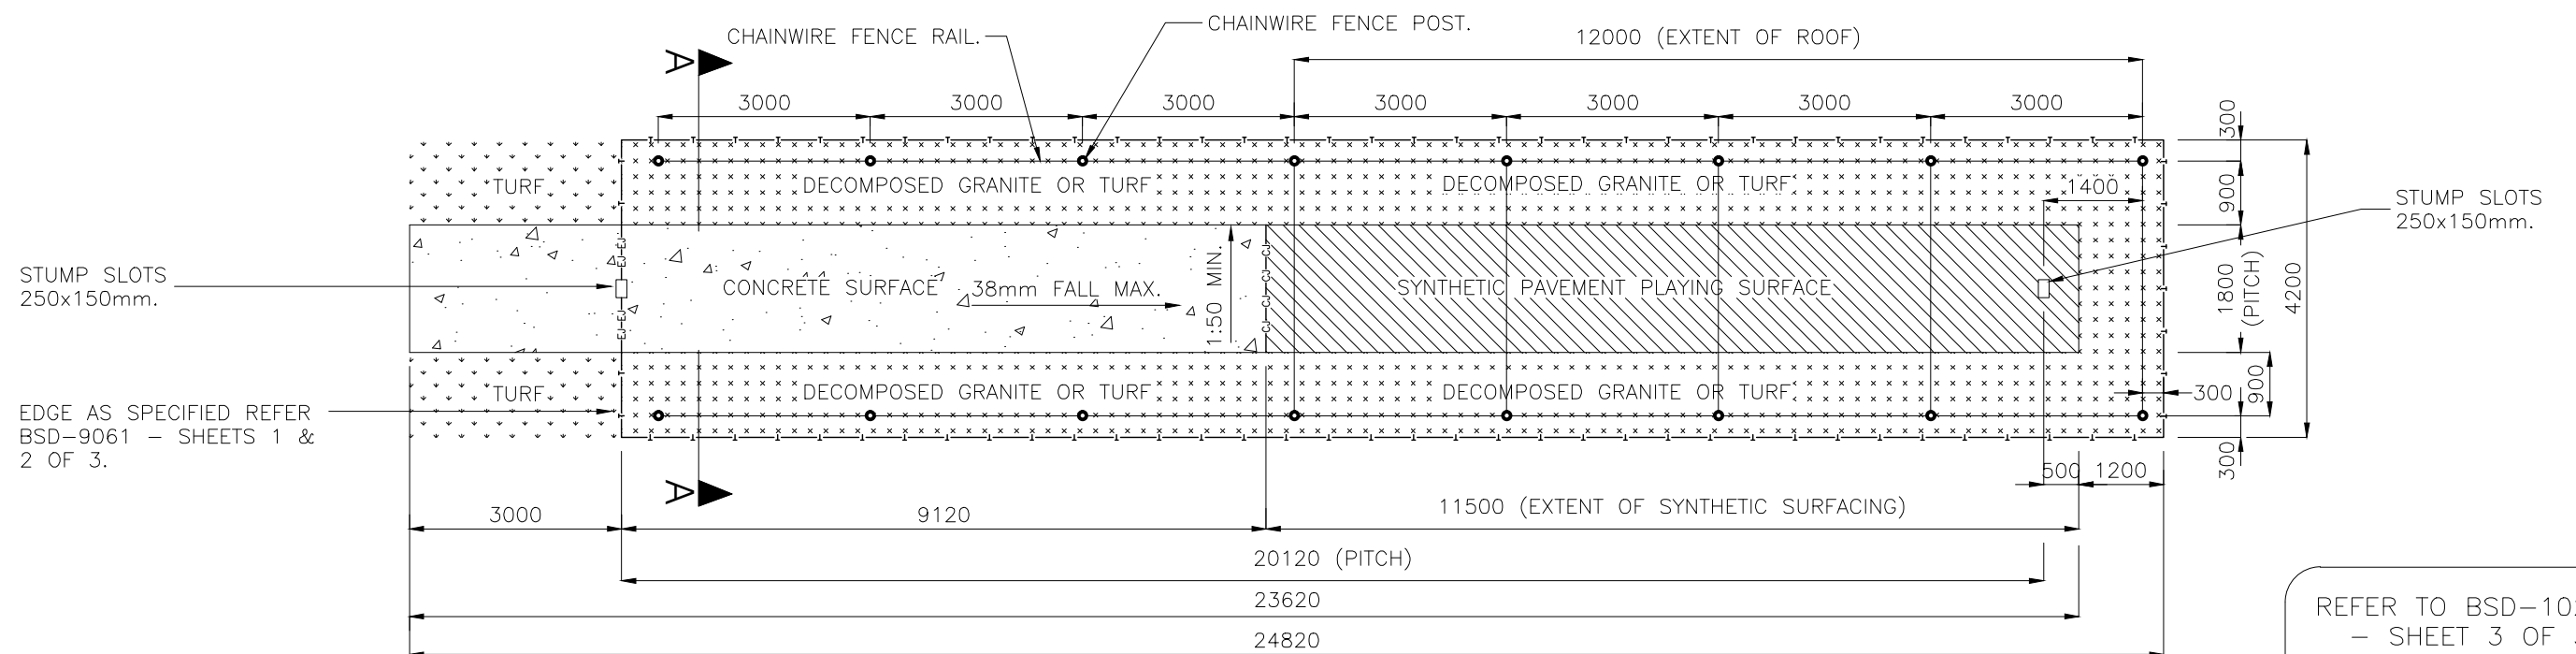


CONCRETE SLAB – PLAN


SCALE 1:100

REFER TO BSD-10212
– SHEET 3 OF 3
FOR CRICKET NET NOTES
& SPECIFICATIONS

| | | | | | | | | | | | | | | |
|-------|--|------------|------------|-------------|--|------------------|--|------|---------|---|---|-------------------|----------|---|
| | | | | | <div>DRAWING AUTHORISED FOR PUBLICATION PAUL COTTON SIGNATURE ON ORIGINAL DATED 03/09/04 MANAGER INFRASTRUCTURE MANAGEMENT R.P.E.Q: 2546</div> | DESIGN | Std Dwgs WG | DATE | OCT '13 |  | BRISBANE CITY COUNCIL STANDARD DRAWING | | | |
| | | | | | <div>DESIGN APPROVED LAUREN TEMPLEMAN SIGNATURE ON ORIGINAL DATED 31/08/04</div> | DRAWN | CPO - P&D | DATE | OCT '13 | | <div>CRICKET PRACTICE NET PLANS AND SECTIONS SHEET 1 OF 3</div> | SCALE AS SHOWN | | <div>DWG No. BSD-10212</div> |
| B | Drawing Title Amended | FEB '16 | JUL '16 | JUL '16 | | CHECKED | UMD - E&P & IMB | DATE | OCT '13 | | | ORIGINAL SIZE | REVISION | |
| A | Drawing Converted From UMS Series April 2014 | APR '14 | APR '14 | APR '14 | | DRAWING FILENAME | BSD-10212 (B) Cricket practice net - Plans and sections - Sheet 1 of 3.dwg | | | | | A3 | B | |
| ISSUE | AMENDMENT | DRAWN DATE | CHK'D DATE | APPR'D DATE | PRICIPAL PROGRAM OFFICER PARKS | ASSOCIATED PLANS | SUPERSEDES UMS-785 | | | | | | | |

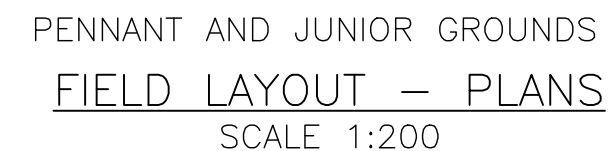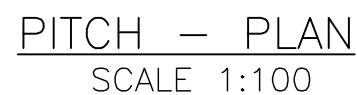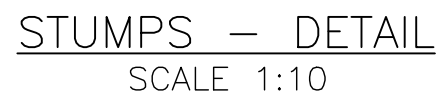

REFER TO BSD-10212
- SHEET 3 OF 3
FOR CRICKET PITCH
SPECIFICATIONS

| | | | | | | | | | | | | | |
|-------|--|---------------|---------------|----------------|---|---------------------|---|------|---------|---|---|--|---------------|
| | | | | | DRAWING AUTHORISED FOR PUBLICATION PAUL COTTON SIGNATURE ON ORIGINAL DATED 03/09/04 MANAGER INFRASTRUCTURE MANAGEMENT R.P.E.Q. 2546 | DESIGN | Std Dwgs WG | DATE | OCT '13 |  | BRISBANE CITY COUNCIL STANDARD DRAWING | | |
| | | | | | DESIGN APPROVED LAUREN TEMPLMAN SIGNATURE ON ORIGINAL DATED 31/08/04 | DRAWN | CPQ – P&D | DATE | OCT '13 | | CRICKET PITCH PLANS AND SECTIONS SHEET 2 OF 3 | SCALE AS SHOWN DWG No. BSD–10212 | |
| B | Drawing Title Amended | FEB '16 | JUL '16 | JUL '16 | | CHECKED | UMD – E&P & IMB | DATE | OCT '13 | | | ORIGINAL SIZE A3 | REVISION B |
| A | Drawing Converted From UMS Series April 2014 | APR '14 | APR '14 | APR '14 | | DRAWING FILENAME | BSD-10212 (B) Cricket pitch - Plans and sections - Sheet 2 of 3.dwg | | | | | | |
| ISSUE | AMENDMENT | DRAWN DATE | CHK'D DATE | APPR'D DATE | PRICIPAL PROGRAM OFFICER PARKS | ASSOCIATED PLANS | SUPERSEDES UMS-786 | | | | | | |

GENERAL NOTES AND SPECIFICATION

- ALL PROPRIETARY FIXINGS SHALL BE INSTALLED TO MANUFACTURERS SPECIFICATIONS.
- DURING CONSTRUCTION THE CONTRACTOR SHALL ENSURE THAT ALL STRUCTURES AND FOOTINGS ARE MAINTAINED IN A SAFE AND STABLE CONDITION. WORKPLACE HEALTH AND SAFETY REGULATION MUST BE ADHERED TO ON ALL SITES.
- SITE TO BE LEFT TIDY & ALL EXCESS FILL/MATERIAL IS TO BE REMOVED BY THE CONTRACTOR OR AS DIRECTED BY SUPERINTENDENT.
- CONTRACTOR MUST NOTIFY COUNCIL OFFICER IN CHARGE 48 HOURS PRIOR TO COMMENCEMENT OF WORK ON SITE, TO INSPECT THE CONCRETE POUR AND FINAL INSPECTION.
- WHERE APPLICABLE - INCORPORATE SITE FURNITURE TO PERIMETER OF FIELD. ENSURE PARK ELEMENTS ARE LOCATED IN ACCORDANCE WITH DETAILED LANDSCAPE PLAN, AND PARKS CHAPTER OF INFRASTRUCTURE DESIGN PLANNING SCHEME POLICY.
- MATERIAL CHOICES ARE TO BE DETERMINED ON THE GROUNDS OF SUSTAINABILITY, LOW MAINTENANCE, VANDAL RESISTANCE, PRODUCT AVAILABILITY AND SUITABILITY TO THE CLIMATIC CONDITIONS AND PRACTICALITY. MATERIALS ARE TO BE LOCALLY SOURCED.
- AUSTRALIAN STANDARDS SHALL BE IN ACCORDANCE WITH THE CURRENT EDITIONS OF THE REFERENCED AUSTRALIAN STANDARDS EXCEPT WHERE VARIED BY SPECIFICATIONS AND/OR DRAWINGS. ENSURE FENCE & POSTS ARE CLEANED OF CONCRETE SLURRY OR SPRAY WHEN INSTALLED TO PREVENT STAINING OR DAMAGE TO APPLIED FINISHES.
- COLOUR SELECTION IN ACCORDANCE WITH STANDARD BCC CORPORATE COLOUR PALETTE (& AS 2700 EQUIVALENT).
- ALL DIMENSIONS IN MILLIMETRES (U.N.O.).

CONCRETE WORKS

- ALL WORKMANSHIP & MATERIALS SHALL COMPLY WITH THE CURRENT AUSTRALIAN STANDARDS IN PARTICULAR AS 3600, AND ANY REQUIREMENTS OF THE LANDSCAPE ARCHITECT.
- PITCH SLAB TO BE 125mm THICK N25 GRADE CONCRETE. CONCRETE SHALL BE NORMAL CLASS CONCRETE UNLESS DIRECTED OTHERWISE. N25 SHALL MEAN NORMAL CLASS CONCRETE WITH A 28 DAY CHARACTERISTIC STRENGTH OF 25MPa. CONCRETE MIX DESIGN SHALL BE SUBMITTED TO THE SITE SUPERINTENDENT FOR APPROVAL FIVE (5) DAYS PRIOR TO ORDERING.
- SL82 MESH SUPPORTED BY 60mm BAR CHAIRS. MESH TO OVERLAP 200mm. ENSURE MIN. TOP COVER 50mm.
- HARD DRAWN STEEL REINFORCING FABRIC GRADE D500L TO AS4671.
- REINFORCEMENT IS SHOWN DIAGRAMMATICALLY AND NOT NECESSARILY IN POSITION.
- ALL CONCRETE SHALL BE PLACED USING A MECHANICAL VIBRATION PROCESS.
- ALL CEMENT TO BE TYPE GP OR GB TO AS 3972 UNLESS SPECIFIED OTHERWISE.
- ENSURE EVEN GRADE FALLS MIN. 1:50 TO FINISHED PITCH SURFACE.
- CONCRETE PITCH SURFACE TO BE 'WOOD FLOAT' FINISH EXCEPT FOR 'TRANSVERSE BROOM FINISH' APPLIED TO RUN-UPS UP TO BOWLING CREASE.
- CONCRETE PITCH MUST BE FLUSH WITH ADJACENT GRASS SURFACES.
- PITCHES TO HAVE MAX. 38mm LONGITUDINAL FALL AND MIN. 1:50 CROSSFALL.
- CONTRACTION JOINTS (CJ) AS LOCATED. JOINT TO BE SAW CUT 6mm WIDE x 40mm DEEP WITHIN 4-12 HRS OF PLACEMENT. PLACE MESH CENTRALLY OVER JOINT & CUT EVERY SECOND BAR OVER JOINT.
- EXPANSION JOINTS (EJ) AS LOCATED. DOWEL TO BE 6mm 'DANLEY DIAMOND' DOWEL AND SLEEVE AT 600mm CENTRES. JOINT TO BE FULL DEPTH 10mm THICK CLOSED CELL CROSS-LINKED POLYETHYLENE FOAM (85-150KG/m³). SEAL SURFACE OF JOINT WITH 10mm DEEP POLYETHYLENE SEALANT ('SIKAFLEX 1A SILICON' OR APPROVED EQUIVALENT) FOR FLUSH FINISH.

PITCH SPECIFICATION

- BOWLERS' RUN-UP TO HAVE A MAXIMUM LONGITUDINAL GRADE OF 1:25 FOR A MINIMUM LENGTH OF 5m BEFORE THE PITCH. BOWLERS' RUN UP REQUIRES COMPACTION OF SUB-GRADE TO 100% STANDARD M.D.D.
- ENSURE TURF FINISHES FLUSH WITH CONCRETE PITCH ONCE MOWN AND ROLLED BY TURF ROLLER.
- FOR SURFACE ON PITCH, REFER TO BSD-10212 (SHEETS 1& 2) FOR DETAILS.
- THE PITCH IS 20.12m LONG BETWEEN CENTRE LINE OF STUMPS, AND 1.520m WIDE EACH SIDE OF THE CENTRE STUMP. FOR JUNIORS PITCH LENGTH MAY BE 19.20m OR 18.30m LONG.
- INTERNATIONAL FIELD: 64m TO 68.m RADIUS (REQUIRING AN AREA OF 1.5ha APPROXIMATELY.) PENNANT FIELD: 60m RADIUS FROM CENTRE OF PITCH.
- JUNIOR FIELD: 40m TO 50m RADIUS.
- FIELD TO FALL AWAY FROM PITCH IN ALL DIRECTIONS AT GRADE OF 1V:100H TO PREVENT SOFT SPOTS NEAR PITCH.


NETS SPECIFICATION

- INDIVIDUAL PITCHES TO BE POURED FIRST. INSTALL BLACK POWDER COATED FENCE POSTS AFTER INSTALLATION OF PITCH.
- FENCE TO BE 3000mm HIGH BLACK PVC COATED MESH WITH BLACK POWDER COATED TOP AND BOTTOM RAILS.
- ROOF TO BE BLACK PVC COATED MESH EXTENDING 12m FROM BACK FENCE, ALONG WITH UPRIGHT POSTS AND CROSS SUPPORTS AT 3000mm CENTRES.
- BOTTOM RAIL TO LEAVE A GAP NO MORE THAN 25mm ABOVE FINISHED CONCRETE SURFACE.

TOPSOIL & TURFING NOTES

- PREPARATION - REMOVE ANY EXISTING TURF, WEEDS, RUBBISH STONES OR DEBRIS FROM AREA TO BE TURFED. CULTIVATE EXISTING SUB-GRADE TO 100mm DEPTH.
- TOPSOIL - ALL TOPSOIL SHALL COMPLY WITH AS 4419 'SOILS FOR LANDSCAPING AND GARDEN USE'. TOPSOIL SHALL BE AN ORGANIC SOIL WITH MAX. 30% SCREENED COMPOSTED ORGANIC MATTER, HYDRAULIC CONDUCTIVITY 15-30 cm/hr. pH RANGE TO BE 5-6.5. AFTER APPROVAL OF THE PROPOSED TOPSOIL, DEPOSIT AND SPREAD TOPSOIL TO ACHIEVE 100mm THICKNESS TO ALL DISTURBED AREAS FOR TURFING AFTER SLAB CONSTRUCTION.
- TURFING - 100% CYNODON DACTYLON CV. 'GREENSLEES PARK' UNLESS OTHERWISE DIRECTED BY LANDSCAPE ARCHITECT. TURF SHALL BE 'A' GRADE, TYPICAL OF THE SPECIES, FREE FROM ALL PESTS, DISEASES, WEEDS AND OTHER PLANT MATTER. TURF SHALL BE GUARANTEED FREE FROM NUT GRASS, CYPERUS ROTUNDUS. TURF SHALL BE CUT TO A MINIMUM 25mm THICK IN LONG 300mm WIDE STRIPS.
- LAYING - LAY PIECES OF TURF IN STRAIGHT LINES RUNNING PERPENDICULAR TO THE SLOPE, WITH CROSS-JOINTS STAGGERED, AND CLOSE BUTTING. LAY TURF WITH AN EVEN GRADIENT, FREE FROM LUMPS AND DEPRESSIONS AND NOT ABLE TO POND WATER. ENSURE THAT NEW TURF FINISHES FLUSH WITH EXISTING TURF. TAMP DOWN WELL AND FILL ALL JOINTS WITH TOP DRESSING. TOP DRESSING IS TO BE PIT SAND TO COMPLY WITH AS 4419. SPREAD SAND EVENLY OVER SURFACE OF GRASS IN LAYERS OF NOT MORE THAN 10mm. DO NOT BURY GRASS.
- TOP DRESSING - WHEN TURFED AREAS HAVE BECOME ESTABLISHED AND IMMEDIATELY AFTER THE FIRST CUT, TOP DRESS TURF WITH 10mm LAYER OF PIT SAND. DO NOT TOP DRESS DURING WINTER MONTHS UNLESS DIRECTED BY SUPERINTENDENT.
- PROTECTION - ALL TURF SHALL BE TEMPORARILY PROTECTED FROM TRAMPLING BY THE ERECTION OF BARRIERS DURING THE PLANT ESTABLISHMENT PERIOD.

REFER TO BSD-10212 - SHEETS 1 & 2
OF 3 FOR CRICKET PRACTICE
NET & PITCH DETAILS

| | | | | | | | | | | | | | | | | | | |
|-------|--|---------------|---------------|----------------|---|---------------------|--|------|---------|---|--|---------------|----|----------|---|--|--|--|
| | | | | | DRAWING AUTHORISED FOR PUBLICATION PAUL COTTON SIGNATURE ON ORIGINAL DATED 03/09/04 MANAGER INFRASTRUCTURE MANAGEMENT R.P.E.Q: 2546 | DESIGN | Std Dwgs WG | DATE | OCT '13 |  | BRISBANE CITY COUNCIL STANDARD DRAWING | | | | | | | |
| | | | | | | DRAWN | CPO - P&D | DATE | OCT '13 | | SCALE AS SHOWN | | | | | | | |
| | | | | | | CHECKED | UMD - E&P & IMB | DATE | OCT '13 | | CRICKET PRACTICE NET NOTES AND SPECIFICATIONS SHEET 3 OF 3 | | | | | | | |
| | | | | | DESIGN APPROVED LAUREN TEMPLEMAN SIGNATURE ON ORIGINAL DATED 31/08/04 | DRAWING FILENAME | BSD-10212 (B) Cricket pitch and nets - Notes and specifications - Sheet 3 of 3.dwg | | | | | | | | | | | |
| | | | | | PRICIPAL PROGRAM OFFICER PARKS | ASSOCIATED PLANS | SUPERSEDES UMS-787 | | | | | | | | | | | |
| B | Drawing Title Amended | FEB '16 | JUL '16 | JUL '16 | | | | | | | | | | | | | | |
| A | Drawing Converted From UMS Series April 2014 | APR '14 | APR '14 | APR '14 | | | | | | | | | | | | | | |
| ISSUE | AMENDMENT | DRAWN DATE | CHK'D DATE | APPR'D DATE | | | | | | | | ORIGINAL SIZE | A3 | REVISION | B | | | |

GENERAL NOTES & SPECIFICATIONS

- ENSURE TENNIS REBOUND WALL IS LOCATED IN ACCORDANCE WITH THE PARKS CHAPTER OF INFRASTRUCTURE DESIGN PLANNING SCHEME POLICY.
- ENSURE MOWN HEIGHT OF GRASS (TURF) AREAS FINISHES FLUSH WITH PLAYING SURFACE.
- ENSURE PARK ELEMENTS ARE CLEANED OF CONCRETE SLURRY OR SPRAY WHEN INSTALLED TO PREVENT STAINING OR DAMAGE TO APPLIED FINISHES.
- THESE DRAWINGS SHALL BE READ IN CONJUNCTION WITH ALL SPECIFICATIONS AND WITH APPROVED WRITTEN INSTRUCTIONS AS ISSUED.
- DURING CONSTRUCTION THE STRUCTURE SHALL BE MAINTAINED IN A STABLE CONDITION AND NO PART SHALL BE OVERSTRESSED.
- STRUCTURAL CERTIFICATION REQUIRED BY RPEQ. STRUCTURAL ENGINEER.
- AUSTRALIAN STANDARDS SHALL BE IN ACCORDANCE WITH THE CURRENT EDITIONS OF THE REFERENCED AUSTRALIAN STANDARDS EXCEPT WHERE VARIED BY SPECIFICATIONS AND/OR DRAWINGS.
- MATERIAL CHOICES ARE TO BE DETERMINED ON THE GROUNDS OF SUSTAINABILITY, LOW MAINTENANCE, VANDAL RESISTANCE, ENVIRONMENTALLY FRIENDLY COMPOSITE MATERIALS, PRODUCT AVAILABILITY AND SUITABILITY TO THE CLIMATIC CONDITIONS AND PRACTICALITY, WHERE POSSIBLE, MATERIALS ARE TO BE LOCALLY MADE OR SOURCED RATHER THAN IMPORTED FROM OVERSEAS UNLESS SPECIFIED OTHERWISE.
- COLOUR SELECTION IN ACCORDANCE WITH STANDARD BCC CORPORATE COLOUR PALETTE (& AS 2700 EQUIVALENT).
- ALL DIMENSIONS IN MILLIMETRES (U.N.O.).

CONCRETE WORK NOTES

- ALL WORKMANSHIP AND MATERIALS SHALL BE IN ACCORDANCE WITH AS 3600.
- REINFORCEMENT SYMBOLS:
 - R = STRUCTURAL PLAIN ROUND GRADE 250R TO AS4671.N = DEFORMED BAR GRADE D500N TO AS 4671.
 - SL = HARD DRAWN STEEL REINFORCING FABRIC GRADE D500L TO AS 4671.
- AT A MINIMUM ALL CONCRETE TO BE GRADE N32. CONCRETE SHALL BE NORMAL CLASS CONCRETE UNLESS DIRECTED OTHERWISE. N32 SHALL MEAN NORMAL CLASS CONCRETE WITH A 28 DAY CHARACTERISTIC STRENGTH OF 32MPa. CONCRETE MIX DESIGN SHALL BE SUBMITTED TO THE SITE SUPERINTENDENT FOR APPROVAL FIVE (5) DAYS PRIOR TO ORDERING.
- SLUMP SHALL BE 80mm. AGGREGATE SHALL BE 20mm.
- MINIMUM CLEAR COVER TO REINFORCEMENT IS AS SHOWN ON DRAWINGS.
- ALL EXPOSED CONCRETE SURFACES SHALL BE CURED USING TWO COATS OF PVA CURING COMPOUND IN ACCORDANCE WITH MANUFACTURER'S INSTRUCTIONS. THE FIRST COAT SHALL BE APPLIED IMMEDIATELY AFTER THE CONCRETE HAS HARDENED. THE SECOND COAT SHALL BE APPLIED AS SOON AS FIRST COAT HAS DRIED.


MASONRY WORK NOTES

- ALL CONCRETE BLOCKWORK SHALL BE CONSTRUCTED IN ACCORDANCE WITH AS 3700, "SAA MASONRY CODE".
- BLOCKS SHALL BE STANDARD "H" TYPE HOLLOW "200" SERIES BLOCKS, HAVING A MINIMUM CHARACTERISTIC UNCONFINED COMPRESSIVE STRENGTH OF 15MPa, U.N.O.
- GROUT FOR FILLING BLOCKWORK SHALL HAVE A MINIMUM CHARACTERISTIC COMPRESSIVE STRENGTH OF 20MPa AND A SLUMP OF 230mm.
- MAXIMUM AGGREGATE SIZE SHALL BE 10mm.
- MORTAR FOR BLOCKWORK SHALL BE CLASSIFICATION M3 IN ACCORDANCE WITH AS 3700 (PROPORTIONS C1:L1:S6 TO C:L0:S5). THE USE OF METHYL CALLULOSE WATER THICKENERS IF REQUIRED, SHALL BE STRICTLY IN ACCORDANCE WITH THE MANUFACTURES RECOMMENDATIONS. RETARD MORTAR SHALL BE USED ONLY WITHIN THE PERIOD OF RETARDATION GUARANTEED BY THE MANUFACTURER.
- PROVIDE CLEAN OUT BLOCKS TO ALL GROUTED CORES. CLEAN OUT MORTAR DROPPINGS AND ALL FOREIGN MATERIAL BY END OF EACH DAY'S WORK.


FOUNDATION WORK NOTES

- FOOTINGS HAVE BEEN DESIGNED FOR A SAFE BEARING PRESSURE OF 50kPA FOUNDED ON UNDISTURBED RESIDUAL SOIL. FOUNDATION DESIGN MATERIAL SHALL BE APPROVED BY GEOTECHNICAL ENGINEER.


REFER TO BSD-10218 - SHEETS 2 OF 3 & SHEET 3 OF 3 FOR FOR ASSOCIATED DETAILS AND SPECIFICATION NOTES


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| | | | | | DRAWING AUTHORISED FOR PUBLICATION PAUL COTTON SIGNATURE ON ORIGINAL DATED 03/09/04 MANAGER INFRASTRUCTURE MANAGEMENT R.P.E.Q: 2546 | DESIGN | Std Dwgs WG | DATE | OCT '13 |  | BRISBANE CITY COUNCIL STANDARD DRAWING | |
| | | | | | | DRAWN | CPO - P&D | DATE | OCT '13 | | SCALE AS SHOWN | |
| | | | | | | CHECKED | UMD - E&P & IMB | DATE | OCT '13 | | DWG No. | |
| B | Drawing Title Amended | FEB '16 | JUL '16 | JUL '16 | DESIGN APPROVED LAUREN TEMPLEMAN SIGNATURE ON ORIGINAL DATED 31/08/04 | DRAWING FILENAME | BSD-10218 (B) Tennis rebound wall - General notes - Sheet 1 of 3.dwg | | | | TENNIS REBOUND WALL GENERAL NOTES SHEET 1 OF 3 | |
| MB | Drawing Converted From UMS Series April 2014 | APR '14 | APR '14 | APR '14 | | ASSOCIATED PLANS | SUPERSEDES NOTES ON UMS -781 & 782 | | | | ORIGINAL SIZE A3 | REVISION B |
| ISSUE | AMENDMENT | DRAWN DATE | CHK'D DATE | APPR'D DATE | PRICIPAL PROGRAM OFFICER PARKS | | | | | | | |


REFER TO BSD-10218 -
SHEET 1 OF 3 & SHEET
3 OF 3 FOR FOR
ADDITIONAL DETAILS AND
SPECIFICATION NOTES

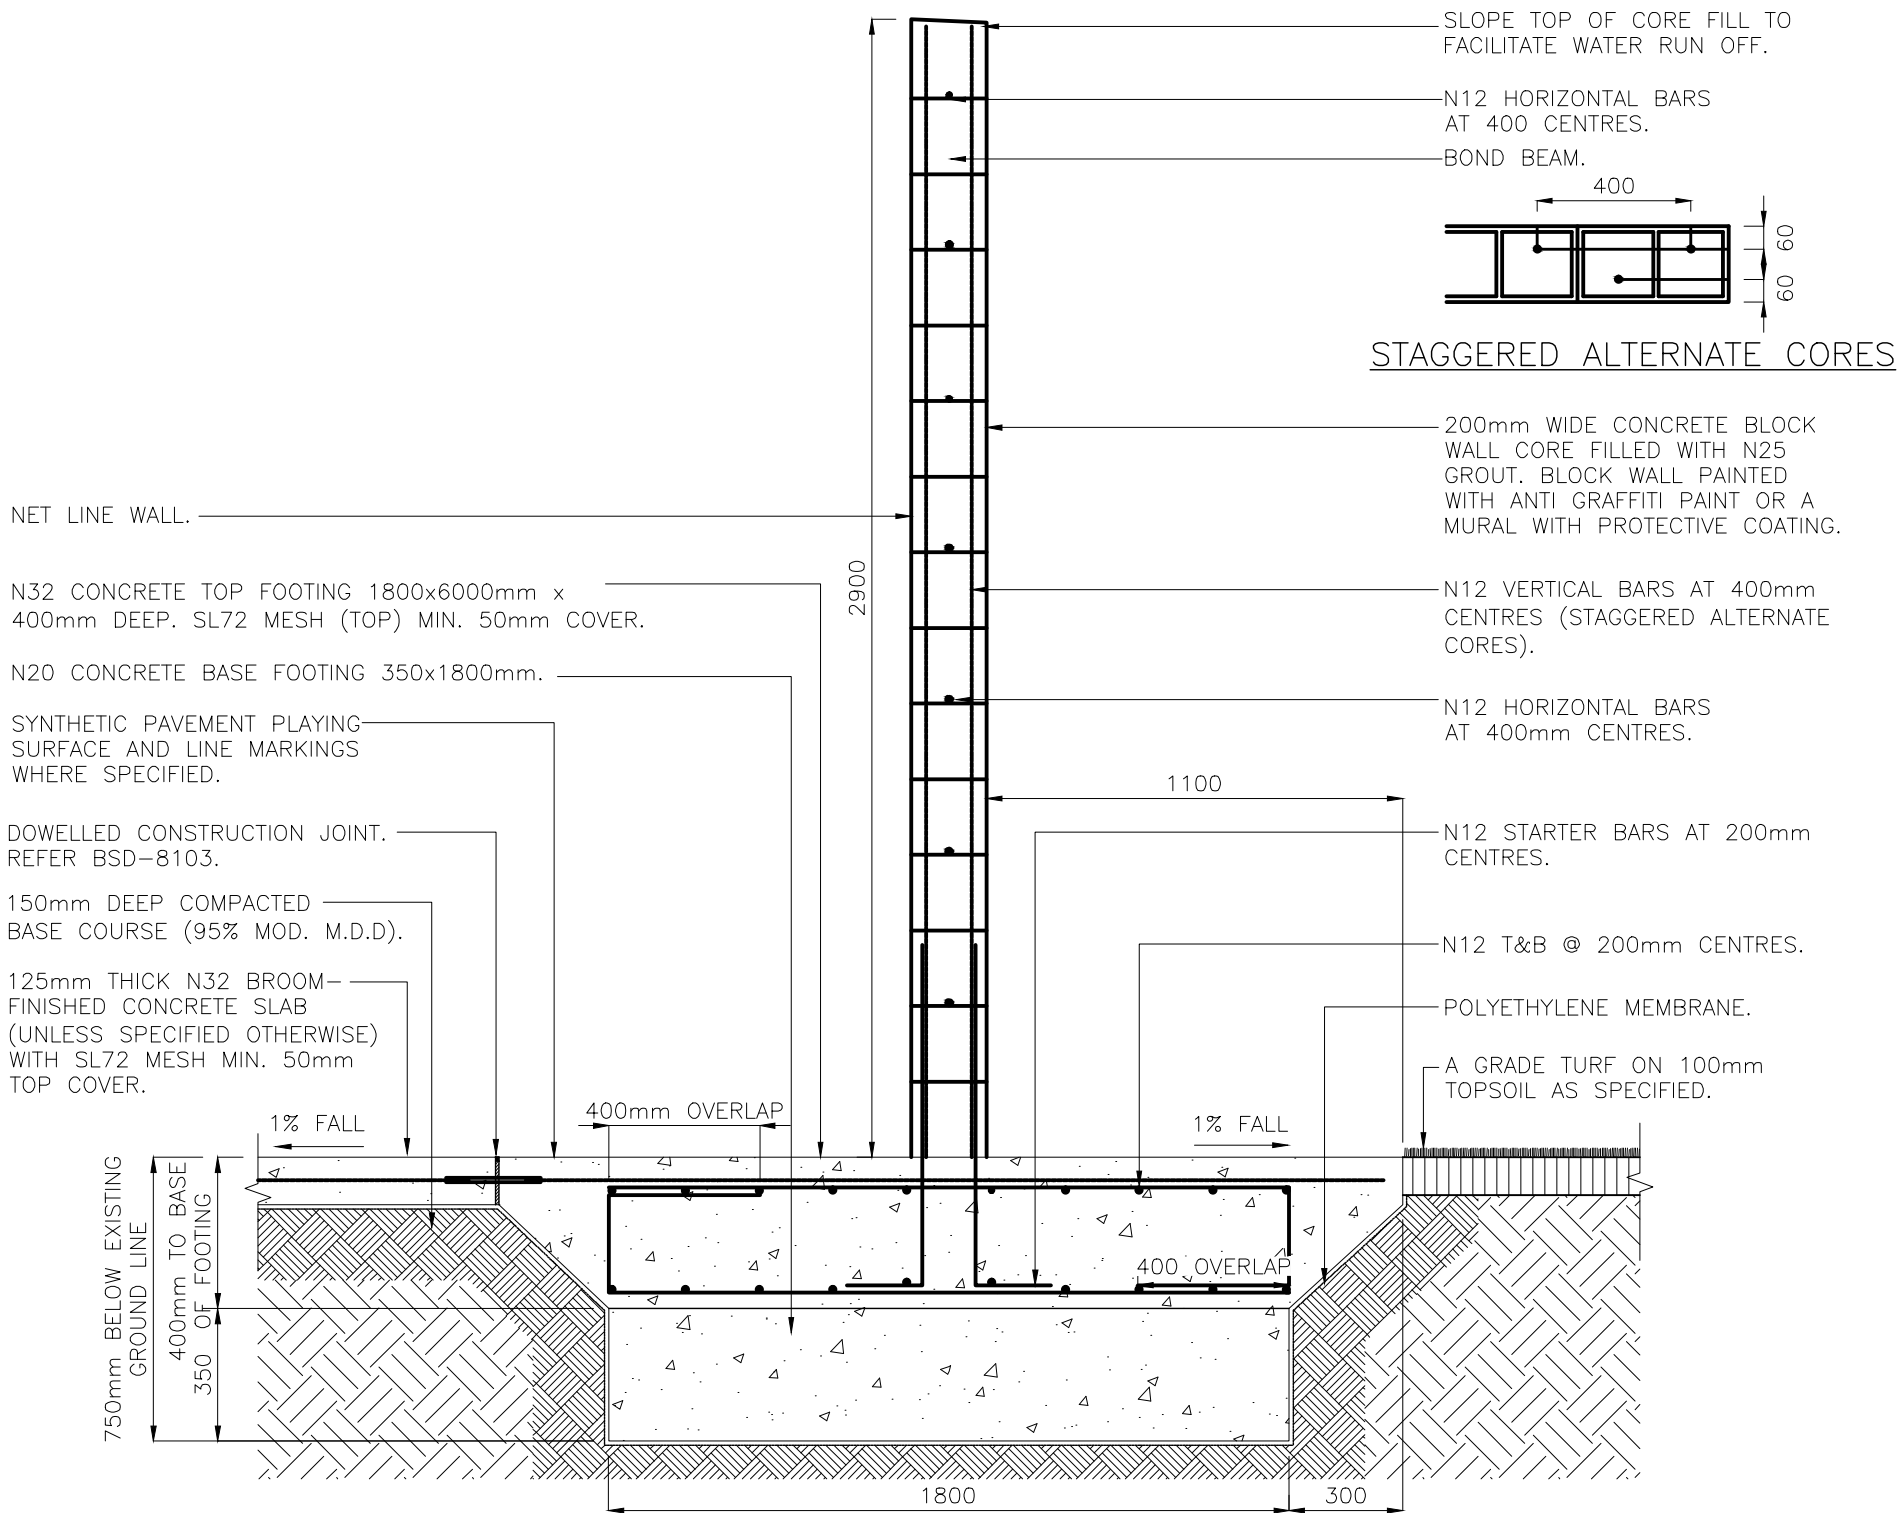



TENNIS REBOUND WALL – SECTION


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|-------|--|---------------|---------------|----------------|--|---------------------|---|------|---------|---|--|----|----------|-----------|
| | | | | | DRAWING AUTHORISED FOR PUBLICATION PAUL COTTON SIGNATURE ON ORIGINAL DATED 03/09/04 ----- MANAGER INFRASTRUCTURE MANAGEMENT R.P.E.O: 2546 | DESIGN | Std Dwgs WG | DATE | OCT '13 |  | BRISBANE CITY COUNCIL STANDARD DRAWING | | | |
| | | | | | DESIGN APPROVED LAUREN TEMPLEMAN SIGNATURE ON ORIGINAL DATED 31/08/04 ----- PRICIPAL PROGRAM OFFICER PARKS | DRAWN | CPO - P&D | DATE | OCT '13 | | TENNIS REBOUND WALL SECTION SHEET 3 OF 3 | | SCALE | 1:20 |
| B | Drawing Title Amended | FEB '16 | JUL '16 | JUL '16 | | CHECKED | UMD - E&P & IMB | DATE | OCT '13 | | | | DWG No. | BSD-10218 |
| A | Drawing Converted From UMS Series April 2014 | APR '14 | APR '14 | APR '14 | | DRAWING FILENAME | BSD-10218 (B) Tennis rebound wall - Section - Sheet 3 of 3dwg | | | | ORIGINAL SIZE | A3 | REVISION | B |
| ISSUE | AMENDMENT | DRAWN DATE | CHK'D DATE | APPR'D DATE | | ASSOCIATED PLANS | SUPERSEDES NOTES ON UMS -781 & 782 | | | | | | | |

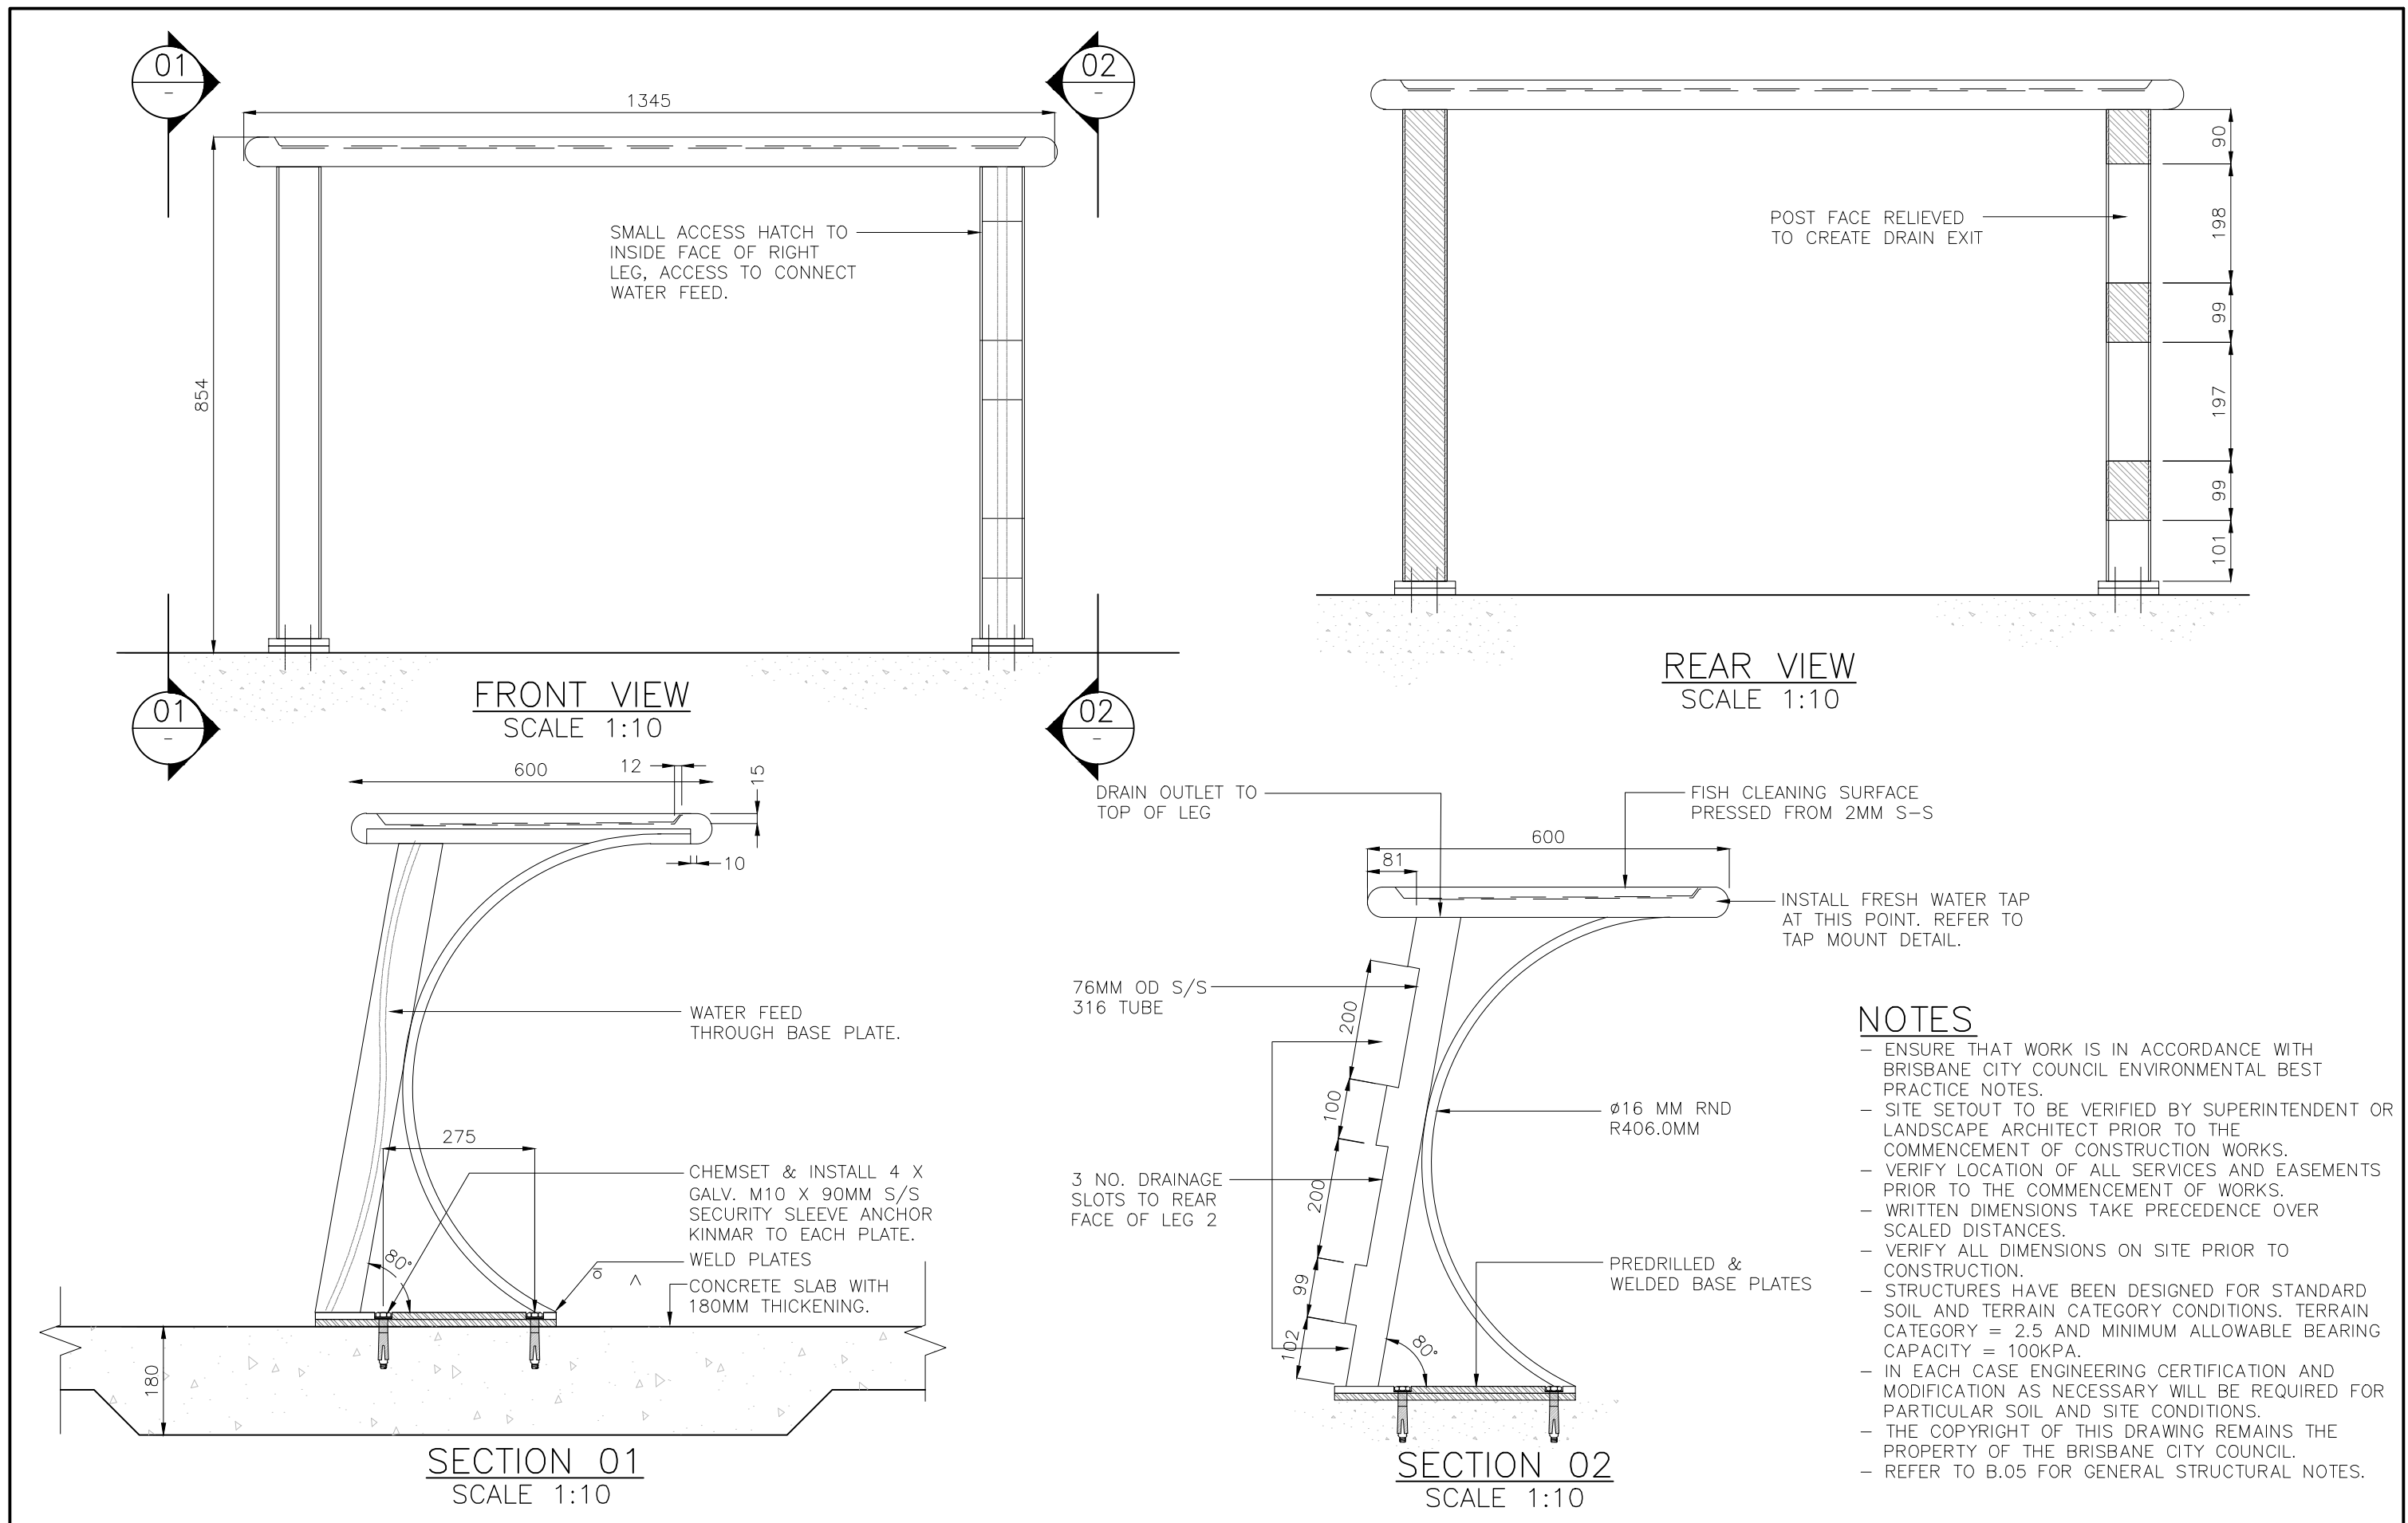

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| | | | | | | DRAWING AUTHORISED FOR PUBLICATION | | DESIGN | | CPO - P&D | | DATE | | DEC '14 | |  | BRISBANE CITY COUNCIL STANDARD DRAWING | | | |
| | | | | | | Inga Condric 2015.06.04 15:33:05+10'00' | | DRAWN | | CPO - P&D | | DATE | | DEC '14 | | | SCALE AS SHOWN | | | |
| | | | | | | for ASSET ENGINEERING MANAGER STRATEGIC ASSET MANAGEMENT | | CHECKED | | BI - FSG - AS | | DATE | | DEC '14 | | | DWG No. BSD-10262 | | | |
| B | | Drawing Title Amended | | FEB '16 | | JUL '16 | | JUL '16 | | DESIGN APPROVED | | DRAWING FILENAME | | BSD-10262 (B) Fish cleaning table - Notes and elevations - Sheet 1 of 2.dwg | | | ORIGINAL SIZE A3 | | REVISION B | |
| A | | ORIGINAL ISSUE | | DEC '14 | | DEC '14 | | DEC '14 | | | | ASSOCIATED PLANS | | BSD-10262-Sheet 2 | | | | | | |
| ISSUE | | AMENDMENT | | DRAWN DATE | | CHK'D DATE | | APPR'D DATE | | SENIOR CO-ORDINATOR NATURAL ENVIRONMENT ASSET SERVICES/BRISBANE INFRASTRUCTURE | | | | | | | | | | |

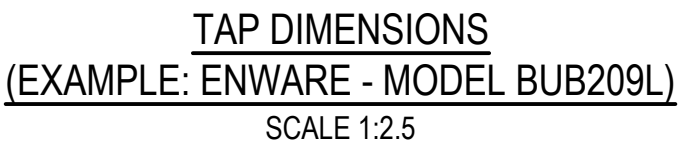

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| | | | | | <div>DRAWING AUTHORISED FOR PUBLICATION</div> <div>Inga Condric 2015.06.04 15:33:44+10'00'</div> <div>for ASSET ENGINEERING MANAGER STRATEGIC ASSET MANAGEMENT</div> <div>DESIGN APPROVED</div> <div>C.Wood</div> <div>SENIOR CO-ORDINATOR NATURAL ENVIRONMENT ASSET SERVICES/BRISBANE INFRASTRUCTURE</div> | DESIGN | CPO - P&D | DATE | DEC '14 |  | BRISBANE CITY COUNCIL STANDARD DRAWING | | | |
| | | | | | | DRAWN | CPO - P&D | DATE | DEC '14 | | SCALE AS SHOWN | | | |
| C | Details and Dimensions Corrected, DDA Compliance for Tap Added | DEC '18 | APR '19 | APR '19 | | CHECKED | BI - FSG - AS | DATE | DEC '14 | | Dwg No. BSD-10262 | | | |
| B | Drawing Title Amended | FEB '16 | JUL '16 | JUL '16 | | DRAWING FILENAME | BSD-10262 (C) Fish cleaning table - Details - Sheet 2 of 2.dwg | | | | ORIGINAL SIZE A3 | | | |
| A | ORIGINAL ISSUE | DEC '14 | DEC '14 | DEC '14 | | ASSOCIATED PLANS | BSD-10262-Sheet 1 | | | | REVISION C | | | |
| ISSUE | AMENDMENT | DRAWN DATE | CHK'D DATE | APPR'D DATE | FISH CLEANING TABLE DETAILS SHEET 2 OF 2 | | | | | | | | | |

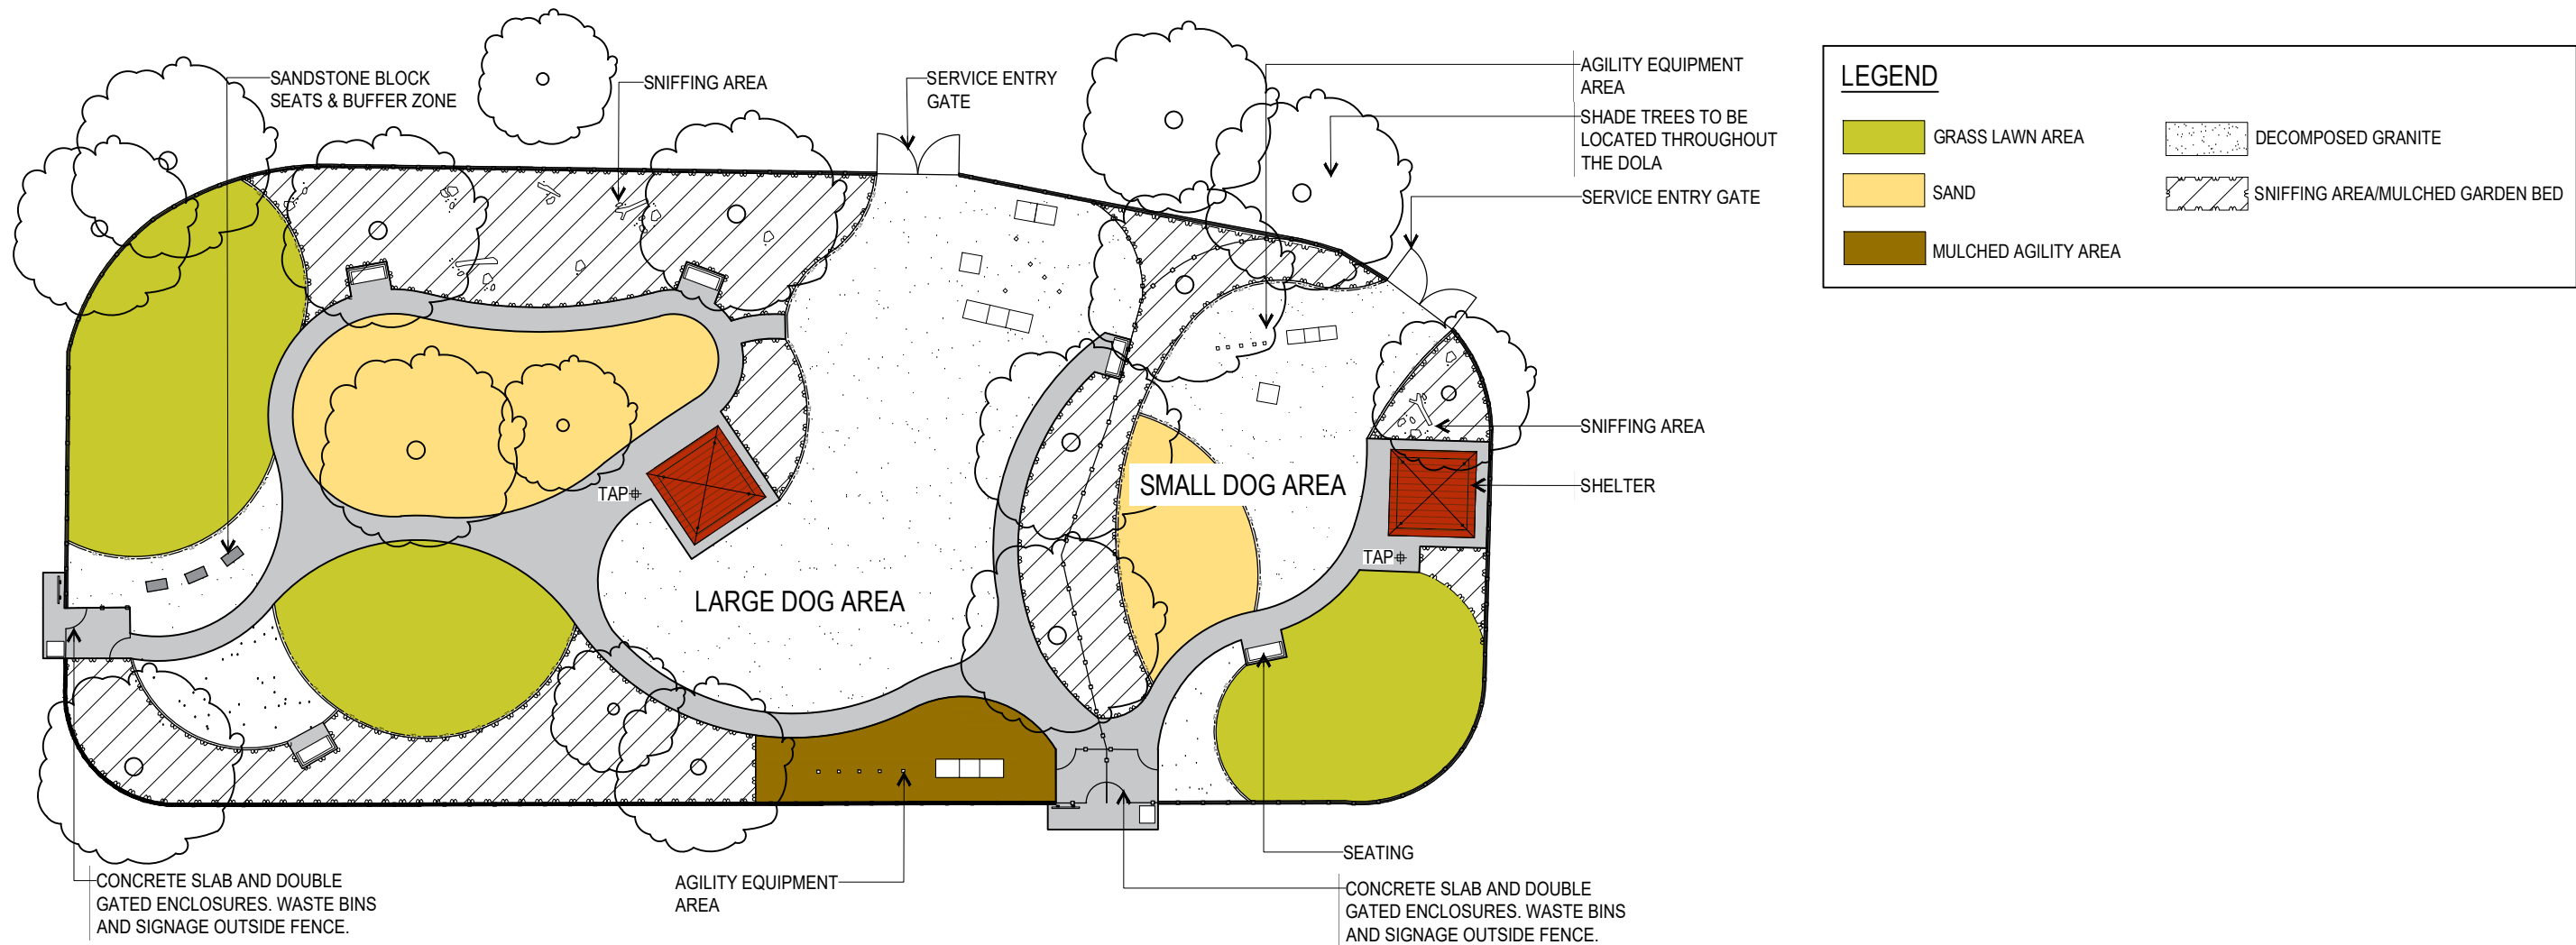

DOG OFF LEASH AREAS (DOLA) - PLAN
PLAN INDICATIVE OF LAYOUT ONLY. DESIGN TO BE SITE SPECIFIC & RESPONSIVE.

DOG OFF LEASH AREAS (DOLAS) - DESIGN ELEMENTS
ACTIVITY ZONES

- AZ1. CREATE ZONES IN BOTH THE LARGE AND SMALL DOG AREAS.
- AZ2. CREATE A GRASS LAWN AREA FOR QUIET, OR REST SPACE. MAXIMUM 30% OF THE DOLA AREA USING TIFF TUFF TURF OR SIMILAR. LOCATE GRASS AREAS AWAY FROM EXISTING OR FUTURE SHADE TREES.
- AZ3. CREATE AN AGILITY ZONE/ZONES WITH A JUMP, TUNNEL, RAMP AND WEAVING POLES OR SIMILAR, IN BOTH LARGE & SMALL DOG ENCLOSURES. THESE ZONES SHOULD BE CHARACTERISED BY DECO AND SHOULD MAKE UP MAXIMUM 30% OF THE DOLA AREA.
- AZ4. CREATE SNIFFING ZONES WITH MULCHED GARDEN BEDS, BOULDERS, LOGS AND STRAPPY PLANTING. SNIFFING ZONES SHOULD MAKE UP MAXIMUM 20% OF THE DOLA AREA.

- AZ5. CREATE A SANDPIT FOR DIGGING. LOCATION OF THE SANDPIT CAN BE USED AS A BUFFER TO REDUCE THE ABILITY OF DOGS TO GET UP TO SPEED ACROSS THE PARK. SANDPIT ZONES SHOULD MAKE UP APPROXIMATELY 10% OF THE DOLA AREA.
- AZ6. DESIGN ACTIVITY ZONES WITH INTERNAL DOLA BUFFERING (SANDPIT/SEATING/MOUNDING) OR VEGETATION BETWEEN THEM. INTERNAL BUFFERS ARE TO REDUCE LONG HIGH SPEED RUNS AND MODIFY DOG BEHAVIOUR. HUMANS MUST BE ABLE TO SEE OVER MOUNDS AND VEGETATION TO MAINTAIN SUPERVISION OF THEIR DOG/S.
- AZ7. DESIGN TURF AREAS FOR EASY MOWING MAINTENANCE.
- AZ8. CONCRETE PATHWAYS ARE TO BE USED AS CONNECTIONS AND DEMARCATION BETWEEN ZONES. CONCRETE EDGES SHOULD BE USED AS BORDERS BETWEEN ZONES WHERE PATHWAYS DON'T OCCUR (REFER TO BSD 9061).


EXTERNAL DOLA BUFFERING

- BU1. PROVIDE ADEQUATE LANDSCAPE BUFFERING TO ADJACENT ACTIVITY AREAS, NODES OR RESIDENTIAL PROPERTIES, USING A COMBINATION OF LANDFORM, MOUNDING AND PLANTING TO CREATE BUFFERS OUTSIDE OF THE DOLA FENCE.
- BU2. ENSURE CRIME PREVENTION THROUGH ENVIRONMENTAL DESIGN (CPTED) PRINCIPLES ARE USED IN DESIGN. ENSURE HUMANS CAN SEE OVER BUFFERS FOR PASSIVE SURVEILLANCE.

ACCESSIBILITY

- AC1. REFER TO THE BRISBANE ACCESS AND INCLUSION PLAN 2012-2017 FOR FURTHER INFORMATION WHEN PLANNING AND DESIGNING THE BUILT ENVIRONMENT TO REASONABLY CONSIDER ACCESS AND INCLUSION FOR ALL WHERE APPROPRIATE.
- AC2. PATHWAYS TO COMPLY WITH AS1428.

THE FITNESS FOR PURPOSE OF THIS STANDARD DRAWING FOR A SPECIFIC PROJECT SHALL BE ASSESSED AND ACCEPTED BY A SUITABLY QUALIFIED REGISTERED PROFESSIONAL ENGINEER OF QUEENSLAND (RPEQ).

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|---|---|--|----------------|
|  | BRISBANE CITY COUNCIL STANDARD DRAWING | | PUBLISH DATE |
| | DOG OFF LEASH AREAS GENERAL ARRANGEMENT & LAYOUT SHEET 1 OF 2 | | March 2021 |
| | | | SCALE |
| | | | NOT TO SCALE |
| | | | DRAWING NUMBER |
| | | | BSD-10281 |
| | | | ORIGINAL SIZE |
| | | | A3 |
| | | | REVISION |
| | | | B |

INFRASTRUCTURE SPECIFICATIONS

FENCE AND GATES

- FG1. LOCATE FENCE AS PER LANDSCAPE PLAN FOR DOLA.
- FG2. PROVIDE A 1200MM HIGH CHAIN WIRE FENCE AS PER BSD-7007. UTILISE FENCE PANELS TO CREATE CURVED EDGES.
- FG3. ENSURE FENCING FOLLOWS LANDFORM PROFILES RESHAPING GROUND WHERE NECESSARY TO MINIMISE FENCE PANEL STEPPING.
- FG4. PROVIDE TWO DOUBLE GATED ENCLOSURES TO LARGE DOG AREA AND ONE DOUBLE GATED ENCLOSURE TO SMALL DOG AREA. REFER TO BSD-7032, SHEET 1 AND 2.
- FG5. IF CONFIGURATION ALLOWS UTILISE THE SAME CONCRETE PAD FOR SMALL DOG AND LARGE DOG ENTRY GATES.
- FG6. PROVIDE CONCRETE SLAB TO BASE OF GATED ENTRY AND EXTEND CONCRETE SLAB BY 2 METRES (MINIMUM) FROM BOTH ENTRY GATES INTO AND OUT OF THE DOLA.
- FG7. WHERE POSSIBLE INSTALL DECOMPOSED GRANITE FROM EDGE OF THE INTERNAL ENTRY CONCRETE SLAB, TO BUFFER THIS HIGH USE ZONE FROM THE REST OF THE DOLA.
- FG8. ENSURE THE GATE LATCH IS SUITABLE FOR PEOPLE WITH SPECIAL NEEDS. REFER TO BSD - 7032.
- FG9. PROVIDE A 4 METRE WIDE SERVICE ENTRY FOR EACH LARGE AND SMALL DOG AREAS CONSISTING OF A DOUBLE GATE FOR MAINTENANCE/ EMERGENCY VEHICLES. REFER TO BSD-7032.

INTERNAL PATHWAYS

- PW1. CREATE INTERNAL CONCRETE OR DECOMPOSED GRANITE PATHWAYS WITH CONCRETE EDGING, THAT MEANDER THROUGH THE DOLA AND HELP PROMOTE MOVEMENT. THE PATHS ARE TO DEFINE THE DIFFERENT ACTIVITY ZONES. PATHS CONNECT SEATING NODES AND BOTH ENTRIES IN THE LARGE DOG AREA, AND THE ENTRY NODE AND SEATING AREAS IN THE SMALL DOG AREA.
- PW2. PATHWAYS ARE MINIMUM 1.2 METRES WIDE TO MEET ACCESS AND MOBILITY DESIGN STANDARDS, AS1428.

PLANTING

- P1. GARDEN BEDS ARE TO FLOW FROM INTERNAL DOLA AREAS TO OUTSIDE THE DOLA FENCE AS BUFFERING AND AMENITY WHERE SPACE ALLOWS.
- P2. ENSURE PLANTS ARE NON TOXIC AND INCORPORATE SHADE TREES INSIDE THE DOLA AND OUTSIDE ADJACENT TO THE NORTHERN DOLA FENCE.
- P3. SHADE TREES SPECIES SELECTION SHOULD FIRSTLY REFLECT THE PLANT PALETTE ALREADY PRESENT IN THE PARK (EXCLUDING EXISTING WEED SPECIES).
- P4. NEW TREES PLANTED IN THE DOLA TO HAVE TREE GUARDS TO PREVENT MARKING.

MULCH

- MU1. INSTALL 'TAKURA ENGINEERED MULCH' OR SIMILAR, TO GARDEN BEDS AND ONE AGILITY AREA TO A DEPTH OF 150MM.

SAND

- SA1. INSTALL WASHED RIVER SAND TO DIGGING AREA TO A MINIMUM DEPTH OF 300MM.

SEATING NODES

- SN1. INSTALL SEATING IN SHELTERS AND THROUGHOUT DOLA, UTILISING SHADE FROM TREES OR SHELTER.
- SN2. ENSURE FURNITURE IS NOT TO BE CONSTRUCTED WITH SLATS TO PREVENT PAW ENTRAPMENT, OR WITH A GAP BETWEEN SEAT AND BACK. SELECT ALUMINIUM EXTRUDED FURNITURE WITH NO GAPS OVER 10MM BETWEEN LENGTHS.
- SN3. LOCATE BENCH SEATS STRATEGICALLY TO PREVENT DOGS HAVING LONG UNOBSTRUCTED RUNS TO REDUCE 'SHOULDER BARGING' BEHAVIOUR.

SHELTERS

- SH1. FOR SITES LACKING SHADE A STANDARD PARK SHELTER CAN BE INCORPORATED. REFER TO BSD-10131. NOTE THAT SHELTER POSTS FOR DOLAS MUST BE ALUMINIUM TO ELIMINATE RUSTING OF STANDARD STEEL POSTS DUE TO DOG MARKINGS.

WASTE BINS & DOG WASTE BAG DISPENSERS

- WB1. LOCATE ONE WASTE BIN AND ONE BAG DISPENSER ON THE CONCRETE SLAB OUTSIDE EACH ENTRY POINT.
- WB2. DOG WASTE BAG DISPENSER TO BE INSTALLED ON FENCE NEXT TO DOLA ENTRANCE. BSD CURRENTLY UNDERGOING CREATION, PLEASE CONTACT WASTE AND RESOURCE RECOVERY SERVICES (WARRS).
- WB3. BIN TYPE 240L 'GUARDIAN' POLE WASTE BIN. BSD CURRENTLY UNDERGOING CREATION, PLEASE CONTACT WASTE AND RESOURCE RECOVERY SERVICES (WARRS).

SIGNAGE

- SG1. LOCATE SIGNAGE OUTSIDE DOLA ENTRY POINTS AND ALONG FENCE IF POSSIBLE TO REDUCE VISUAL IMPACT.
- SG2. REFER TO BSD-10508 AND BCC'S PARK SIGNAGE MANUAL - DOG OFF LEASH AREA SIGNS.

LIGHTING

- LT1. IF LIGHTING IS REQUIRED, LIGHTING OF DOLAS MUST CONSIDER TIMING DEVICES TO MINIMISE IMPACT ON LOCAL RESIDENCES.

DRAINAGE

- DR1. ENSURE RETICULATION TRENCHES AVOID TREE ROOT DAMAGE & ALIGNMENT TO BE APPROVED BY ARBORIST.

DOG OFF LEASH AREAS (DOLAS) SITING NOTES FOR NEW INSTALLATIONS

CONSULTATION

- CN1. CONSULT WITH LANDSCAPE ARCHITECT FOR THE PREPARATION OF A PLAN OF NEW DOLA AND SITING DOLA WITHIN THE PARK.

PARK TYPE

- PT1. LOCATE DOLA IN BCC METROPOLITAN, DISTRICT OR LOCAL PARKS OVER 10,000m².
- PT2. LOCATE DOLA IN A PARK WITH CLASSIFICATION OF GENERAL RECREATION PARK OR CORRIDOR PARK (NOT NEAR WATERWAY).
- PT3. DO NOT INSTALL DOLA IN NATURAL AREA PARKS, HERITAGE PARKS, OR SPORTS PARKS THAT HAVE LESS THAN 3000 SQUARE METRES OF SPACE OUTSIDE FIELDS AND CLUB ROOMS.
- PT4. DOLA SHOULD BE SETBACK FROM OR HAVE SPACE AVAILABLE TO BUFFER CONFLICTING ACTIVITIES INCLUDING PLAYGROUNDS, PICNIC NODES, BIKEWAYS, BIKE TRACKS AND BALL GAME AREAS.

SITE QUALITIES

- SQ1. OVERALL SITE IS FLAT, SOME MOUNDS OR RAISED AREAS PREFERRED, BUT CAN BE DEVELOPED AS PER THE LANDSCAPE PLAN.
- SQ2. IDEALLY THE DOLA IS NOT TO BE LOCATED WITHIN A FLOOD ZONE. IF ONLY AVAILABLE PARK SPACE FOR A NEW DOLA IS IN THE FLOOD ZONE THEN IT MUST ONLY BE PARTIALLY OR TOTALLY UNFENCED.
- SQ3. SITE IS TO BE WELL DRAINED WITH A MINIMUM CROSS FALL OF 1:100.
- SQ4. PERMEABLE SOILS ARE PREFERRED.

SIZE AND CONFIGURATION

- SC1. MINIMUM SIZE OF DOLA IS 3000 SQUARE METRES AND SHOULD INCLUDE LARGE AND SMALL DOG ENCLOSURES.
- SC2. DESIGN FENCES WITH CURVED ALIGNMENTS TO AVOID CORNERS WHICH CAN ENCOURAGE BULLYING DOG BEHAVIOUR.

EXISTING INFRASTRUCTURE

- EX1. UTILISE EXISTING PATHWAYS/LOCAL TRAIL NETWORKS FOR CONNECTIONS TO THE DOLA.
- EX2. UTILISE PROXIMITY TO, OR ALLOW FOR FUTURE CONSTRUCTION OF OFF STREET CAR PARKING NEAR TO DOLA SITE.

LOCATION WITHIN PARK

- LP1. ENSURE DOLA LOCATION MINIMISES THE IMPACT ON USE OF PARK OPEN SPACE.
- LP2. UTILISE EDGES OR CORNER OF PARKS RATHER THAN CENTRAL GRASS AREAS TO SITE DOLA. DO NOT UTILISE ENTIRE LENGTH OF PARK BOUNDARY AS THIS WILL REDUCE GENERAL PARK ACCESS.
- LP3. DOLA MUST BE HIGHLY VISIBLE FROM SURROUNDING AREAS AND INCORPORATE THE PRINCIPLES OF CRIME PREVENTION THROUGH ENVIRONMENTAL DESIGN (CPTED).

SHADE TREES

- ST1. UTILISE EXISTING SHADE TREES ON SITE.
- ST2. PLANT NEW TREES BOTH INTERNALLY AND EXTERNALLY TO THE DOLA TO ACHIEVE A MINIMUM SHADE COVER OF 30%.
- ST3. REFER TO LANDSCAPE PLAN FOR INDICATIVE LAYOUT.
- ST4. AVOID PLANTING TREES TO THE NORTH OF LAWN AREAS.

ACCESSIBILITY

- AC1. PROVIDE A CONTINUOUS DDA COMPLIANT PATH TO THE DOLA FROM A CAR PARK OR ADJOINING ROAD AND PARK FACILITIES.

THE FITNESS FOR PURPOSE OF THIS STANDARD DRAWING FOR A SPECIFIC PROJECT SHALL BE ASSESSED AND ACCEPTED BY A SUITABLY QUALIFIED REGISTERED PROFESSIONAL ENGINEER OF QUEENSLAND (RPEQ).



BRISBANE CITY COUNCIL STANDARD DRAWING

DOG OFF LEASH AREAS
GENERAL ARRANGEMENT & LAYOUT
SHEET 2 OF 2

| | | |
|----------------|----------|--------------|
| PUBLISH DATE | | March 2021 |
| SCALE | | NOT TO SCALE |
| DRAWING NUMBER | | BSD-10281 |
| ORIGINAL SIZE | REVISION | |
| A3 | B | |

GENERAL NOTES & SPECIFICATIONS

- ENSURE TAPS ARE LOCATED IN ACCORDANCE WITH THE PARKS CHAPTER OF INFRASTRUCTURE DESIGN PLANNING SCHEME POLICY.
- ENSURE MOWN HEIGHT OF GRASS (TURF) FINISHES FLUSH WITH PAVEMENT AREA. ENSURE GARDEN AREAS (MULCH) FINISH 25mm BELOW ADJACENT F.S.L’s OF PAVEMENT AREA.
- AUSTRALIAN STANDARDS SHALL BE IN ACCORDANCE WITH THE CURRENT EDITIONS OF THE REFERENCED AUSTRALIAN STANDARDS EXCEPT WHERE VARIED BY SPECIFICATIONS AND/OR DRAWINGS.
- MATERIAL CHOICES ARE TO BE DETERMINED ON THE GROUNDS OF SUSTAINABILITY, LOW MAINTENANCE, VANDAL RESISTANCE, ENVIRONMENTALLY FRIENDLY COMPOSITE MATERIALS, PRODUCT AVAILABILITY AND SUITABILITY TO THE CLIMATIC CONDITIONS AND PRACTICALITY. WHERE POSSIBLE, MATERIALS ARE TO BE LOCALLY MADE OR SOURCED RATHER THAN IMPORTED FROM OVERSEAS UNLESS SPECIFIED OTHERWISE.
- ENSURE TAPS ARE CLEANED OF CONCRETE SLURRY OR SPRAY WHEN INSTALLED TO PREVENT STAINING OR DAMAGE TO APPLIED FINISHES.
- COLOUR SELECTION IN ACCORDANCE WITH STANDARD BCC CORPORATE COLOUR PALETTE (& AS 2700 EQUIVALENT). IF NO COLOUR SPECIFIED, POST TO BE BCC GREEN 1.
- ALL DIMENSIONS IN MILLIMETRES (U.N.O.).

TIMBER WORK NOTES

- TIMBER SHOULD BE SOURCED FROM LEGAL AND SUSTAINABLE SOURCES. TIMBERS ARE CONSIDERED ACCEPTABLE WHERE THERE IS A HIGH DEGREE OF CERTAINTY THAT THEY ARE FROM FORESTS, EITHER NATIVE OR PLANTATION, THAT ARE LEGALLY HARVESTED AND SUSTAINABLY MANAGED. THE CONTRACTOR IS TO SUBMIT EVIDENCE THAT THE TIMBER HAS BEEN OBTAINED FROM A LEGAL AND SUSTAINABLE SOURCE.
- ALL TIMBER TO BE ACQ PRESSURE TREATED OR TANALITH E (COPPER AZOL) TO AS 1608 TREATED ROUGH SAWN APPEARANCE GRADE HARDWOOD OF ONE SPECIES.
- ALL EXPOSED EDGES TO RECEIVE MIN. 5mm WIDE ARRIS.
- PRIOR TO INSTALLATION, ALL CUTS, EDGES, JOINTS TO RECEIVE LIBERAL COATINGS WITH AN APPROVED TIMBER PRESERVATIVE.
- ALL TIMBER IN CONTACT WITH GROUND TO BE PRESERVATIVE TREATED TO HAZARD CLASS H5 TO AS 1604 AND HAVE A DURABILITY CLASS 1 OR 2 TO AS 5604.
- ALL TIMBER TO BE FREE OF KNOTS, SPLINTERS, CRACKS OR ANY MAJOR DEFECT.
- TIMBER PRESERVATIVES – WHERE NO FINISH SPECIFIED, ALL TIMBER TO RECEIVE 3 No COATS OF CLEAR APPROVED TIMBER PRESERVATIVE SUCH AS COPPER NAPTHENATE OIL (FOR ABOVE GROUND USE) AND COPPER NAPTHENATE EMULSION (FOR BELOW GROUND USE) – COAT ENTIRE BOLLARD PRIOR TO PLACING.
- COLOUR SELECTION WHERE APPLICABLE IN ACCORDANCE WITH STANDARD CORPORATE COLOUR PALETTE. COAT ENTIRE BOLLARD PRIOR TO PLACING.

RECYCLED PLASTIC NOTES

- SECTIONS TO BE FORMED FROM A SINGLE, CONTINUOUSLY EXTRUDED PIECE. MATERIAL TO BE UV STABILISED.
- POROSITY TO A MAXIMUM OF 15% OF CROSS SECTION.
- MAXIMUM VOID LENGTH 10% OF LARGEST CROSS SECTION.
- SURFACE FINISH TO BE SMOOTH AND FREE OF ANY MAJOR VOIDS OR VISIBLE DEFECTS.
- SIZE IS INDICATIVE – VARIANCE NOT TO EXCEED APPROXIMATELY 1.5%.
- COLOUR TO BE CHOSEN FROM AVAILABLE SUPPLIER COLOURS, TYPICALLY GREEN, BLACK, GREY OR BLUE.
- MATERIAL TO HAVE FLAMMABILITY TESTING TO AS ISO TO AS/ISO 9239 AND/OR FIRE HAZARD RATING TO AS/NZS 1530.
- DEMONSTRATED CHEMICAL RESISTANCE.

CONCRETE WORK NOTES

- ALL WORKMANSHIP AND MATERIAL SHALL BE IN ACCORDANCE WITH AS 3600.
- AT A MINIMUM ALL CONCRETE TO BE GRADE N25. CONCRETE SHALL BE NORMAL CLASS CONCRETE UNLESS DIRECTED OTHERWISE. N25 SHALL MEAN NORMAL CLASS CONCRETE WITH A 28 DAY CHARACTERISTIC STRENGTH OF 25MPa. CONCRETE MIX DESIGN SHALL BE SUBMITTED TO THE SITE SUPERINTENDENT FOR APPROVAL FIVE (5) DAYS PRIOR TO ORDERING.
- ALL CEMENT TO BE TYPE GP OR GB TO AS 3972 UNLESS SPECIFIED OTHERWISE.
- NORMAL AGGREGATE SIZE TO BE 20mm, SLUMP TO BE NOT GREATER THAN 80mm.
- THE BOTTOMS OF ALL FOOTINGS ARE TO BE CLEANED OF ALL LOOSE MATERIAL AND WATER PRIOR TO PLACING CONCRETE.
- ALL CONCRETE TO BE GRADE N25 BROOM FINISHED 125mm MIN THICKNESS. ALL CONCRETE WORKS TO BE REINFORCED MIN SL72 MESH. ENSURE MIN TOP COVER OF 50mm.


PLUMBING & DRAINAGE WORK NOTES


- IMPORTED PIPES AND FITTINGS ARE NOT TO BE USED UNLESS COMPLIANT UNDER AUSTRALIAN STANDARDS. PVC PLUMBING FITTINGS MUST BE WATERMARK CERTIFIED AUSTRALIAN STANDARDS AND ARE BEST ENVIRONMENTAL PRACTICE PVC.
- A LICENSED PLUMBER IS THE PERSON RESPONSIBLE FOR UNDERTAKING OR SUPERVISING THE WORK AS DEFINED UNDER THE PLUMBING AND DRAINAGE ACT 2002.

FIXTURES/FITTINGS & METAL WORK NOTES

- ALL WORKMANSHIP AND MATERIAL SHALL BE IN ACCORDANCE WITH AS4100 & AS/NZS 1554.
- ALL METAL FINISHES TO BE IN ACCORDANCE WITH AS 4506.
- ALL FIXTURES/FITTINGS UNLESS SPECIFIED ARE TO BE HOT DIPPED GALVANISED UNLESS IN VICINITY OF SALTWATER/SPRAY, ENSURE ALL FASTENERS SHALL BE STAINLESS STEEL. PLASTIC SEPARATORS SHALL BE PROVIDED TO AVOID CONTACT BETWEEN DISSIMILAR MATERIALS.STAINLESS STEEL GRADE 316 TO BE USED. WHERE POSSIBLE ALL FIXINGS TO BE TAMPER/VANDAL PROOF TO MINIMISE DAMAGE OR THEFT.
- ALL WELDS TO BE CONTINUOUS FILLET WELDS, GROUND OFF SMOOTH & FLUSH IN ACCORDANCE WITH AS 1554. GRIND SMOOTH EDGES & WELDS PRIOR TO H.D.G. OR APPLIED FINISHES.

REFER TO BSD–10306
& BSD–10307 FOR
ASSOCIATED DETAILS


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| | | | | | <div>DRAWING AUTHORISED FOR PUBLICATION PAUL COTTON SIGNATURE ON ORIGINAL DATED 03/09/04 MANAGER INFRASTRUCTURE MANAGEMENT R.P.E.O. 2546</div> <div>DESIGN APPROVED LAUREN TEMPLEMAN SIGNATURE ON ORIGINAL DATED 31/08/04</div> <div>PRICIPAL PROGRAM OFFICER PARKS</div> | DESIGN | Std Dwgs WG | DATE | OCT '13 |  | BRISBANE CITY COUNCIL STANDARD DRAWING | | |
| | | | | | | DRAWN | CPO - P&D | DATE | OCT '13 | | SCALE AS SHOWN | | |
| | | | | | | CHECKED | UMD - E&P & IMB | DATE | OCT '13 | | DWG No. BSD-10305 | | |
| A | Drawing Converted From UMS Series April 2014 | APR '14 | APR '14 | APR '14 | | DRAWING FILENAME | BSD-10305 (A) Taps - general notes.dwg | | | | ORIGINAL SIZE A3 | | |
| ISSUE | AMENDMENT | DRAWN DATE | CHK'D DATE | APPR'D DATE | ASSOCIATED PLANS | SUPERSEDES UMS-714 | | | REVISION A | | | | |
| | | | | | | | | | | | TAPS GENERAL NOTES | | |

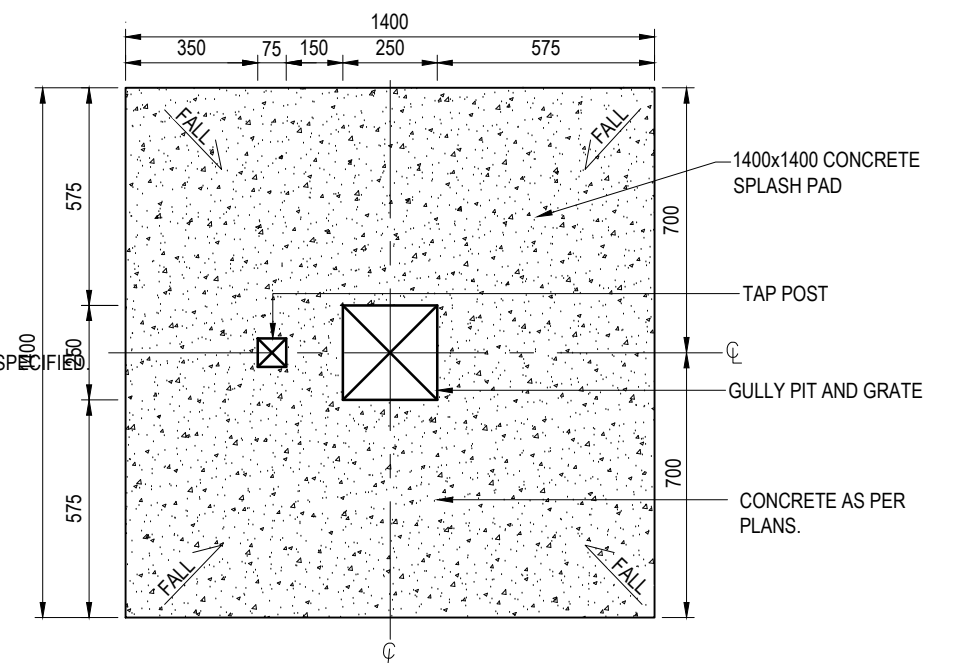


SPLASH PAD - PLAN

SCALE: 1:20


REFER TO BSD-10305 FOR
ADDITIONAL SPECIFICATION
NOTES

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| | | | | | <div>DRAWING AUTHORISED FOR PUBLICATION PAUL COTTON SIGNATURE ON ORIGINAL DATED 03/09/04 MANAGER INFRASTRUCTURE MANAGEMENT R.P.E.Q: 2546</div> | DESIGN | Std Dwgs WG | DATE | OCT '13 |  | BRISBANE CITY COUNCIL STANDARD DRAWING | | |
| | | | | | | DRAWN | CPO - P&D | DATE | OCT '13 | | SCALE AS SHOWN | | |
| | | | | | | CHECKED | UMD - E&P & IMB | DATE | OCT '13 | | DWG No. BSD-10306 | | |
| B | Reference to Superseded Drawing (BSD-10003) Removed from Section Detail | JAN '19 | APR '19 | APR '19 | <div>DESIGN APPROVED LAUREN TEMPLEMAN SIGNATURE ON ORIGINAL DATED 31/08/04</div> | DRAWING FILENAME | BSD-10306 (B) Taps - Water tap and bubbler with dog bowl.dwg | | | | ORIGINAL SIZE | REVISION | |
| A | Drawing Converted From UMS Series April 2014 | APR '14 | APR '14 | APR '14 | | ASSOCIATED PLANS | SUPERSEDES UMS-714 | | | | A3 | B | |
| ISSUE | AMENDMENT | DRAWN DATE | CHK'D DATE | APPR'D DATE | PRICIPAL PROGRAM OFFICER PARKS | | | | | | | | |

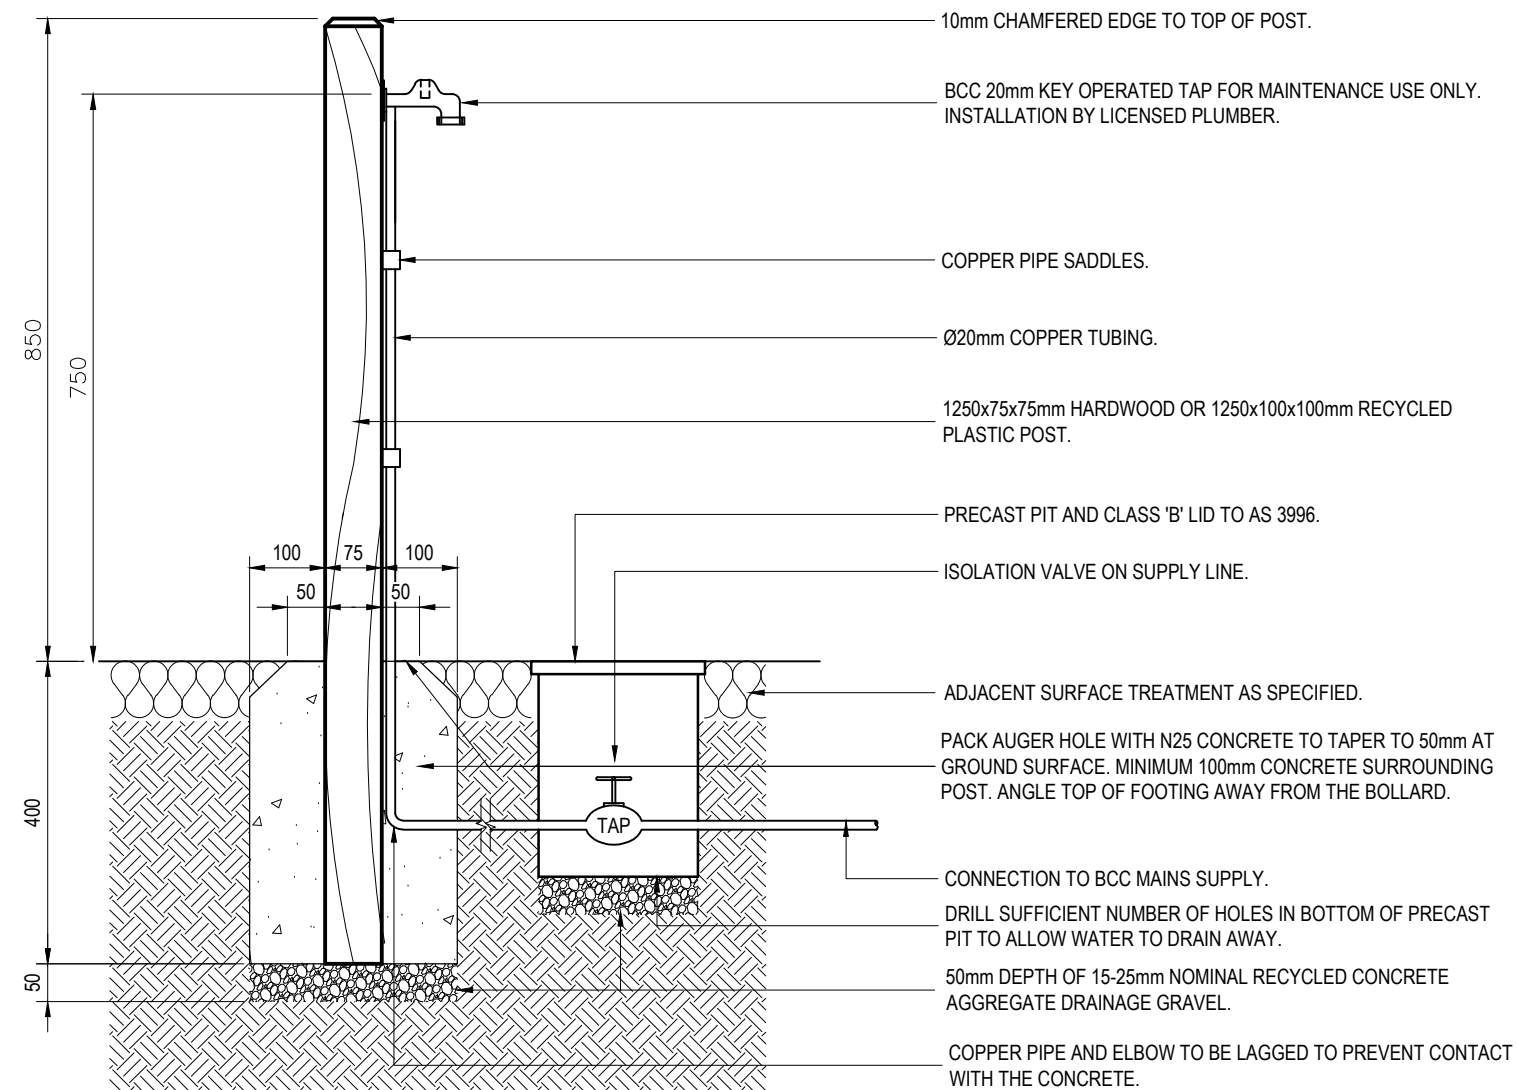

MAINTENANCE TAP - SECTION

REFER TO BSD-10305 FOR
ADDITIONAL SPECIFICATION
NOTES

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|-------|---|------------|------------|-------------|---|------------------|--------------------------------------|------|------------------|---|--|-------------------|--|
| | | | | | <div><div>DRAWING AUTHORISED FOR PUBLICATION</div><div>PAUL COTTON SIGNATURE ON ORIGINAL DATED 03/09/04</div><div>MANAGER INFRASTRUCTURE MANAGEMENT</div><div>R.P.E.Q: 2546</div><div>DESIGN APPROVED</div><div>LAUREN TEMPLEMAN SIGNATURE ON ORIGINAL DATED 31/08/04</div><div></div><div>PRICIPAL PROGRAM OFFICER PARKS</div></div> | DESIGN | Std Dwgs WG | DATE | OCT '13 |  | BRISBANE CITY COUNCIL STANDARD DRAWING | | |
| | | | | | | DRAWN | CPD - P&D | DATE | OCT '13 | | <div>TAPS MAINTENANCE</div> | SCALE 1:10 | |
| | | | | | | CHECKED | UMD - E&P & IMB | DATE | OCT '13 | | | DWG No. BSD-10307 | |
| B | Reference to Superseded Drawing (BSD-10003) Removed from Section Detail | JAN '19 | APR '19 | APR '19 | | DRAWING FILENAME | BSD-10307 (B) Taps - Maintenance.dwg | | ORIGINAL SIZE A3 | | | | |
| A | Drawing Converted From UMS Series April 2014 | APR '14 | APR '14 | APR '14 | | ASSOCIATED PLANS | SUPERSEDES UMS-713 | | REVISION B | | | | |
| ISSUE | AMENDMENT | DRAWN DATE | CHK'D DATE | APPR'D DATE | | | | | | | | | |

GENERAL NOTES:

- G1 THE BUILDER SHALL BE RESPONSIBLE FOR MAINTAINING STABILITY OF THE STRUCTURE UNTIL COMPLETION OF CONSTRUCTION AND SHALL ENSURE THAT NO PART OF THE STRUCTURE IS OVERSTRESSED.
- G2 THE BUILDER SHALL CHECK ALL DIMENSIONS AND ALL EXISTING CONDITIONS BEFORE COMMENCING CONSTRUCTION.
- G3 ANY DAMAGE CAUSED BY THE CONTRACTOR SHALL BE MADE GOOD AT THEIR OWN COST.
- G4 ALL MATERIALS AND WORKMANSHIP SHALL BE IN ACCORDANCE WITH THE CURRENT EDITIONS OF THE FOLLOWING AUSTRALIAN STANDARDS, EXCEPT WHERE VARIED BY THE SPECIFICATIONS AND/OR DRAWINGS: –
AS 1684.2(2010) RESIDENTIAL TIMBER FRAMED CONSTRUCTION
AS 1720.1(2010) TIMBER STRUCTURES
AS 2870(2011) RESIDENTIAL SLABS AND FOOTINGS
AS 3600 CONCRETE STRUCTURES
AS 3798 GUIDELINES ON EARTHWORKS FOR COMMERCIAL AND RESIDENTIAL DEVELOPMENTS
AS 4100 STEEL STRUCTURES
- G5 DIMENSIONS SHALL NOT BE OBTAINED BY SCALING THE STRUCTURAL DRAWINGS.
- G6 ALL DIMENSIONS ARE IN MILLIMETRES UNLESS NOTED OTHERWISE (U.N.O.)
- G7 U.N.O. DENOTES UNLESS NOTED OTHERWISE.
- G8 THE CONTRACTOR SHALL VISIT THE SITE PRIOR TO TENDERING TO FAMILIARISE THEMSELVES WITH ACCESS SITE CONDITIONS
- G9 THE CONTRACTOR MAY OFFER FOR CONSIDERATION ALTERNATIVE PROVEN EQUAL PRODUCTS TO THOSE INDICATED. ALTERNATIVE PRODUCTS ARE NOT TO ADVERSELY AFFECT THE PROJECT AND CANNOT BE SUBSTITUTED WITHOUT PRIOR APPROVAL.
- G10 EXISTING SERVICES TO BE LOCATED BEFORE CONSTRUCTION COMMENCES.
- G11 THE DETAILS OF BUSHFIRE WATER SUPPLY SHELTER INCLUDED IN DRAWING SHEETS 1 TO 3.
- G12 CONSULT BCC ARCHITECTS FOR COLOUR SCHEME OF THE STRUCTURE.

DESIGN CRITERIA:

WIND LOADS : REGION B TERRAIN CATEGORY 2.5
ULTIMATE DESIGN WIND SPEED = 54.0 m/s
DESIGN LIFE : 50 YEARS WITH ROUTINE MAINTENANCE
LIVE LOADS: : FLOOR = 5.0 kPa. ROOF = 0.25 kPa / 1.4 kN.

STRUCTURE IS DESIGNED TO REMAIN OPEN – NO
SCREENS(IMPERMEABLE OR PERMEABLE BARRIERS) TO BE INSTALLED.

FOUNDATIONS AND SLAB ON GROUND:

- F1 ALL FOOTINGS ARE TO BE FOUNDED IN THE NATURAL UNDISTURBED SOIL PROFILE WITH A MINIMUM ALLOWABLE SOIL BEARING CAPACITY OF 100kPa UNLESS NOTED OTHERWISE. IF THE SITE CONDITION IS DIFFERENT, CONSULT A STRUCTURAL ENGINEER.
- F2 SOIL TEST IS REQUIRED TO CONFIRM BEARING CAPACITY AND SITE CLASSIFICATION TO AS 2870.
- F3 FOUNDATIONS ARE TO BE CHECKED AND CERTIFIED BY A REGISTERED PROFESSIONAL GEOTECHNICAL ENGINEER, QUEENSLAND (RPEQ).
- F4 COMPACT AND PREPARE THE BASE TO PROVIDE A SOUND PLATFORM AND ANY ORGANIC, SOFT OR LOOSE MATERIALS REMOVED AND REPLACED WITH COMPACTED FILL – BCC SPECIFICATION S300 QUARRY PRODUCT CLASS 1 MATERIAL.
- F5 FOR CONTROL JOINT LOCATIONS, REFER TO DRAWINGS.
- F6 SLABS ON GROUND SHALL BE UNDERLAIN WITH CONTINUOUS LAYER OF 200 MICRON (0.2mm) THICK POLYETHYLENE DAMPPROOF MEMBRANE AS PER AS 2870, LAPPED AND TAPED TO MANUFACTURER’S SPECIFICATION.

EARTHWORKS:

- E1 STRIP ALL HUMUS MATERIAL FROM THE AREA OF THE BUILDING IMPRINT AND 1000 BEYOND.
- E2 PROOF ROLL THE AREAS TO BE CONCRETED AND PAVED. REMOVE ANY WEAK MATERIAL.
- E3 COMPACTED FILL SHALL BE COMPACTED IN LAYERS NOT EXCEEDING 150mm LOOSE DEPTH TO 98% MAXIMUM DRY DENSITY IN ACCORDANCE WITH AS1289. 5.1.1 (STANDARD COMPACTION). CARRY OUT DENSITY TESTS AT A RATE OF 2 PER LAYER OF FILL. EVERY TEST MUST PASS.

TIMBER NOTES:

- T1 ALL WORKMANSHIP AND MATERIAL SHALL BE IN ACCORDANCE WITH AS 1720 AND AS 1684.
- T2 TIMBER GRADES SHALL BE AS SHOWN ON THE DRAWINGS. ALL TIMBER TO BE SEASONED OR KILN DRIED GRADE MGP12 MINIMUM U.N.O WITH NATURAL DURABILITY CLASS 4 (ABOVE GROUND) OR BETTER.
- T3 ALL FASTENERS SHALL BE HOT DIP GALVANISED. BOLTS TO BE METRIC HEX-HEAD M16 MINIMUM WITH WASHERS U.N.O. CLEAT PLATES TO BE 10mm THICK U.N.O.
- T4 TIMBER JOINT GROUP JD4 OR BETTER.
- T5 ALL TIMBER SHALL BE FULLY DRESSED AND ALL EDGES, ENDS AND CORNERS TO BE 6mm DRESSED.
- T6 PROTECT ENDS OF EXPOSED MEMBERS. USE A HIGH QUALITY EXTERIOR PAINT FINISH.
- T7 ALL TIMBER FRAMING SHALL BE NATURALLY TERMITE RESISTANT OR TREATED USING LOSP OR ACQ CHEMICALS TO A HAZARD RESISTANCE LEVEL H3 IN ACCORDANCE WITH AS 1684.2 APPENDIX B.
- T8 ALL TIMBER TO BE STAINED OR PAINTED PRIOR TO FIXING INTO FINAL POSITION. REFER TO PROJECT SPECIFICATION FOR EACH PROJECT.

CONCRETE NOTES:

- C1 ALL WORKMANSHIP AND MATERIAL SHALL BE IN ACCORDANCE WITH AS 3600.
- C2 ALL CONCRETE SHALL BE PREMIXED BY AN APPROVED SUPPLIER.
- C3 ALL CEMENT SHALL BE TYPE GP OR GB.
- C4 CONCRETE SPECIFICATION: NOMINAL AGGREGATE SIZE TO BE 20mm, SLUMP TO BE NOT GREATER THAN 80mm.
- C5 CONCRETE STRENGTH AND CLEAR CONCRETE COVER TO REINFORCEMENT SHALL BE IN ACCORDANCE WITH THE FOLLOWING TABLE U.N.O
- | ELEMENT: | F’C (MPa) | REINFORCEMENT COVER |
|----------|-----------|---------------------|
| PIERS | 25 | 75 MIN. |
| SLAB | 25 | 50 MIN. |
- C6 ALL LAPS IN REINFORCEMENT SHALL BE AS SHOWN IN THE TABLE BELOW UNLESS NOTED OTHERWISE.
- | BAR | LAP LENGTH (mm) |
|------|-----------------|
| N12 | 500 |
| N16 | 650 |
| MESH | 350 |
- C7 REINFORCEMENT SYMBOLS:
- R STRUCTURAL PLAIN ROUND GRADE 250R TO AS 4671.
- N DEFORMED BAR GRADE D500N TO AS 4671.
- SL HARD DRAWN STEEL REINFORCING FABRIC GRADE D500L TO AS 4671.
- C8 SIZES OF CONCRETE ELEMENTS DO NOT INCLUDE THICKNESS OF APPLIED FINISHES.
- C9 NO HOLES, CHASES OR EMBEDMENT OF PIPES OTHER THAN THOSE SHOWN ON THE STRUCTURAL DRAWINGS SHALL BE MADE IN CONCRETE MEMBERS WITHOUT PRIOR APPROVAL BY THE SUPERINTENDENT.
- C10 ALL CONCRETE SHALL BE COMPACTED USING A MECHANICAL VIBRATION PROCESS.
- C11 ALL REINFORCEMENT SHALL BE SECURELY SUPPORTED IN ITS CORRECT POSITION DURING CONCRETING BY APPROVED BAR CHAIRS, SPACERS OR SUPPORT BARS.
- C12 CONSTRUCTION JOINTS SHALL BE PROPERLY FORMED AND USED ONLY WHERE SHOWN OR SPECIFICALLY APPROVED BY THE SUPERINTENDENT.

INSPECTION AND CERTIFICATION NOTES:

- A1 THE CONTRACTOR’S ENGINEER (RPEQ) SHALL UNDERTAKE INSPECTIONS DURING CONSTRUCTION TO ENSURE ALL CONSTRUCTION WORKS ARE IN ACCORDANCE WITH THE MOST CURRENT ISSUE OF THE STRUCTURAL DRAWINGS AND CONTRACT DOCUMENTS. THE RPEQ SHALL CERTIFY ALL CONSTRUCTION WORK (FORM 16). ANY ALTERNATIVE TECHNIQUE USED IN CONSTRUCTION SHALL BE FOLLOWED BY A DESIGN CERTIFICATE (FORM 15) BY THE CONTRACTOR’S PROFESSIONAL ENGINEER (RPEQ)


STEELWORK NOTES


- S1. ALL WORKMANSHIP & MATERIALS SHALL BE IN ACCORDANCE WITH AS4100 & AS/NZS1554.
- S2. ALL STEEL SHALL BE IN ACCORDANCE WITH:
AS1163 GRADE C350LO FOR RECTANGULAR AND SQUARE HOLLOW SECTIONS U.N.O.
- S3. AS 3679 GRADE 300 FOR HOT ROLLED SECTIONS.
- S3. ALL BOLTS TO BE METRIC HEXAGONAL TO AS 1252 U.N.O.
ALL BOLTS TO BE M16 4.6/S TO AS/NZS 1252 U.N.O.
ALL BOLTS TO BE HOT DIP GALVANISED TO AS 1214 U.N.O.
- S4. ALL CLEATS AND GUSSETS SHALL BE 10mm PLATE TO AS/NZS3678 GRADE 250 U.N.O.
- S5. METAL ROOF CLADDING TO BE 0.42 BMT LYSAGHT CUSTOM ORB WITH A COLORBOND FINISH OR APPROVED EQUAL FIXED AS PER MANUFACTURER’S SPECIFICATIONS – COLORBOND COLOUR AS PER SPECIFICATION.
- S6. ALL WELDS TO BE 6mm CONTINUOUS FILLET WELDS (CFW) STRUCTURAL PURPOSE (SP) WELDS U.N.O. ALL WELDS TO BE MADE USING E48XX OR W50X GRADE 1 (OR BETTER) ELECTRODES TO AS/NZS 1554. GRIND ALL CORNERS & WELDS SMOOTH.
- S7. ALL STEELWORK TO BE HOT DIP GALVANISED IN ACCORDANCE WITH AS/NZS 2312 HDG600 SPECIFICATION. SURFACE PREPARATION FOR CORROSION PROTECTION COATING IS TO BE CLASS 2½ TO AS 1627 AND PICKLED PRIOR GALVANISING. HOT DIPPED GALVANISED COATING SHALL BE IN ACCORDANCE WITH AS/NZS 4680.
- S8. THE PRINCIPAL CONTRACTOR SHALL CONFER WITH THE FABRICATOR AND GALVANISER TO ENSURE VENT HOLES ARE PROVIDED IN ACCORDANCE WITH AS/NZS 4680.
- S9. ANY POST GALVANISING DAMAGE TO BE MADE GOOD WITH HIGH QUALITY TWO PACK EPOXY ZINC RICH PAINT CONFORMING TO AS/NZS 3750.9 WITH A MINIMUM DRY FILM THICKNESS OF 100 MICRONS. SURFACE PREPARATION TO BE ACCORDING TO PAINT MANUFACTURER’S RECOMMENDATIONS.
- S10. THE ENDS OF ALL TUBULAR OR HOLLOW MEMBERS ARE TO BE SEALED WITH 6mm THICK PLATES AND CONTINUOUS FILLET WELDED U.N.O.
- S11. PROTECTIVE COATINGS TO BE APPLIED AFTER ALL FABRICATION COMPLETED. NO WELDING ETC TO BE CARRIED OUT DURING OR AFTER APPLICATION OF COATING SYSTEM.

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| STRUCTURAL DESIGN CERTIFICATION | | | | | | | | | |
| DESIGN | | Lenita Mendis RPEQ:8950 2014.12.10 16:32:39 +10'00' | | DESIGN CHECK | | R.Hu (RPEQ No 13885) | | AUTHORISED FOR ISSUE | |
| | | | | | | | | | |
| BRISBANE CITY COUNCIL STANDARD DRAWING | | | | | | | | | |
| BUSHFIRE WATER SUPPLY SHELTER TYPE 1 – NATURAL AREA – SHEET 1 OF 3 – NOTES | | | | | | | | SCALE AS SHOWN | |
| | | | | | | | | DWG No. BSD–10351 | |
| | | | | | | | | ORIGINAL SIZE A3 | |
| | | | | | | | | REVISION A | |

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| DRAWING AUTHORISED FOR PUBLICATION | | | | | DESIGN | | CPO – P&D | | DATE | | DEC '14 | |
| ASSET ENGINEERING MANAGER STRATEGIC ASSET MANAGEMENT | | | | | DRAWN | | CPO – P&D | | DATE | | DEC '14 | |
| DESIGN APPROVED | | | | | CHECKED | | BI - FSG - AS | | DATE | | DEC '14 | |
| L. Wood | | | | | DRAWING FILENAME | | BSD-10351-Sheet 1 of 3.dwg | | | | | |
| SENIOR CO-ORDINATOR NATURAL ENVIRONMENT ASSET SERVICES/BRISBANE INFRASTRUCTURE | | | | | ASSOCIATED PLANS | | BSD-10351-Sheets 2 & 3 | | | | | |


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| A | | ORIGINAL ISSUE | | DEC '14 | | DEC '14 | | DEC '14 | |
| ISSUE | | AMENDMENT | | DRAWN DATE | | CHK'D DATE | | APPR'D DATE | |



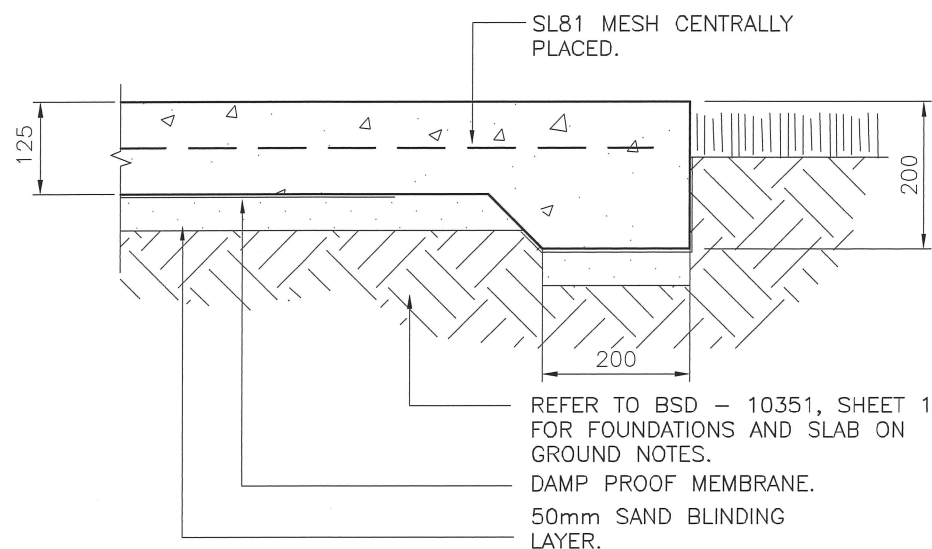

TYPICAL SLAB EDGE THICKENING DETAIL

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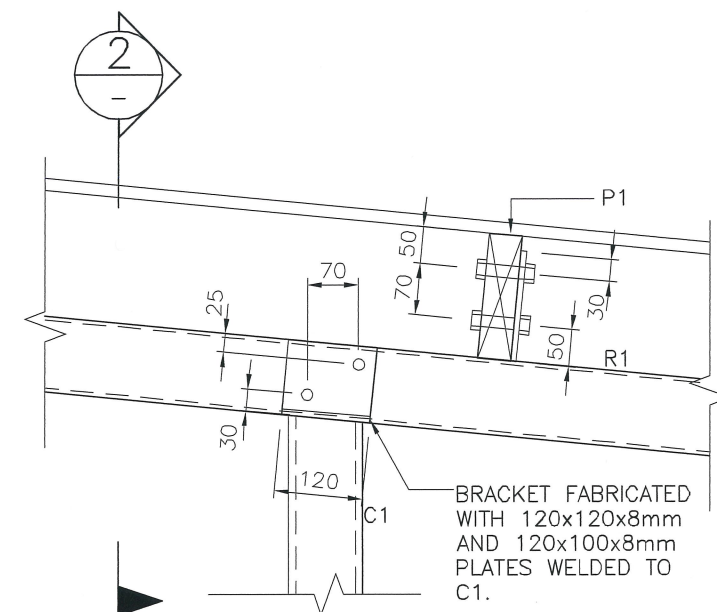


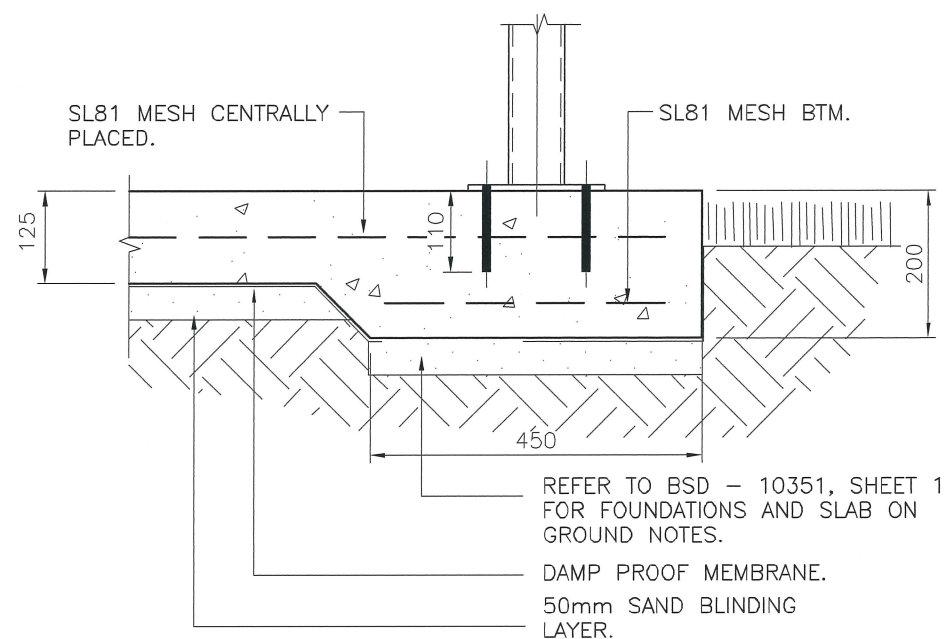SLAB EDGE THICKENING DETAIL WHERE SEAT IS TO BE INSTALLED ON CONCRETE SLAB

SECTION 3

SCALE 1:10


SH 2



DETAIL 1


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SH 2

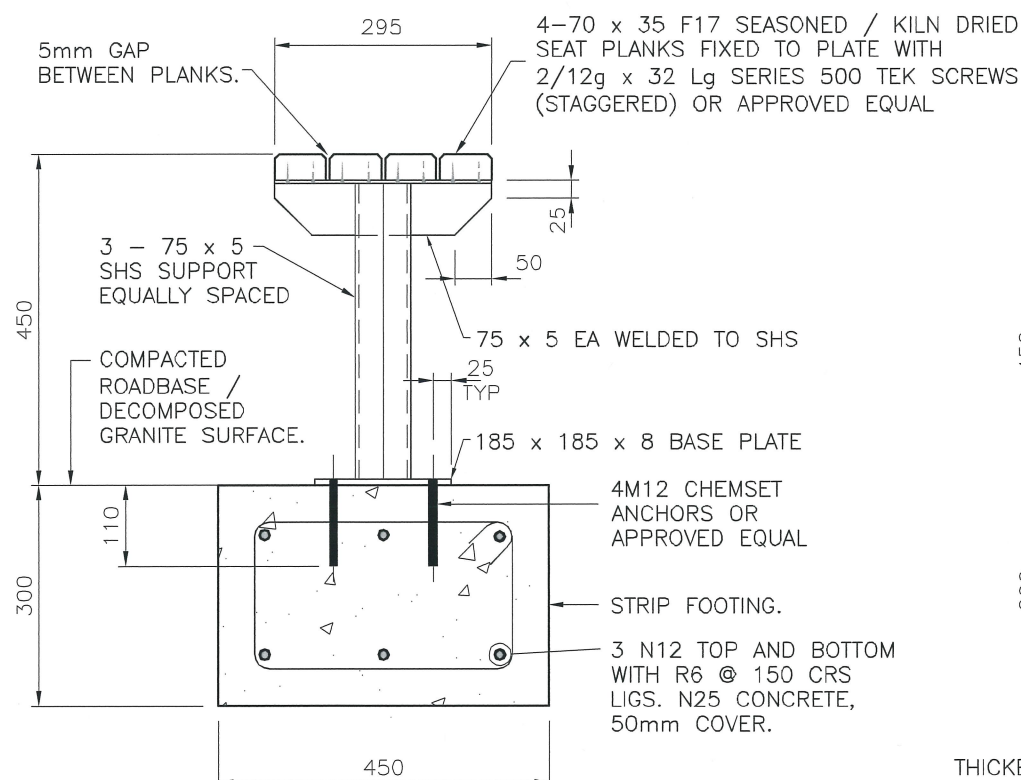


SEATING WHERE ON COMPACTED ROADBASE/DECOMPOSED GRANITE

SCALE: 1:10

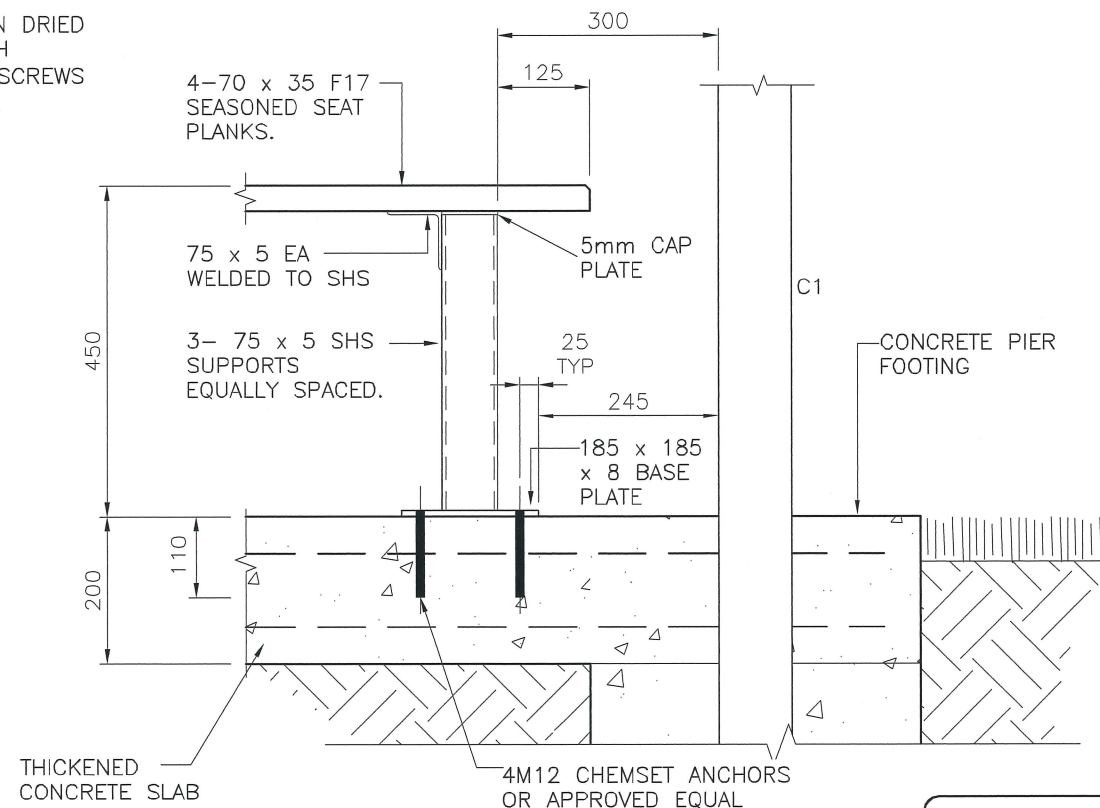

SEATING ON CONCRETE SLAB

SCALE: 1:10

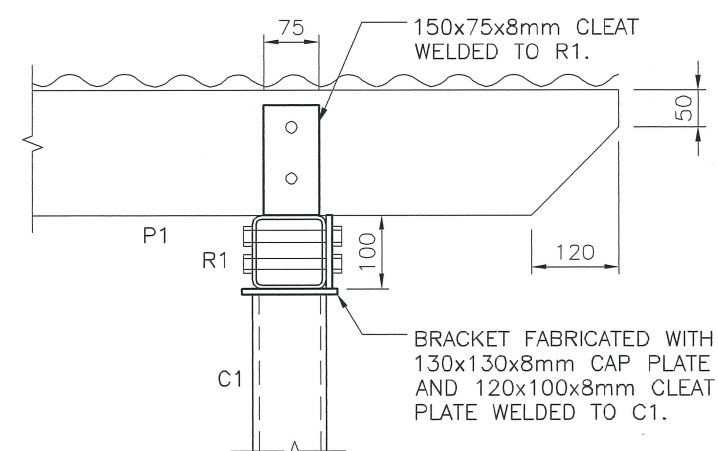

SECTION 2

SCALE 1:10

SH 2

STRUCTURAL DESIGN CERTIFICATION

| | | | | | |
|--------|--|--------------|----------------------|----------------------|--|
| DESIGN | Lenita Mendis RPEQ:8950 2014.12.10 16:33:44 +10'00' | DESIGN CHECK | R.Hu (RPEQ No 13885) | AUTHORISED FOR ISSUE | Bala Balakumar, RPEQ:3963 2014.12.11 09:01:17 +10'00' |
|--------|--|--------------|----------------------|----------------------|--|

BRISBANE CITY COUNCIL STANDARD DRAWING

| | | | |
|--|--|--|----------------------|
| BUSHFIRE WATER SUPPLY SHELTER TYPE 1 - NATURAL AREA - SHEET 3 OF 3 - DETAILS | | | SCALE AS SHOWN |
| | | | DWG No. BSD-10351 |
| | | | ORIGINAL SIZE A3 |
| | | | REVISION A |

| ISSUE | AMENDMENT | DRAWN DATE | CHK'D DATE | APPR'D DATE |
|-------|----------------|---------------|---------------|----------------|
| A | ORIGINAL ISSUE | DEC '14 | DEC '14 | DEC '14 |

DRAWING AUTHORISED FOR PUBLICATION

ASSET ENGINEERING MANAGER
STRATEGIC ASSET MANAGEMENT
DESIGN APPROVED

SENIOR CO-ORDINATOR NATURAL ENVIRONMENT
ASSET SERVICES/BRISBANE INFRASTRUCTURE

| | | | |
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| DESIGN | CPO - P&D | DATE | DEC '14 |
| DRAWN | CPO - P&D | DATE | DEC '14 |
| CHECKED | BI - FSG - AS | DATE | DEC '14 |
| DRAWING FILENAME | BSD-10351-Sheet 3 of 3.dwg | | |
| ASSOCIATED PLANS | BSD-10351-Sheets 1 & 2 | | |



GENERAL NOTES:

- G1 THE BUILDER SHALL BE RESPONSIBLE FOR MAINTAINING STABILITY OF THE STRUCTURE UNTIL COMPLETION OF CONSTRUCTION AND SHALL ENSURE THAT NO PART OF THE STRUCTURE IS OVERSTRESSED.
- G2 THE BUILDER SHALL CHECK ALL DIMENSIONS AND ALL EXISTING CONDITIONS BEFORE COMMENCING CONSTRUCTION.
- G3 ANY DAMAGE CAUSED BY THE CONTRACTOR SHALL BE MADE GOOD AT THEIR OWN COST.
- G4 ALL MATERIALS AND WORKMANSHIP SHALL BE IN ACCORDANCE WITH THE CURRENT EDITIONS OF THE FOLLOWING AUSTRALIAN STANDARDS, EXCEPT WHERE VARIED BY THE SPECIFICATIONS AND/OR DRAWINGS: –
AS 1684.2(2010) RESIDENTIAL TIMBER FRAMED CONSTRUCTION
AS 1720.1(2010) TIMBER STRUCTURES
AS 2870(2011) RESIDENTIAL SLABS AND FOOTINGS
AS 3600 CONCRETE STRUCTURES
AS 3798 GUIDELINES ON EARTHWORKS FOR COMMERCIAL AND RESIDENTIAL DEVELOPMENTS
AS 4100 STEEL STRUCTURES
- G5 DIMENSIONS SHALL NOT BE OBTAINED BY SCALING THE STRUCTURAL DRAWINGS.
- G6 ALL DIMENSIONS ARE IN MILLIMETRES UNLESS NOTED OTHERWISE (U.N.O.)
- G7 U.N.O. DENOTES UNLESS NOTED OTHERWISE.
- G8 THE CONTRACTOR SHALL VISIT THE SITE PRIOR TO TENDERING TO FAMILIARISE THEMSELVES WITH ACCESS SITE CONDITIONS
- G9 THE CONTRACTOR MAY OFFER FOR CONSIDERATION ALTERNATIVE PROVEN EQUAL PRODUCTS TO THOSE INDICATED. ALTERNATIVE PRODUCTS ARE NOT TO ADVERSELY AFFECT THE PROJECT AND CANNOT BE SUBSTITUTED WITHOUT PRIOR APPROVAL.
- G10 EXISTING SERVICES TO BE LOCATED BEFORE CONSTRUCTION COMMENCES.
- G11 THE DETAILS OF BUSHFIRE WATER SUPPLY SHELTER INCLUDED IN DRAWING SHEETS 1 TO 3.
- G12 CONSULT BCC ARCHITECTS FOR COLOUR SCHEME OF THE STRUCTURE.

DESIGN CRITERIA:

WIND LOADS : REGION B TERRAIN CATEGORY 2.5
ULTIMATE DESIGN WIND SPEED = 54.0 m/s
DESIGN LIFE : 50 YEARS WITH ROUTINE MAINTENANCE
LIVE LOADS: : FLOOR = 5.0 kPa. ROOF = 0.25 kPa / 1.4 kN.

STRUCTURE IS DESIGNED TO REMAIN OPEN – NO
SCREENS(IMPERMEABLE OR PERMEABLE BARRIERS) TO BE INSTALLED.

FOUNDATIONS AND SLAB ON GROUND:

- F1 ALL FOOTINGS ARE TO BE FOUNDED IN THE NATURAL UNDISTURBED SOIL PROFILE WITH A MINIMUM ALLOWABLE SOIL BEARING CAPACITY OF 100kPa UNLESS NOTED OTHERWISE. IF THE SITE CONDITION IS DIFFERENT, CONSULT A STRUCTURAL ENGINEER.
- F2 SOIL TEST IS REQUIRED TO CONFIRM BEARING CAPACITY AND SITE CLASSIFICATION TO AS 2870.
- F3 FOUNDATIONS ARE TO BE CHECKED AND CERTIFIED BY A REGISTERED PROFESSIONAL GEOTECHNICAL ENGINEER, QUEENSLAND (RPEQ).
- F4 COMPACT AND PREPARE THE BASE TO PROVIDE A SOUND PLATFORM AND ANY ORGANIC, SOFT OR LOOSE MATERIALS REMOVED AND REPLACED WITH COMPACTED FILL – BCC SPECIFICATION S300 QUARRY PRODUCT CLASS 1 MATERIAL.
- F5 FOR CONTROL JOINT LOCATIONS, REFER TO DRAWINGS.
- F6 SLABS ON GROUND SHALL BE UNDERLAIN WITH CONTINUOUS LAYER OF 200 MICRON (0.2mm) THICK POLYETHYLENE DAMPPROOF MEMBRANE AS PER AS 2870, LAPPED AND TAPED TO MANUFACTURER’S SPECIFICATION.

EARTHWORKS:

- E1 STRIP ALL HUMUS MATERIAL FROM THE AREA OF THE BUILDING IMPRINT AND 1000 BEYOND.
- E2 PROOF ROLL THE AREAS TO BE CONCRETED AND PAVED. REMOVE ANY WEAK MATERIAL.
- E3 COMPACTED FILL SHALL BE COMPACTED IN LAYERS NOT EXCEEDING 150mm LOOSE DEPTH TO 98% MAXIMUM DRY DENSITY IN ACCORDANCE WITH AS1289. 5.1.1 (STANDARD COMPACTION). CARRY OUT DENSITY TESTS AT A RATE OF 2 PER LAYER OF FILL. EVERY TEST MUST PASS.

TIMBER NOTES:

- T1 ALL WORKMANSHIP AND MATERIAL SHALL BE IN ACCORDANCE WITH AS 1720 AND AS 1684.
- T2 TIMBER GRADES SHALL BE AS SHOWN ON THE DRAWINGS. ALL TIMBER TO BE SEASONED OR KILN DRIED GRADE MGP12 MINIMUM U.N.O WITH NATURAL DURABILITY CLASS 4 (ABOVE GROUND) OR BETTER.
- T3 ALL FASTENERS SHALL BE HOT DIP GALVANISED. BOLTS TO BE METRIC HEX–HEAD M16 MINIMUM WITH WASHERS U.N.O. CLEAT PLATES TO BE 10mm THICK U.N.O.
- T4 TIMBER JOINT GROUP JD4 OR BETTER.
- T5 ALL TIMBER SHALL BE FULLY DRESSED AND ALL EDGES, ENDS AND CORNERS TO BE 6mm DRESSED.
- T6 PROTECT ENDS OF EXPOSED MEMBERS. USE A HIGH QUALITY EXTERIOR PAINT FINISH.
- T7 ALL TIMBER FRAMING SHALL BE NATURALLY TERMITE RESISTANT OR TREATED USING LOSP OR ACQ CHEMICALS TO A HAZARD RESISTANCE LEVEL H3 IN ACCORDANCE WITH AS 1684.2 APPENDIX B.
- T8 ALL TIMBER TO BE STAINED OR PAINTED PRIOR TO FIXING INTO FINAL POSITION. REFER TO PROJECT SPECIFICATION FOR EACH PROJECT.

CONCRETE NOTES:

- C1 ALL WORKMANSHIP AND MATERIAL SHALL BE IN ACCORDANCE WITH AS 3600.
- C2 ALL CONCRETE SHALL BE PREMIXED BY AN APPROVED SUPPLIER.
- C3 ALL CEMENT SHALL BE TYPE GP OR GB.
- C4 CONCRETE SPECIFICATION: NOMINAL AGGREGATE SIZE TO BE 20mm, SLUMP TO BE NOT GREATER THAN 80mm.
- C5 CONCRETE STRENGTH AND CLEAR CONCRETE COVER TO REINFORCEMENT SHALL BE IN ACCORDANCE WITH THE FOLLOWING TABLE U.N.O
- | | | | |
|--|----------|-----------|---------------------|
| | ELEMENT: | F’C (MPa) | REINFORCEMENT COVER |
| | PIERS | 25 | 75 MIN. |
| | SLAB | 25 | 50 MIN. |
- C6 ALL LAPS IN REINFORCEMENT SHALL BE AS SHOWN IN THE TABLE BELOW UNLESS NOTED OTHERWISE.
- | | | |
|--|------|-----------------|
| | BAR | LAP LENGTH (mm) |
| | N12 | 500 |
| | N16 | 650 |
| | MESH | 350 |
- C7 REINFORCEMENT SYMBOLS:
- R STRUCTURAL PLAIN ROUND GRADE 250R TO AS 4671.
- N DEFORMED BAR GRADE D500N TO AS 4671.
- SL HARD DRAWN STEEL REINFORCING FABRIC GRADE D500L TO AS 4671.
- C8 SIZES OF CONCRETE ELEMENTS DO NOT INCLUDE THICKNESS OF APPLIED FINISHES.
- C9 NO HOLES, CHASES OR EMBEDMENT OF PIPES OTHER THAN THOSE SHOWN ON THE STRUCTURAL DRAWINGS SHALL BE MADE IN CONCRETE MEMBERS WITHOUT PRIOR APPROVAL BY THE SUPERINTENDENT.
- C10 ALL CONCRETE SHALL BE COMPACTED USING A MECHANICAL VIBRATION PROCESS.
- C11 ALL REINFORCEMENT SHALL BE SECURELY SUPPORTED IN ITS CORRECT POSITION DURING CONCRETING BY APPROVED BAR CHAIRS, SPACERS OR SUPPORT BARS.
- C12 CONSTRUCTION JOINTS SHALL BE PROPERLY FORMED AND USED ONLY WHERE SHOWN OR SPECIFICALLY APPROVED BY THE SUPERINTENDENT.

INSPECTION AND CERTIFICATION NOTES:

- A1 THE CONTRACTOR’S ENGINEER (RPEQ) SHALL UNDERTAKE INSPECTIONS DURING CONSTRUCTION TO ENSURE ALL CONSTRUCTION WORKS ARE IN ACCORDANCE WITH THE MOST CURRENT ISSUE OF THE STRUCTURAL DRAWINGS AND CONTRACT DOCUMENTS. THE RPEQ SHALL CERTIFY ALL CONSTRUCTION WORK (FORM 16). ANY ALTERNATIVE TECHNIQUE USED IN CONSTRUCTION SHALL BE FOLLOWED BY A DESIGN CERTIFICATE (FORM 15) BY THE CONTRACTOR’S PROFESSIONAL ENGINEER (RPEQ)

STEELWORK NOTES


- S1. ALL WORKMANSHIP & MATERIALS SHALL BE IN ACCORDANCE WITH AS4100 & AS/NZS1554.
- S2. ALL STEEL SHALL BE IN ACCORDANCE WITH:
AS1163 GRADE C350LO FOR RECTANGULAR AND SQUARE HOLLOW SECTIONS U.N.O.
AS 3679 GRADE 300 FOR HOT ROLLED SECTIONS.
- S3. ALL BOLTS TO BE METRIC HEXAGONAL TO AS 1252 U.N.O.
ALL BOLTS TO BE M16 4.6/S TO AS/NZS 1252 U.N.O.
ALL BOLTS TO BE HOT DIP GALVANISED TO AS 1214 U.N.O.
- S4. ALL CLEATS AND GUSSETS SHALL BE 10mm PLATE TO AS/NZS3678 GRADE 250 U.N.O.
- S5. METAL ROOF CLADDING TO BE 0.42 BMT LYSAGHT CUSTOM ORB WITH A COLORBOND FINISH OR APPROVED EQUAL FIXED AS PER MANUFACTURER’S SPECIFICATIONS – COLORBOND COLOUR AS PER SPECIFICATION.
- S6. ALL WELDS TO BE 6mm CONTINUOUS FILLET WELDS (CFW) STRUCTURAL PURPOSE (SP) WELDS U.N.O. ALL WELDS TO BE MADE USING E48XX OR W50X GRADE 1 (OR BETTER) ELECTRODES TO AS/NZS 1554. GRIND ALL CORNERS & WELDS SMOOTH.
- S7. ALL STEELWORK TO BE HOT DIP GALVANISED IN ACCORDANCE WITH AS/NZS 2312 HDG600 SPECIFICATION. SURFACE PREPARATION FOR CORROSION PROTECTION COATING IS TO BE CLASS 2½ TO AS 1627 AND PICKLED PRIOR GALVANISING. HOT DIPPED GALVANISED COATING SHALL BE IN ACCORDANCE WITH AS/NZS 4680.
- S8. THE PRINCIPAL CONTRACTOR SHALL CONFER WITH THE FABRICATOR AND GALVANISER TO ENSURE VENT HOLES ARE PROVIDED IN ACCORDANCE WITH AS/NZS 4680.
- S9. ANY POST GALVANISING DAMAGE TO BE MADE GOOD WITH HIGH QUALITY TWO PACK EPOXY ZINC RICH PAINT CONFORMING TO AS/NZS 3750.9 WITH A MINIMUM DRY FILM THICKNESS OF 100 MICRONS. SURFACE PREPARATION TO BE ACCORDING TO PAINT MANUFACTURER’S RECOMMENDATIONS.
- S10. THE ENDS OF ALL TUBULAR OR HOLLOW MEMBERS ARE TO BE SEALED WITH 6mm THICK PLATES AND CONTINUOUS FILLET WELDED U.N.O.
- S11. PROTECTIVE COATINGS TO BE APPLIED AFTER ALL FABRICATION COMPLETED. NO WELDING ETC TO BE CARRIED OUT DURING OR AFTER APPLICATION OF COATING SYSTEM.

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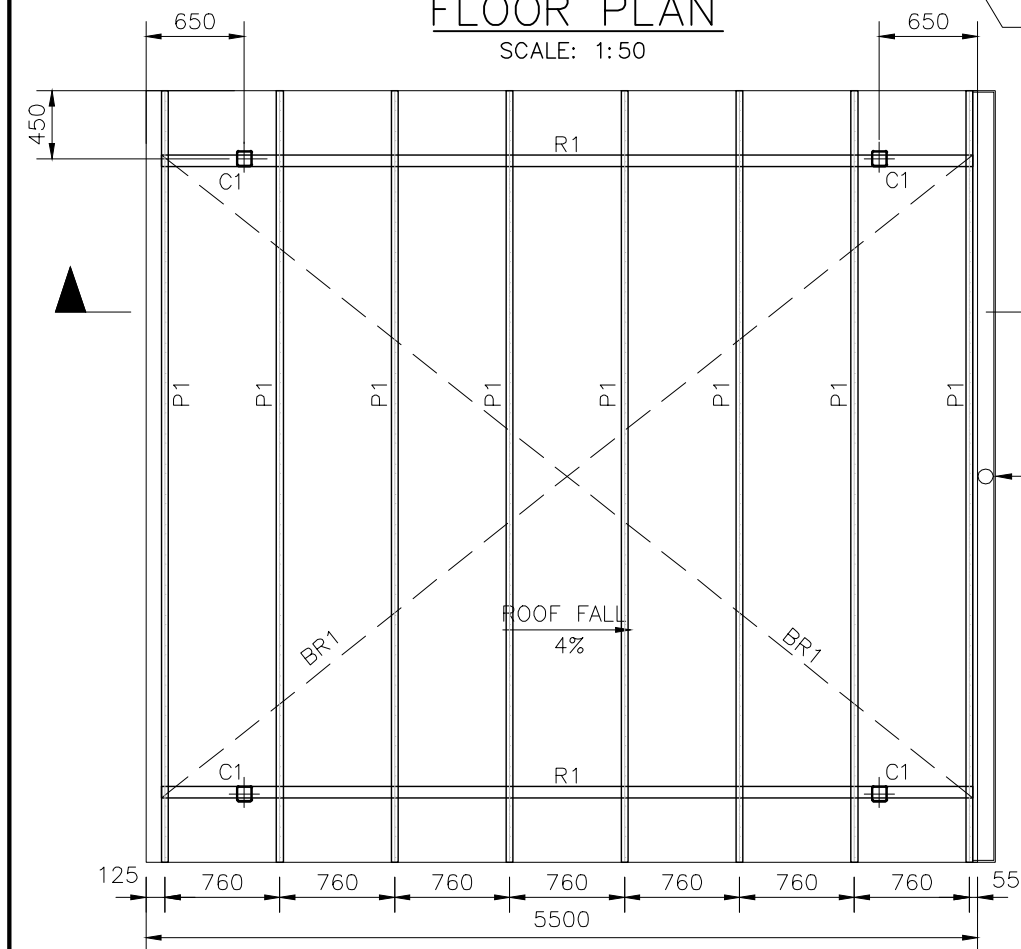
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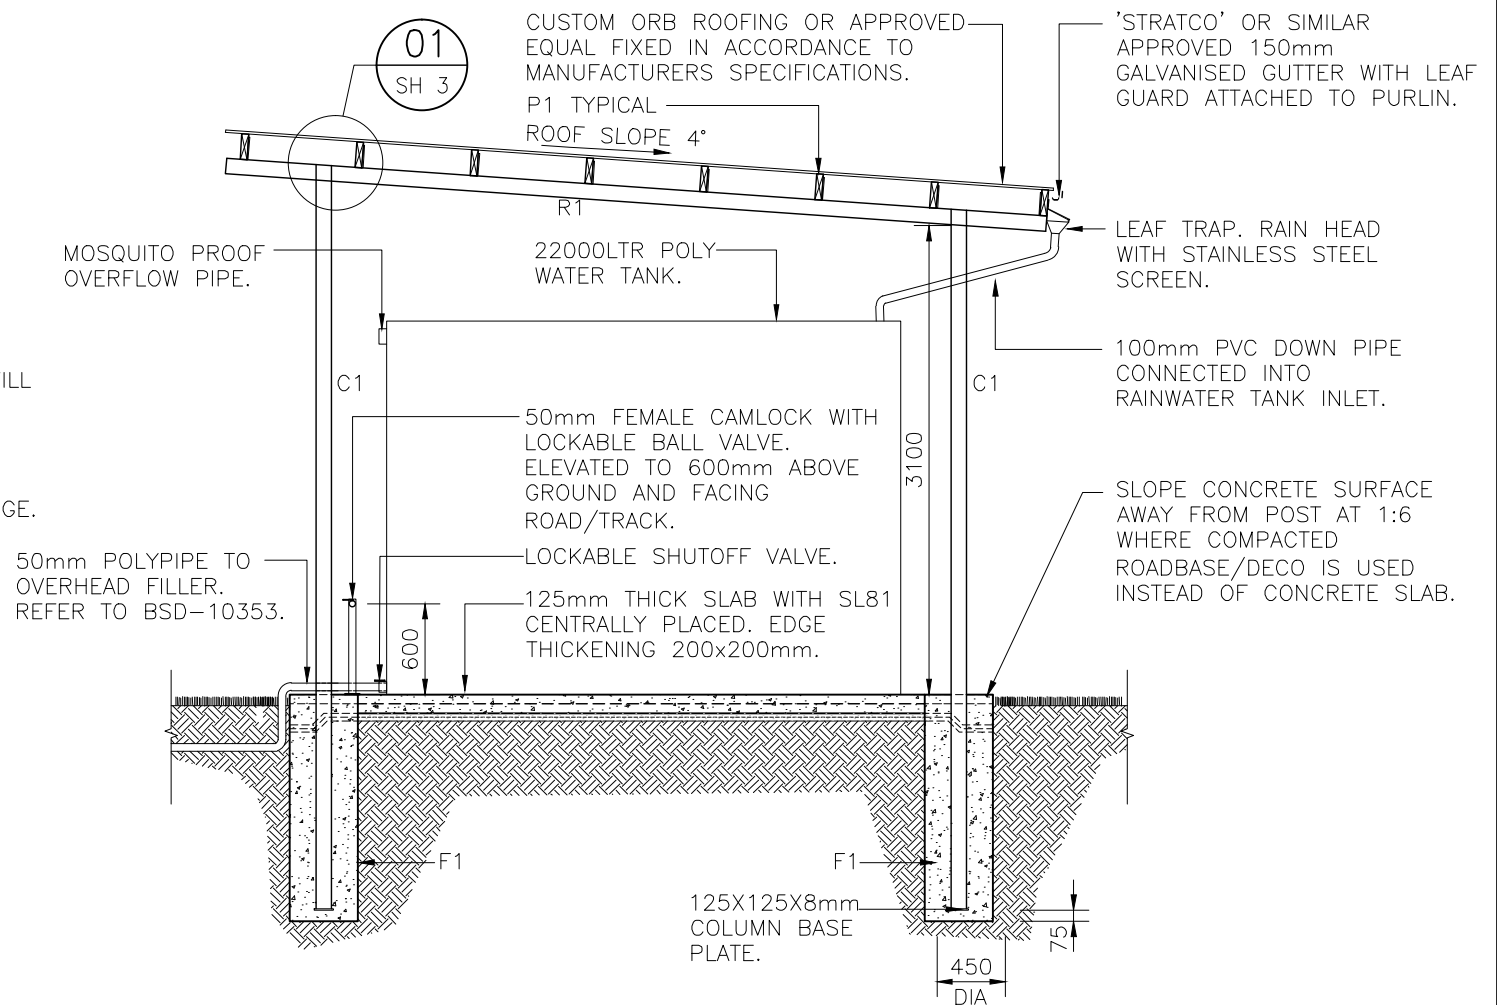
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BRISBANE CITY COUNCIL STANDARD DRAWING

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| B | Drawing Title Amended | FEB '16 | JUL '16 | JUL '16 |
| A | ORIGINAL ISSUE | DEC '14 | DEC '14 | DEC '14 |
| ISSUE | AMENDMENT | DRAWN DATE | CHK'D DATE | APPR'D DATE |

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Inga Condric
2015.06.15 07:06:38+10'00'


for ASSET ENGINEERING MANAGER
STRATEGIC ASSET MANAGEMENT
DESIGN APPROVED

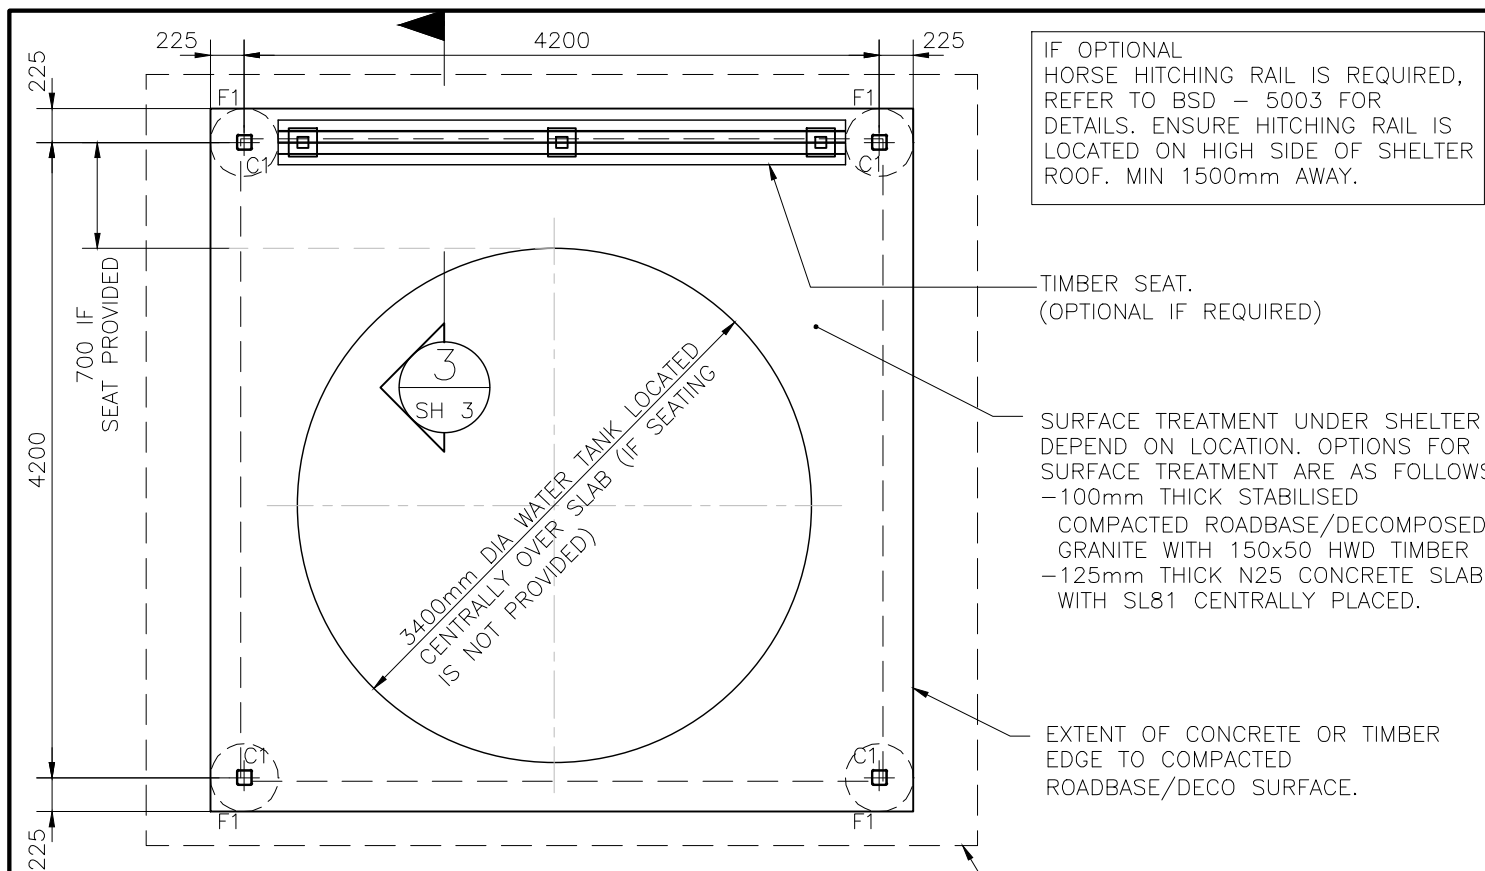C.Wood

SENIOR CO-ORDINATOR NATURAL ENVIRONMENT
ASSET SERVICES/BRISBANE INFRASTRUCTURE


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| DESIGN | CP0 - P&D | DATE | DEC '14 |
| DRAWN | CP0 - P&D | DATE | DEC '14 |
| CHECKED | BI - FSG - AS | DATE | DEC '14 |
| DRAWING FILENAME | BSD-10351 (B) Bushfire water supply shelter type 1 - Natural area - Plan - Sheet 2 of 3.dwg | | |
| ASSOCIATED PLANS | BSD-10351-Sheets 1 & 3 | | |



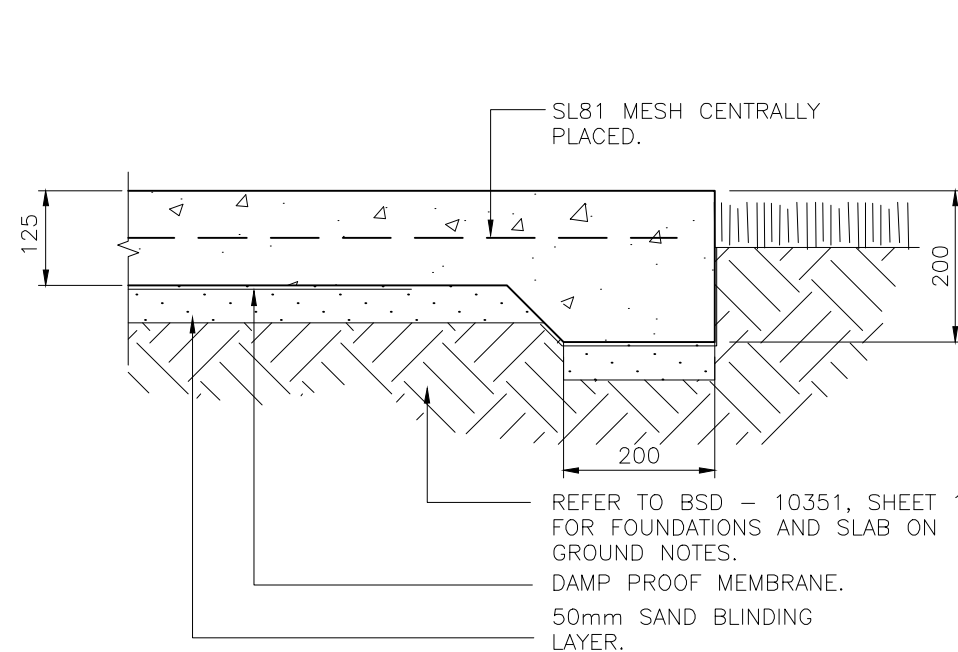

TYPICAL SLAB EDGE THICKENING DETAIL

SCALE: 1:10

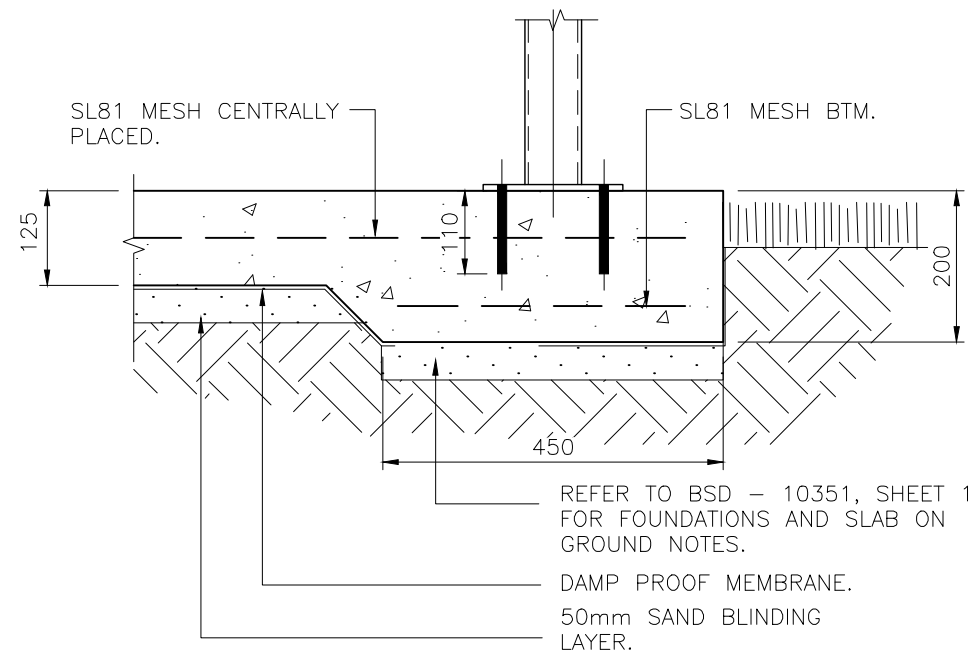


SLAB EDGE THICKENING DETAIL WHERE SEAT IS TO BE INSTALLED ON CONCRETE SLAB

SECTION

SCALE 1:10


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SH 2

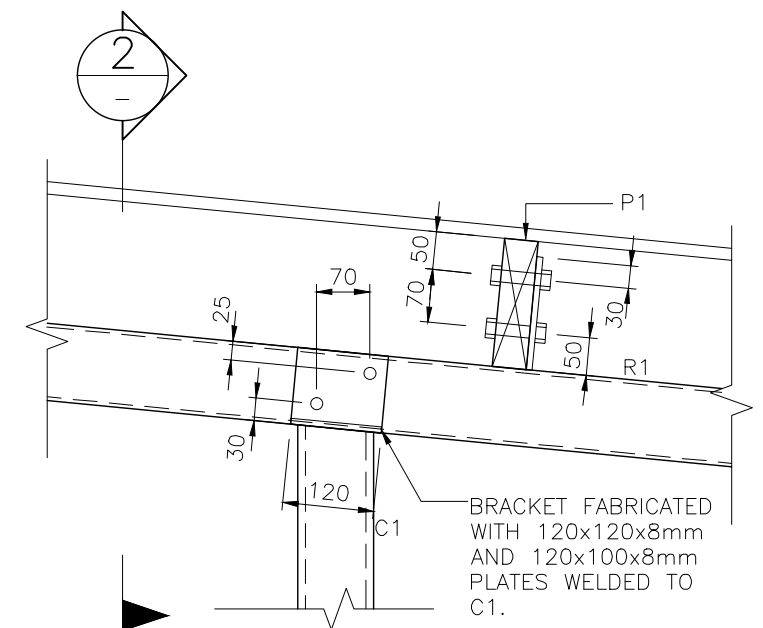

DETAIL


SCALE 1:10

1
SH 2

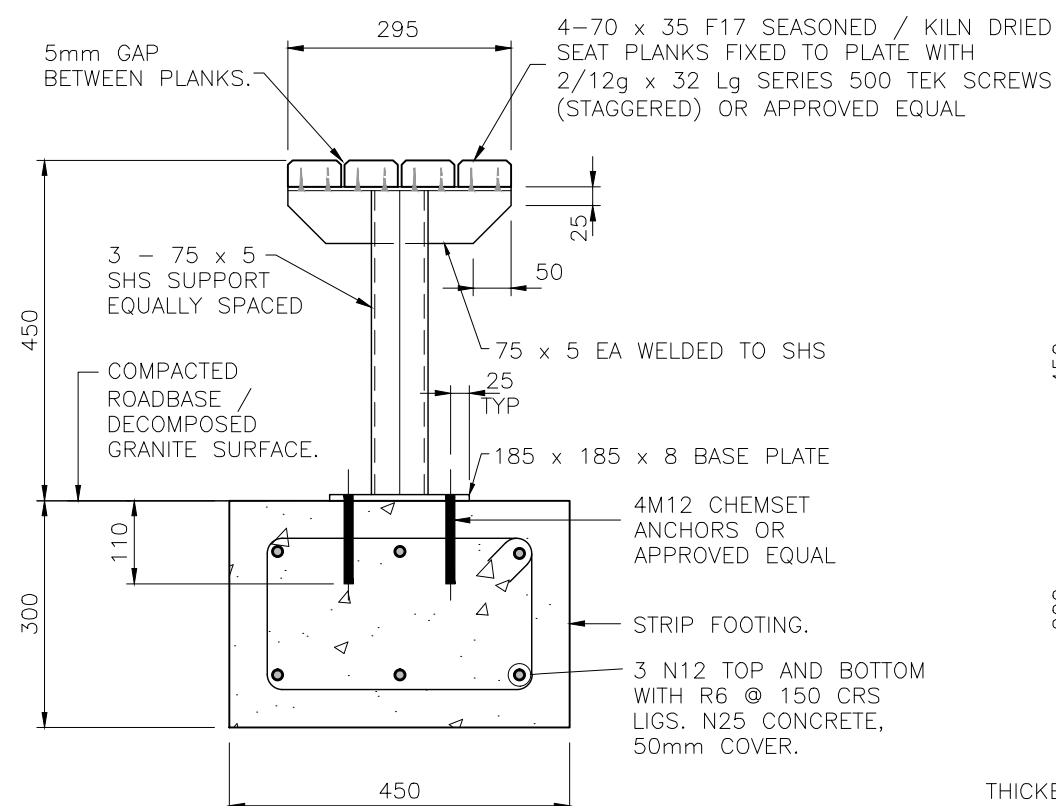


SEATING WHERE ON COMPACTED ROADBASE/DECOMPOSED GRANITE

SCALE: 1:10

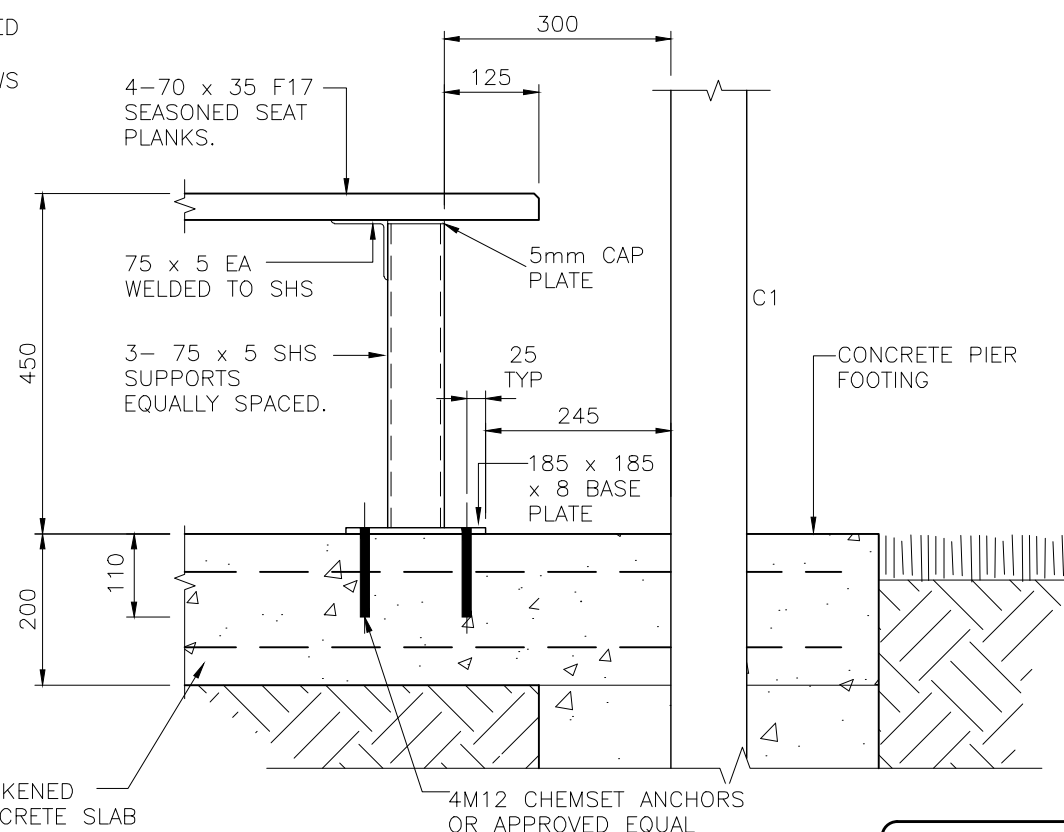

SEATING ON CONCRETE SLAB

SCALE: 1:10

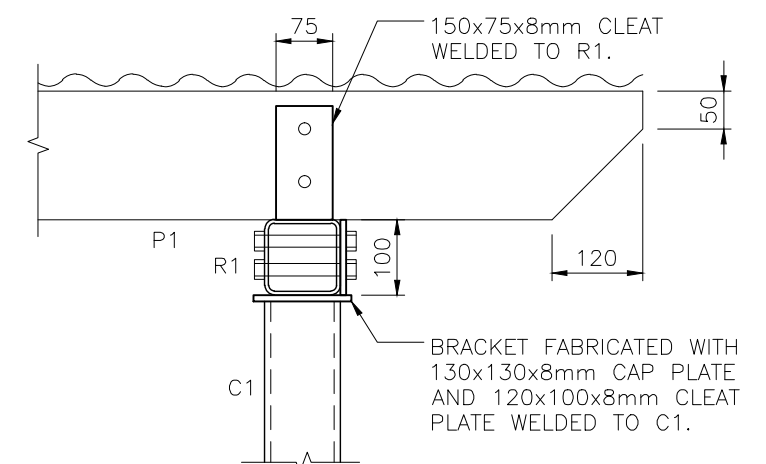

SECTION

SCALE 1:10

2
-

STRUCTURAL DESIGN CERTIFICATION

| | | |
|---|----------------------|--|
| DESIGN | DESIGN CHECK | AUTHORISED FOR ISSUE |
| Lenita Mendis RPEQ:8950 2014.12.10 16:33:44+10'00' | R.Hu (RPEQ No 13885) | Bala Balakumar RPEQ 3963 2014.12.11 09:01:17+10'00' |

BRISBANE CITY COUNCIL STANDARD DRAWING

**BUSHFIRE WATER SUPPLY
SHELTER TYPE 1 - NATURAL AREA
DETAILS - SHEET 3 OF 3**

| | |
|---------------|------------------|
| SCALE | AS SHOWN |
| DWG No. | BSD-10351 |
| ORIGINAL SIZE | A3 |
| REVISION | B |

| ISSUE | AMENDMENT | DRAWN DATE | CHK'D DATE | APPR'D DATE |
|-------|-----------------------|------------|------------|-------------|
| B | Drawing Title Amended | FEB '16 | JUL '16 | JUL '16 |
| A | ORIGINAL ISSUE | DEC '14 | DEC '14 | DEC '14 |

DRAWING AUTHORISED FOR PUBLICATION

Inga Condric
2015.06.15 07:07:47+10'00'

for ASSET ENGINEERING MANAGER

STRATEGIC ASSET MANAGEMENT

DESIGN APPROVED

C.Wood

SENIOR CO-ORDINATOR NATURAL ENVIRONMENT

ASSET SERVICES/BRISBANE INFRASTRUCTURE

| | | | |
|------------------|--|------|---------|
| DESIGN | CP0 - P&D | DATE | DEC '14 |
| DRAWN | CP0 - P&D | DATE | DEC '14 |
| CHECKED | BI - FSG - AS | DATE | DEC '14 |
| DRAWING FILENAME | BSD-10351B1 Bushfire water supply shelter type 1 - Natural area - Details - Sheet 3 of 3.dwg | | |
| ASSOCIATED PLANS | BSD-10351-Sheets 1 & 2 | | |



GENERAL NOTES:

- G1 THE BUILDER SHALL BE RESPONSIBLE FOR MAINTAINING STABILITY OF THE STRUCTURE UNTIL COMPLETION OF CONSTRUCTION AND SHALL ENSURE THAT NO PART OF THE STRUCTURE IS OVERSTRESSED.
- G2 THE BUILDER SHALL CHECK ALL DIMENSIONS AND ALL EXISTING CONDITIONS BEFORE COMMENCING CONSTRUCTION.
- G3 ANY DAMAGE CAUSED BY THE CONTRACTOR SHALL BE MADE GOOD AT THEIR OWN COST.
- G4 ALL MATERIALS AND WORKMANSHIP SHALL BE IN ACCORDANCE WITH THE CURRENT EDITIONS OF THE FOLLOWING AUSTRALIAN STANDARDS, EXCEPT WHERE VARIED BY THE SPECIFICATIONS AND/OR DRAWINGS: –
AS 1684.2(2010) RESIDENTIAL TIMBER FRAMED CONSTRUCTION
AS 1720.1(2010) TIMBER STRUCTURES
AS 2870(2011) RESIDENTIAL SLABS AND FOOTINGS
AS 3600 CONCRETE STRUCTURES
AS 3798 GUIDELINES ON EARTHWORKS FOR COMMERCIAL AND RESIDENTIAL DEVELOPMENTS
AS 4100 STEEL STRUCTURES
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- G10 EXISTING SERVICES TO BE LOCATED BEFORE CONSTRUCTION COMMENCES.
- G11 THE DETAILS OF BUSHFIRE WATER SUPPLY SHELTER INCLUDED IN DRAWING SHEETS 1 TO 3.
- G12 CONSULT BCC ARCHITECTS FOR COLOUR SCHEME OF THE STRUCTURE.

DESIGN CRITERIA:

WIND LOADS : REGION B TERRAIN CATEGORY 2.5
ULTIMATE DESIGN WIND SPEED = 54.0 m/s
DESIGN LIFE : 50 YEARS WITH ROUTINE MAINTENANCE
LIVE LOADS: : FLOOR = 5.0 kPa. ROOF = 0.25 kPa / 1.4 kN.

STRUCTURE IS DESIGNED TO REMAIN OPEN – NO
SCREENS(IMPERMEABLE OR PERMEABLE BARRIERS) TO BE INSTALLED.

FOUNDATIONS AND SLAB ON GROUND:

- F1 ALL FOOTINGS ARE TO BE FOUNDED IN THE NATURAL UNDISTURBED SOIL PROFILE WITH A MINIMUM ALLOWABLE SOIL BEARING CAPACITY OF 100kPa UNLESS NOTED OTHERWISE. IF THE SITE CONDITION IS DIFFERENT, CONSULT A STRUCTURAL ENGINEER.
- F2 SOIL TEST IS REQUIRED TO CONFIRM BEARING CAPACITY AND SITE CLASSIFICATION TO AS 2870.
- F3 FOUNDATIONS ARE TO BE CHECKED AND CERTIFIED BY A REGISTERED PROFESSIONAL GEOTECHNICAL ENGINEER, QUEENSLAND (RPEQ).
- F4 COMPACT AND PREPARE THE BASE TO PROVIDE A SOUND PLATFORM AND ANY ORGANIC, SOFT OR LOOSE MATERIALS REMOVED AND REPLACED WITH COMPACTED FILL – BCC SPECIFICATION S300 QUARRY PRODUCT CLASS 1 MATERIAL.
- F5 FOR CONTROL JOINT LOCATIONS, REFER TO DRAWINGS.
- F6 SLABS ON GROUND SHALL BE UNDERLAIN WITH CONTINUOUS LAYER OF 200 MICRON (0.2mm) THICK POLYETHYLENE DAMPPROOF MEMBRANE AS PER AS 2870, LAPPED AND TAPED TO MANUFACTURER’S SPECIFICATION.

EARTHWORKS:

- E1 STRIP ALL HUMUS MATERIAL FROM THE AREA OF THE BUILDING IMPRINT AND 1000 BEYOND.
- E2 PROOF ROLL THE AREAS TO BE CONCRETED AND PAVED. REMOVE ANY WEAK MATERIAL.
- E3 COMPACTED FILL SHALL BE COMPACTED IN LAYERS NOT EXCEEDING 150mm LOOSE DEPTH TO 98% MAXIMUM DRY DENSITY IN ACCORDANCE WITH AS1289. 5.1.1 (STANDARD COMPACTION). CARRY OUT DENSITY TESTS AT A RATE OF 2 PER LAYER OF FILL. EVERY TEST MUST PASS.

TIMBER NOTES:

- T1 ALL WORKMANSHIP AND MATERIAL SHALL BE IN ACCORDANCE WITH AS 1720 AND AS 1684.
- T2 TIMBER GRADES SHALL BE AS SHOWN ON THE DRAWINGS. ALL TIMBER TO BE SEASONED OR KILN DRIED GRADE MGP12 MINIMUM U.N.O WITH NATURAL DURABILITY CLASS 4 (ABOVE GROUND) OR BETTER.
- T3 ALL FASTENERS SHALL BE HOT DIP GALVANISED. BOLTS TO BE METRIC HEX-HEAD M16 MINIMUM WITH WASHERS U.N.O. CLEAT PLATES TO BE 10mm THICK U.N.O.
- T4 TIMBER JOINT GROUP JD4 OR BETTER.
- T5 ALL TIMBER SHALL BE FULLY DRESSED AND ALL EDGES, ENDS AND CORNERS TO BE 6mm DRESSED.
- T6 PROTECT ENDS OF EXPOSED MEMBERS. USE A HIGH QUALITY EXTERIOR PAINT FINISH.
- T7 ALL TIMBER FRAMING SHALL BE NATURALLY TERMITE RESISTANT OR TREATED USING LOSP OR ACQ CHEMICALS TO A HAZARD RESISTANCE LEVEL H3 IN ACCORDANCE WITH AS 1684.2 APPENDIX B.
- T8 ALL TIMBER TO BE STAINED OR PAINTED PRIOR TO FIXING INTO FINAL POSITION. REFER TO PROJECT SPECIFICATION FOR EACH PROJECT.

CONCRETE NOTES:

- C1 ALL WORKMANSHIP AND MATERIAL SHALL BE IN ACCORDANCE WITH AS 3600.
- C2 ALL CONCRETE SHALL BE PREMIXED BY AN APPROVED SUPPLIER.
- C3 ALL CEMENT SHALL BE TYPE GP OR GB.
- C4 CONCRETE SPECIFICATION: NOMINAL AGGREGATE SIZE TO BE 20mm, SLUMP TO BE NOT GREATER THAN 80mm.
- C5 CONCRETE STRENGTH AND CLEAR CONCRETE COVER TO REINFORCEMENT SHALL BE IN ACCORDANCE WITH THE FOLLOWING TABLE U.N.O
- | | | |
|----------|-----------|---------------------|
| ELEMENT: | F’C (MPa) | REINFORCEMENT COVER |
| PIERS | 25 | 75 MIN. |
| SLAB | 25 | 50 MIN. |
- C6 ALL LAPS IN REINFORCEMENT SHALL BE AS SHOWN IN THE TABLE BELOW UNLESS NOTED OTHERWISE.
- | | |
|------|-----------------|
| BAR | LAP LENGTH (mm) |
| N12 | 500 |
| N16 | 650 |
| MESH | 350 |
- C7 REINFORCEMENT SYMBOLS:
- R STRUCTURAL PLAIN ROUND GRADE 250R TO AS 4671.
- N DEFORMED BAR GRADE D500N TO AS 4671.
- SL HARD DRAWN STEEL REINFORCING FABRIC GRADE D500L TO AS 4671.
- C8 SIZES OF CONCRETE ELEMENTS DO NOT INCLUDE THICKNESS OF APPLIED FINISHES.
- C9 NO HOLES, CHASES OR EMBEDMENT OF PIPES OTHER THAN THOSE SHOWN ON THE STRUCTURAL DRAWINGS SHALL BE MADE IN CONCRETE MEMBERS WITHOUT PRIOR APPROVAL BY THE SUPERINTENDENT.
- C10 ALL CONCRETE SHALL BE COMPACTED USING A MECHANICAL VIBRATION PROCESS.
- C11 ALL REINFORCEMENT SHALL BE SECURELY SUPPORTED IN ITS CORRECT POSITION DURING CONCRETING BY APPROVED BAR CHAIRS, SPACERS OR SUPPORT BARS.
- C12 CONSTRUCTION JOINTS SHALL BE PROPERLY FORMED AND USED ONLY WHERE SHOWN OR SPECIFICALLY APPROVED BY THE SUPERINTENDENT.

INSPECTION AND CERTIFICATION NOTES:

- A1 THE CONTRACTOR’S ENGINEER (RPEQ) SHALL UNDERTAKE INSPECTIONS DURING CONSTRUCTION TO ENSURE ALL CONSTRUCTION WORKS ARE IN ACCORDANCE WITH THE MOST CURRENT ISSUE OF THE STRUCTURAL DRAWINGS AND CONTRACT DOCUMENTS. THE RPEQ SHALL CERTIFY ALL CONSTRUCTION WORK (FORM 16). ANY ALTERNATIVE TECHNIQUE USED IN CONSTRUCTION SHALL BE FOLLOWED BY A DESIGN CERTIFICATE (FORM 15) BY THE CONTRACTOR’S PROFESSIONAL ENGINEER (RPEQ)


STEELWORK NOTES


- S1. ALL WORKMANSHIP & MATERIALS SHALL BE IN ACCORDANCE WITH AS4100 & AS/NZS1554.
- S2. ALL STEEL SHALL BE IN ACCORDANCE WITH:
AS1163 GRADE C350LO FOR RECTANGULAR AND SQUARE HOLLOW SECTIONS U.N.O.
AS 3679 GRADE 300 FOR HOT ROLLED SECTIONS.
- S3. ALL BOLTS TO BE METRIC HEXAGONAL TO AS 1252 U.N.O.
ALL BOLTS TO BE M16 4.6/S TO AS/NZS 1252 U.N.O.
ALL BOLTS TO BE HOT DIP GALVANISED TO AS 1214 U.N.O.
- S4. ALL CLEATS AND GUSSETS SHALL BE 10mm PLATE TO AS/NZS3678 GRADE 250 U.N.O.
- S5. METAL ROOF CLADDING TO BE 0.42 BMT LYSAGHT CUSTOM ORB WITH A COLORBOND FINISH OR APPROVED EQUAL FIXED AS PER MANUFACTURER’S SPECIFICATIONS – COLORBOND COLOUR AS PER SPECIFICATION.
- S6. ALL WELDS TO BE 6mm CONTINUOUS FILLET WELDS (CFW) STRUCTURAL PURPOSE (SP) WELDS U.N.O. ALL WELDS TO BE MADE USING E48XX OR W50X GRADE 1 (OR BETTER) ELECTRODES TO AS/NZS 1554. GRIND ALL CORNERS & WELDS SMOOTH.
- S7. ALL STEELWORK TO BE HOT DIP GALVANISED IN ACCORDANCE WITH AS/NZS 2312 HDG600 SPECIFICATION. SURFACE PREPARATION FOR CORROSION PROTECTION COATING IS TO BE CLASS 2½ TO AS 1627 AND PICKLED PRIOR GALVANISING. HOT DIPPED GALVANISED COATING SHALL BE IN ACCORDANCE WITH AS/NZS 4680. THE PRINCIPAL CONTRACTOR SHALL CONFER WITH THE FABRICATOR AND GALVANISER TO ENSURE VENT HOLES ARE PROVIDED IN ACCORDANCE WITH AS/NZS 4680.
- S8. THE PRINCIPAL CONTRACTOR SHALL CONFER WITH THE FABRICATOR AND GALVANISER TO ENSURE VENT HOLES ARE PROVIDED IN ACCORDANCE WITH AS/NZS 4680.
- S9. ANY POST GALVANISING DAMAGE TO BE MADE GOOD WITH HIGH QUALITY TWO PACK EPOXY ZINC RICH PAINT CONFORMING TO AS/NZS 3750.9 WITH A MINIMUM DRY FILM THICKNESS OF 100 MICRONS. SURFACE PREPARATION TO BE ACCORDING TO PAINT MANUFACTURER’S RECOMMENDATIONS.
- S10. THE ENDS OF ALL TUBULAR OR HOLLOW MEMBERS ARE TO BE SEALED WITH 6mm THICK PLATES AND CONTINUOUS FILLET WELDED U.N.O.
- S11. PROTECTIVE COATINGS TO BE APPLIED AFTER ALL FABRICATION COMPLETED. NO WELDING ETC TO BE CARRIED OUT DURING OR AFTER APPLICATION OF COATING SYSTEM.

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| STRUCTURAL DESIGN CERTIFICATION | | | | | | | | | |
| DESIGN | | Lenita Mendis RPEQ:8950 2014.12.10 16:34:11 +10'00' | | DESIGN CHECK | | R.Hu (RPEQ No 13885) | | AUTHORISED FOR ISSUE Bala Balakumar, RPEQ:3963 2014.12.11 09:02:07 +10'00' | |
| BRISBANE CITY COUNCIL STANDARD DRAWING | | | | | | | | | |
| BUSHFIRE WATER SUPPLY SHELTER TYPE 2 – NATURAL AREA – SHEET 1 OF 3 – NOTES | | | | | | | | SCALE AS SHOWN DWG No: BSD-10352 ORIGINAL SIZE A3 REVISION A | |


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| DRAWING AUTHORISED FOR PUBLICATION | | | | | DESIGN | CPO – P&D | DATE | DEC '14 |
| ASSET ENGINEERING MANAGER STRATEGIC ASSET MANAGEMENT | | | | | DRAWN | CPO – P&D | DATE | DEC '14 |
| DESIGN APPROVED | | | | | CHECKED | BI – FSG – AS | DATE | DEC '14 |
| SENIOR CO-ORDINATOR NATURAL ENVIRONMENT ASSET SERVICES/BRISBANE INFRASTRUCTURE | | | | | DRAWING FILENAME | BSD-10352-Sheet 1 of 3.dwg | | |
| | | | | | ASSOCIATED PLANS | BSD-10352-Sheets 2 & 3 | | |

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| A | ORIGINAL ISSUE | DEC '14 | DEC '14 | DEC '14 |
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FLOOR PLAN
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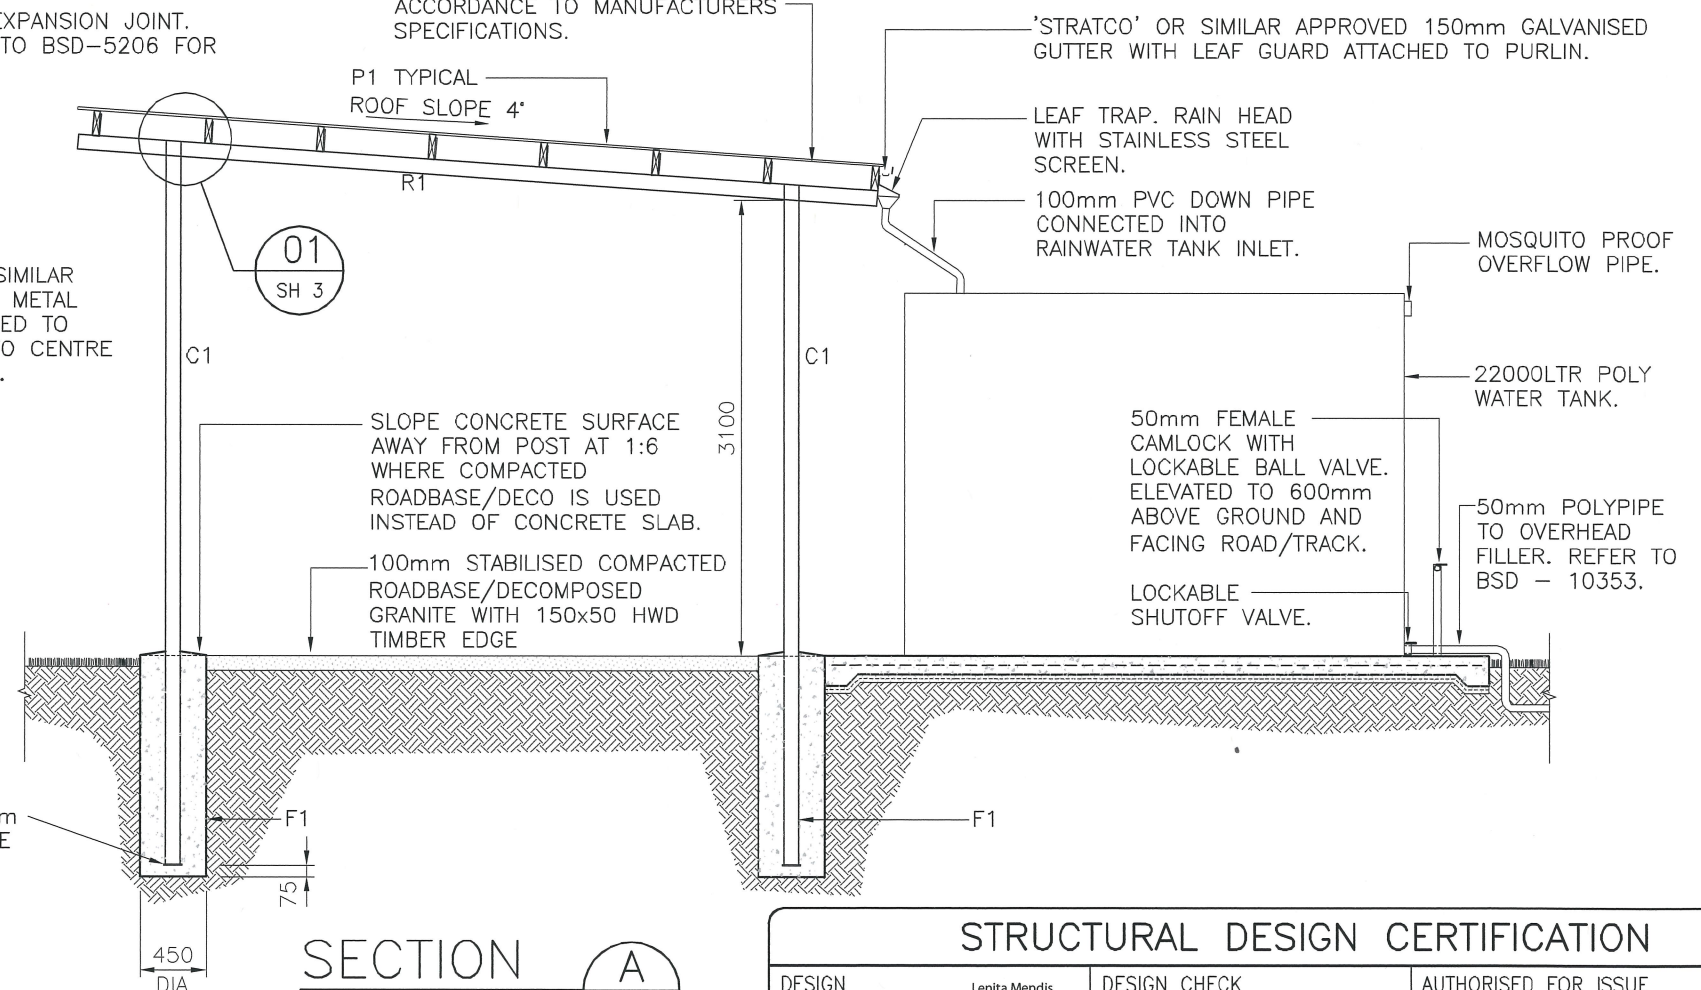


ROOF PLAN
SCALE: 1:50
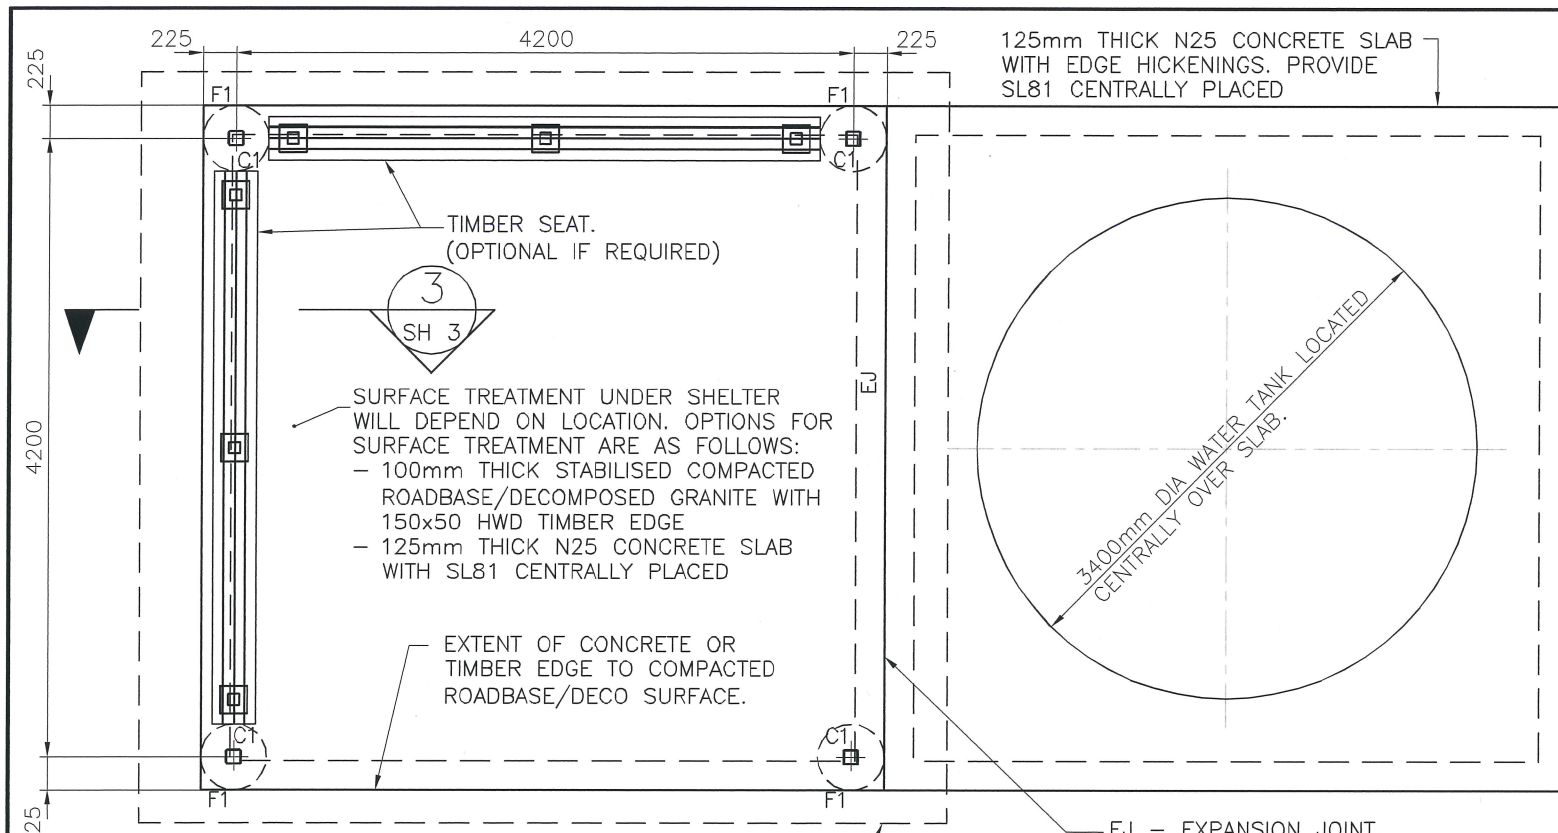
| MEMBER SCHEDULE | | | |
|-----------------|-------------------------------------|---------------------------------|--|
| MARK | MEMBER | DESCRIPTION | COMMENTS |
| C1 | 100x5 SHS | POST | |
| R1 | 100x5 SHS | RAFTER | FIXED TO POST WITH 2xM16 BOLTS. 5mm END CAPS |
| P1 | 170x45 MGP12 SEASONED TIMBER | PURLIN | FIXED TO RAFTER WITH 2x M12 BOLTS. |
| BR1 | 30x1.0 GALVANISED STEEL STRAP BRACE | STRAP BRACING TO TOP OF PURLINS | 5/3.15ø x 35mm NAILS AT EACH END OF STRAPPING FIXED TO SIDES OF EDGE PURLINS AND ONE NAIL TO TOP OF EACH PURLIN. |
| F1 | 450øx1500 DEEP | PIER FOOTING | N25 CONCRETE. |

IF OPTIONAL HORSE HITCHING RAIL IS REQUIRED, REFER TO BSD - 5003 FOR DETAILS. ENSURE HITCHING RAIL IS LOCATED ON HIGH SIDE OF SHELTER ROOF. MIN 1500mm AWAY.

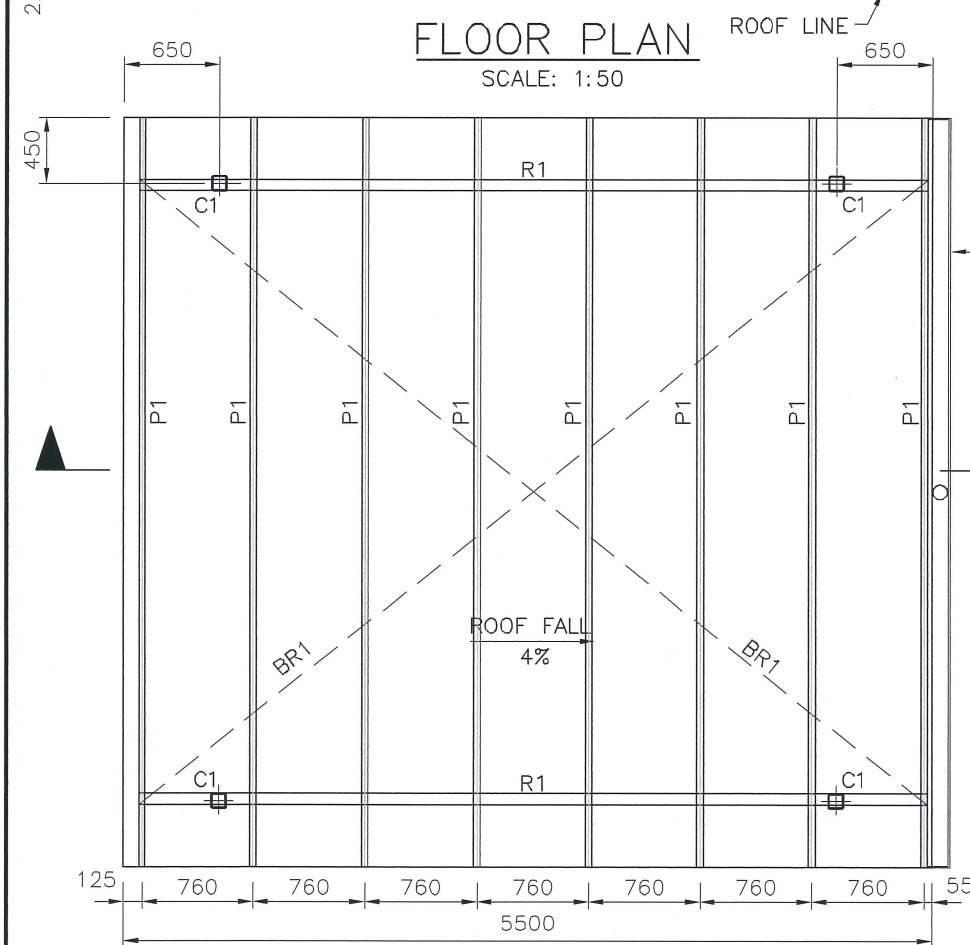CUSTOM ORB ROOFING OR APPROVED EQUAL FIXED IN ACCORDANCE TO MANUFACTURERS SPECIFICATIONS.



SECTION A-A
SCALE 1:50

| STRUCTURAL DESIGN CERTIFICATION | | |
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| DESIGN | Lenita Mendis RPEQ:8950 2014.12.10 16:34:35 +10'00' | DESIGN CHECK R.Hu (RPEQ No 13885) |
| AUTHORISED FOR ISSUE | | Bala Balakumar, RPEQ:3963 2014.12.11 09:02:44 +10'00' |


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| A | ORIGINAL ISSUE | DEC '14 | DEC '14 | DEC '14 |

DRAWING AUTHORISED FOR PUBLICATION
ASSET ENGINEERING MANAGER
STRATEGIC ASSET MANAGEMENT
DESIGN APPROVED
L. Wood
SENIOR CO-ORDINATOR NATURAL ENVIRONMENT
ASSET SERVICES/BRISBANE INFRASTRUCTURE

| | | | |
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| DESIGN | CPO - P&D | DATE | DEC '14 |
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| DRAWING FILENAME | BSD-10352-Sheet 2 of 3.dwg | | |
| ASSOCIATED PLANS | BSD-10352-Sheets 1 & 3 | | |




| BRISBANE CITY COUNCIL STANDARD DRAWING | |
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| BUSHFIRE WATER SUPPLY SHELTER TYPE 2 - NATURAL AREA - SHEET 2 OF 3 - PLAN | SCALE AS SHOWN DWG No. BSD-10352 ORIGINAL SIZE A3 REVISION A |

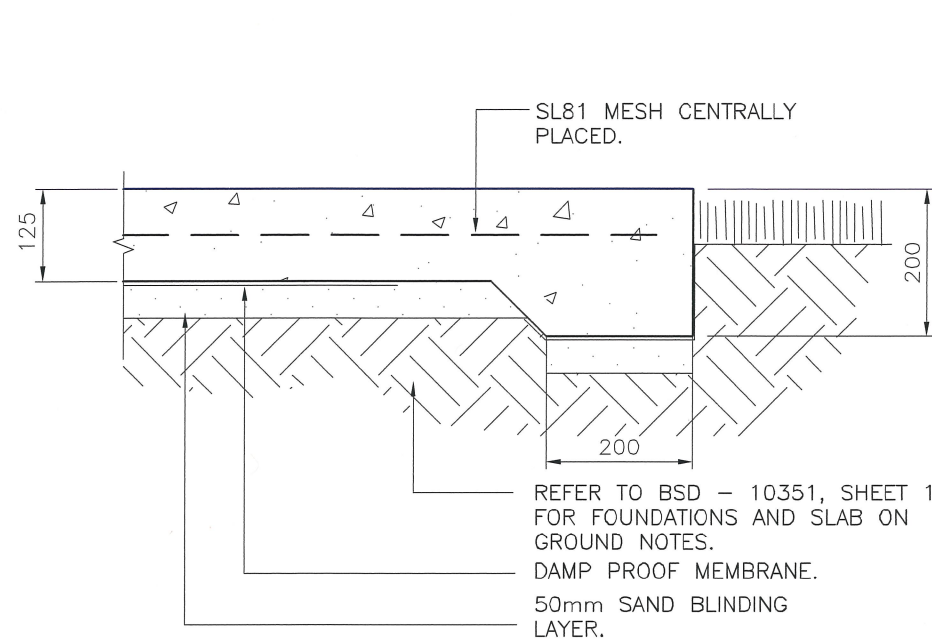

TYPICAL SLAB EDGE THICKENING DETAIL

SCALE: 1:10

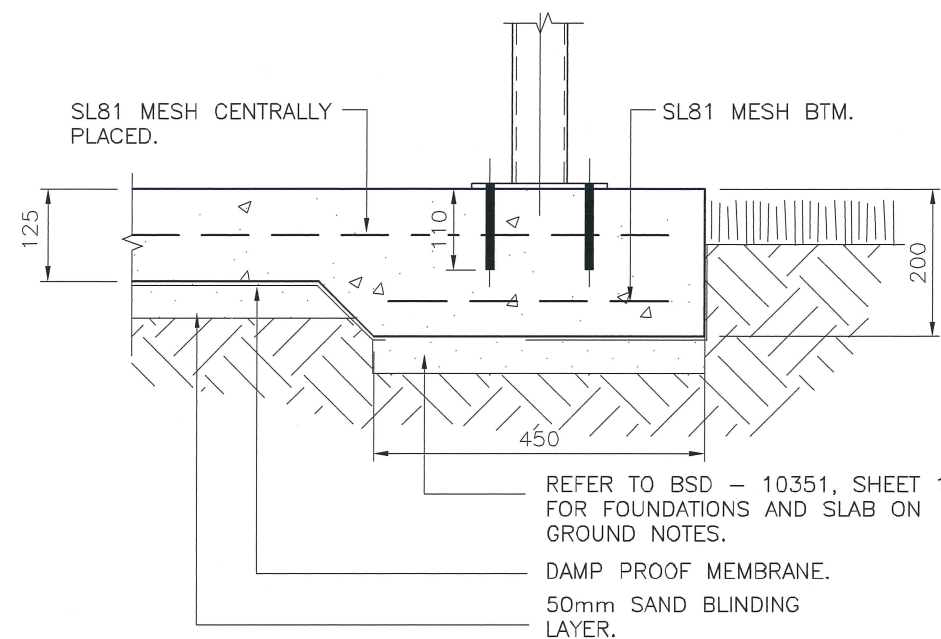


SLAB EDGE THICKENING DETAIL WHERE SEAT IS TO BE INSTALLED ON CONCRETE SLAB

SECTION

SCALE 1:10


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DETAIL

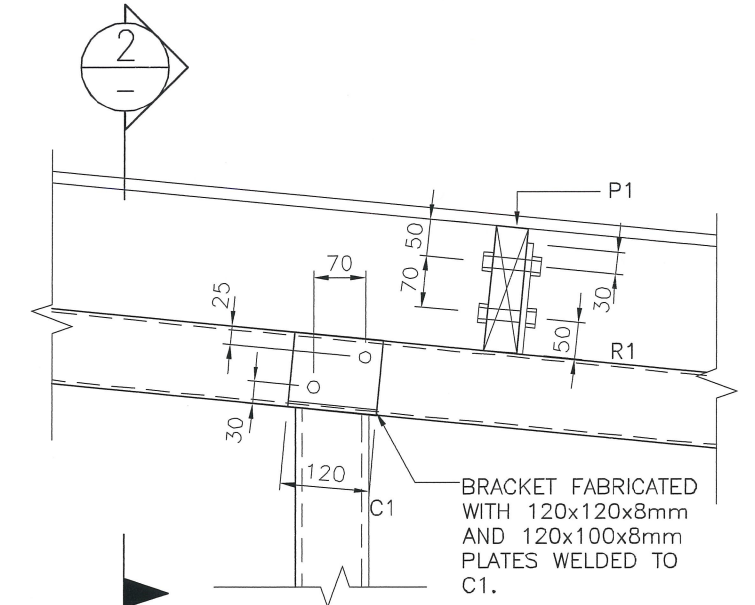
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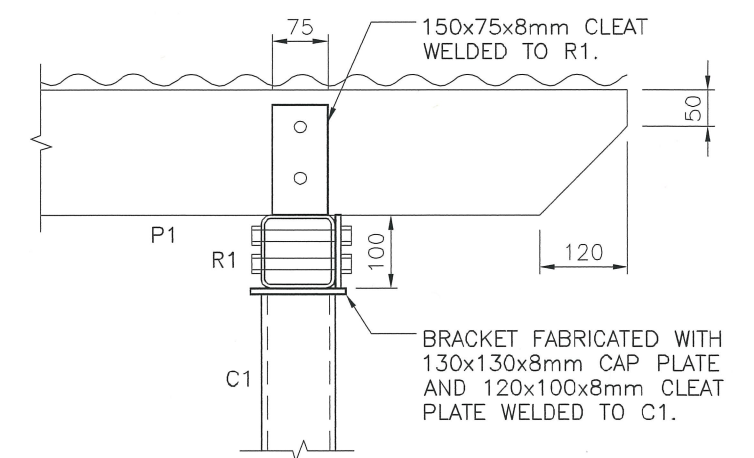
SEATING WHERE ON COMPACTED ROADBASE/DECOMPOSED GRANITE

SCALE: 1:10



SEATING ON CONCRETE SLAB

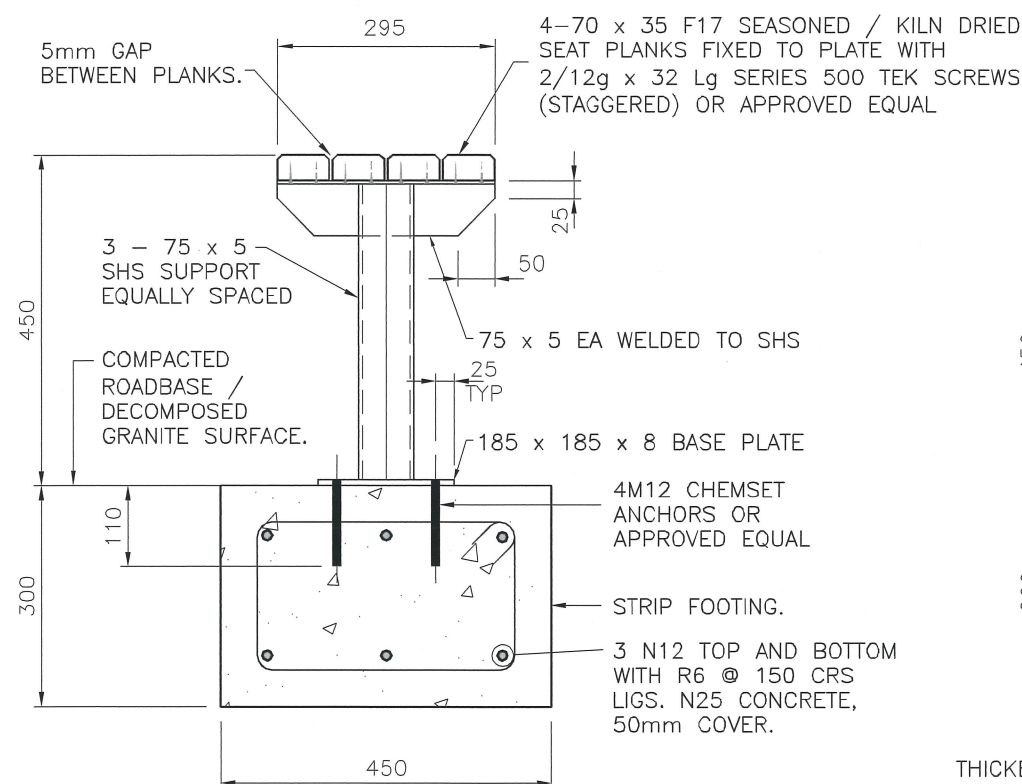SCALE: 1:10

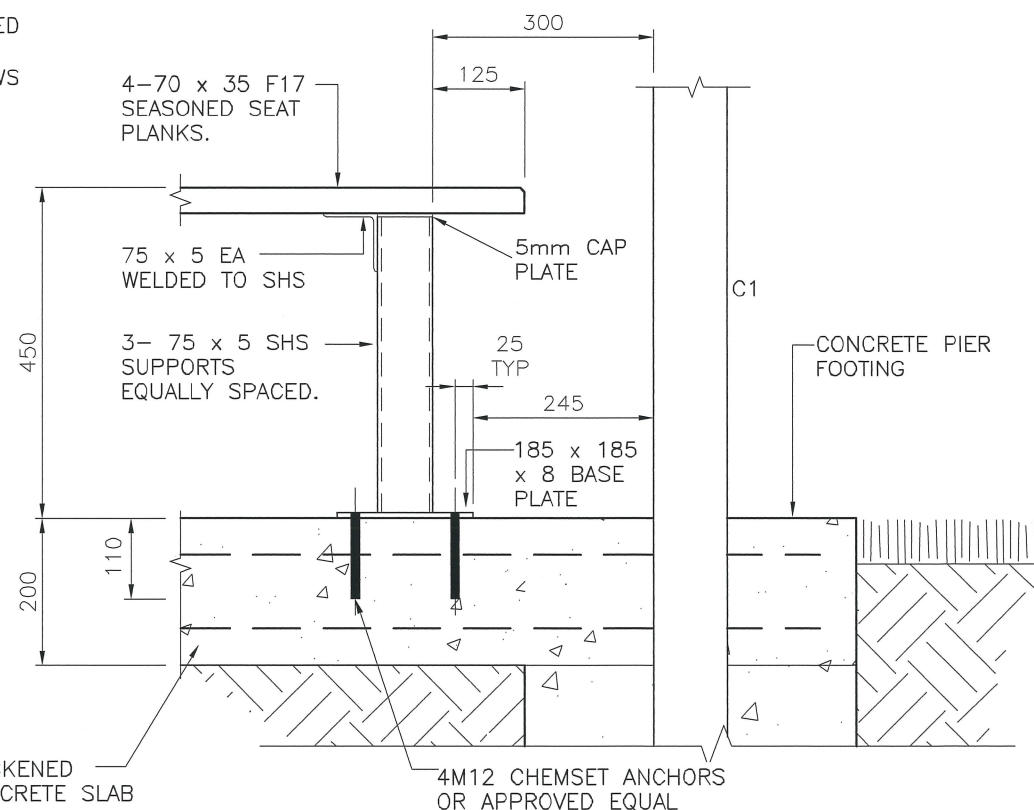

SECTION

SCALE 1:10

2
-

STRUCTURAL DESIGN CERTIFICATION

| | | | | | |
|--------|--|--------------|----------------------|----------------------|--|
| DESIGN | Lenita Mendis RPEQ:8950 2014.12.10 16:35:00 +10'00' | DESIGN CHECK | R.Hu (RPEQ No 13885) | AUTHORISED FOR ISSUE | Bala Balakumar, RPEQ:3963 2014.12.11 09:03:25 +10'00' |
|--------|--|--------------|----------------------|----------------------|--|

BRISBANE CITY COUNCIL STANDARD DRAWING

| | | | |
|--|--|---------------|-----------|
| BUSHFIRE WATER SUPPLY SHELTER TYPE 2 - NATURAL AREA - SHEET 3 OF 3 - DETAILS | | SCALE | AS SHOWN |
| | | DWG No. | BSD-10352 |
| | | ORIGINAL SIZE | A3 |
| | | REVISION | A |

| ISSUE | AMENDMENT | DRAWN DATE | CHK'D DATE | APPR'D DATE |
|-------|----------------|------------|------------|-------------|
| A | ORIGINAL ISSUE | DEC '14 | DEC '14 | DEC '14 |

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| DRAWING AUTHORISED FOR PUBLICATION |
| ASSET ENGINEERING MANAGER STRATEGIC ASSET MANAGEMENT DESIGN APPROVED |
| SENIOR CO-ORDINATOR NATURAL ENVIRONMENT ASSET SERVICES/BRISBANE INFRASTRUCTURE |

| | | | |
|------------------|----------------------------|------|---------|
| DESIGN | CPO - P&D | DATE | DEC '14 |
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| CHECKED | BI - FSG - AS | DATE | DEC '14 |
| DRAWING FILENAME | BSD-10352-Sheet 3 of 3.dwg | | |
| ASSOCIATED PLANS | BSD-10352-Sheets 1 & 2 | | |



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STRUCTURE IS DESIGNED TO REMAIN OPEN – NO
SCREENS(IMPERMEABLE OR PERMEABLE BARRIERS) TO BE INSTALLED.

FOUNDATIONS AND SLAB ON GROUND:

- F1 ALL FOOTINGS ARE TO BE FOUNDED IN THE NATURAL UNDISTURBED SOIL PROFILE WITH A MINIMUM ALLOWABLE SOIL BEARING CAPACITY OF 100kPa UNLESS NOTED OTHERWISE. IF THE SITE CONDITION IS DIFFERENT, CONSULT A STRUCTURAL ENGINEER.
- F2 SOIL TEST IS REQUIRED TO CONFIRM BEARING CAPACITY AND SITE CLASSIFICATION TO AS 2870.
- F3 FOUNDATIONS ARE TO BE CHECKED AND CERTIFIED BY A REGISTERED PROFESSIONAL GEOTECHNICAL ENGINEER, QUEENSLAND (RPEQ).
- F4 COMPACT AND PREPARE THE BASE TO PROVIDE A SOUND PLATFORM AND ANY ORGANIC, SOFT OR LOOSE MATERIALS REMOVED AND REPLACED WITH COMPACTED FILL – BCC SPECIFICATION S300 QUARRY PRODUCT CLASS 1 MATERIAL.
- F5 FOR CONTROL JOINT LOCATIONS, REFER TO DRAWINGS.
- F6 SLABS ON GROUND SHALL BE UNDERLAIN WITH CONTINUOUS LAYER OF 200 MICRON (0.2mm) THICK POLYETHYLENE DAMPPROOF MEMBRANE AS PER AS 2870, LAPPED AND TAPED TO MANUFACTURER’S SPECIFICATION.

EARTHWORKS:

- E1 STRIP ALL HUMUS MATERIAL FROM THE AREA OF THE BUILDING IMPRINT AND 1000 BEYOND.
- E2 PROOF ROLL THE AREAS TO BE CONCRETED AND PAVED. REMOVE ANY WEAK MATERIAL.
- E3 COMPACTED FILL SHALL BE COMPACTED IN LAYERS NOT EXCEEDING 150mm LOOSE DEPTH TO 98% MAXIMUM DRY DENSITY IN ACCORDANCE WITH AS1289. 5.1.1 (STANDARD COMPACTION). CARRY OUT DENSITY TESTS AT A RATE OF 2 PER LAYER OF FILL. EVERY TEST MUST PASS.

TIMBER NOTES:

- T1 ALL WORKMANSHIP AND MATERIAL SHALL BE IN ACCORDANCE WITH AS 1720 AND AS 1684.
- T2 TIMBER GRADES SHALL BE AS SHOWN ON THE DRAWINGS. ALL TIMBER TO BE SEASONED OR KILN DRIED GRADE MGP12 MINIMUM U.N.O WITH NATURAL DURABILITY CLASS 4 (ABOVE GROUND) OR BETTER.
- T3 ALL FASTENERS SHALL BE HOT DIP GALVANISED. BOLTS TO BE METRIC HEX–HEAD M16 MINIMUM WITH WASHERS U.N.O. CLEAT PLATES TO BE 10mm THICK U.N.O.
- T4 TIMBER JOINT GROUP JD4 OR BETTER.
- T5 ALL TIMBER SHALL BE FULLY DRESSED AND ALL EDGES, ENDS AND CORNERS TO BE 6mm DRESSED.
- T6 PROTECT ENDS OF EXPOSED MEMBERS. USE A HIGH QUALITY EXTERIOR PAINT FINISH.
- T7 ALL TIMBER FRAMING SHALL BE NATURALLY TERMITE RESISTANT OR TREATED USING LOSP OR ACQ CHEMICALS TO A HAZARD RESISTANCE LEVEL H3 IN ACCORDANCE WITH AS 1684.2 APPENDIX B.
- T8 ALL TIMBER TO BE STAINED OR PAINTED PRIOR TO FIXING INTO FINAL POSITION. REFER TO PROJECT SPECIFICATION FOR EACH PROJECT.

CONCRETE NOTES:


- C1 ALL WORKMANSHIP AND MATERIAL SHALL BE IN ACCORDANCE WITH AS 3600.
- C2 ALL CONCRETE SHALL BE PREMIXED BY AN APPROVED SUPPLIER.
- C3 ALL CEMENT SHALL BE TYPE GP OR GB.
- C4 CONCRETE SPECIFICATION: NOMINAL AGGREGATE SIZE TO BE 20mm, SLUMP TO BE NOT GREATER THAN 80mm.
- C5 CONCRETE STRENGTH AND CLEAR CONCRETE COVER TO REINFORCEMENT SHALL BE IN ACCORDANCE WITH THE FOLLOWING TABLE U.N.O
- | | | | |
|--|----------|-----------|---------------------|
| | ELEMENT: | F’C (MPa) | REINFORCEMENT COVER |
| | PIERS | 25 | 75 MIN. |
| | SLAB | 25 | 50 MIN. |
- C6 ALL LAPS IN REINFORCEMENT SHALL BE AS SHOWN IN THE TABLE BELOW UNLESS NOTED OTHERWISE.
- | | | |
|--|------|-----------------|
| | BAR | LAP LENGTH (mm) |
| | N12 | 500 |
| | N16 | 650 |
| | MESH | 350 |
- C7 REINFORCEMENT SYMBOLS:
- | | |
|----|---|
| R | STRUCTURAL PLAIN ROUND GRADE 250R TO AS 4671. |
| N | DEFORMED BAR GRADE D500N TO AS 4671. |
| SL | HARD DRAWN STEEL REINFORCING FABRIC GRADE D500L TO AS 4671. |
- C8 SIZES OF CONCRETE ELEMENTS DO NOT INCLUDE THICKNESS OF APPLIED FINISHES.
- C9 NO HOLES, CHASES OR EMBEDMENT OF PIPES OTHER THAN THOSE SHOWN ON THE STRUCTURAL DRAWINGS SHALL BE MADE IN CONCRETE MEMBERS WITHOUT PRIOR APPROVAL BY THE SUPERINTENDENT.
- C10 ALL CONCRETE SHALL BE COMPACTED USING A MECHANICAL VIBRATION PROCESS.
- C11 ALL REINFORCEMENT SHALL BE SECURELY SUPPORTED IN ITS CORRECT POSITION DURING CONCRETING BY APPROVED BAR CHAIRS, SPACERS OR SUPPORT BARS.
- C12 CONSTRUCTION JOINTS SHALL BE PROPERLY FORMED AND USED ONLY WHERE SHOWN OR SPECIFICALLY APPROVED BY THE SUPERINTENDENT.

INSPECTION AND CERTIFICATION NOTES:


- A1 THE CONTRACTOR’S ENGINEER (RPEQ) SHALL UNDERTAKE INSPECTIONS DURING CONSTRUCTION TO ENSURE ALL CONSTRUCTION WORKS ARE IN ACCORDANCE WITH THE MOST CURRENT ISSUE OF THE STRUCTURAL DRAWINGS AND CONTRACT DOCUMENTS. THE RPEQ SHALL CERTIFY ALL CONSTRUCTION WORK (FORM 16). ANY ALTERNATIVE TECHNIQUE USED IN CONSTRUCTION SHALL BE FOLLOWED BY A DESIGN CERTIFICATE (FORM 15) BY THE CONTRACTOR’S PROFESSIONAL ENGINEER (RPEQ)

STEELWORK NOTES

- S1. ALL WORKMANSHIP & MATERIALS SHALL BE IN ACCORDANCE WITH AS4100 & AS/NZS1554.
- S2. ALL STEEL SHALL BE IN ACCORDANCE WITH:
AS1163 GRADE C350L0 FOR RECTANGULAR AND SQUARE HOLLOW SECTIONS U.N.O.
AS 3679 GRADE 300 FOR HOT ROLLED SECTIONS.
- S3. ALL BOLTS TO BE METRIC HEXAGONAL TO AS 1252 U.N.O.
ALL BOLTS TO BE M16 4.6/S TO AS/NZS 1252 U.N.O.
ALL BOLTS TO BE HOT DIP GALVANISED TO AS 1214 U.N.O.
- S4. ALL CLEATS AND GUSSETS SHALL BE 10mm PLATE TO AS/NZS3678 GRADE 250 U.N.O.
- S5. METAL ROOF CLADDING TO BE 0.42 BMT LYSAGHT CUSTOM ORB WITH A COLORBOND FINISH OR APPROVED EQUAL FIXED AS PER MANUFACTURER’S SPECIFICATIONS – COLORBOND COLOUR AS PER SPECIFICATION.
- S6. ALL WELDS TO BE 6mm CONTINUOUS FILLET WELDS (CFW) STRUCTURAL PURPOSE (SP) WELDS U.N.O. ALL WELDS TO BE MADE USING E48XX OR W50X GRADE 1 (OR BETTER) ELECTRODES TO AS/NZS 1554. GRIND ALL CORNERS & WELDS SMOOTH.
- S7. ALL STEELWORK TO BE HOT DIP GALVANISED IN ACCORDANCE WITH AS/NZS 2312 HDG600 SPECIFICATION. SURFACE PREPARATION FOR CORROSION PROTECTION COATING IS TO BE CLASS 2½ TO AS 1627 AND PICKLED PRIOR GALVANISING. HOT DIPPED GALVANISED COATING SHALL BE IN ACCORDANCE WITH AS/NZS 4680. THE PRINCIPAL CONTRACTOR SHALL CONFER WITH THE FABRICATOR AND GALVANISER TO ENSURE VENT HOLES ARE PROVIDED IN ACCORDANCE WITH AS/NZS 4680.
- S8. THE PRINCIPAL CONTRACTOR SHALL CONFER WITH THE FABRICATOR AND GALVANISER TO ENSURE VENT HOLES ARE PROVIDED IN ACCORDANCE WITH AS/NZS 4680.
- S9. ANY POST GALVANISING DAMAGE TO BE MADE GOOD WITH HIGH QUALITY TWO PACK EPOXY ZINC RICH PAINT CONFORMING TO AS/NZS 3750.9 WITH A MINIMUM DRY FILM THICKNESS OF 100 MICRONS. SURFACE PREPARATION TO BE ACCORDING TO PAINT MANUFACTURER’S RECOMMENDATIONS.
- S10. THE ENDS OF ALL TUBULAR OR HOLLOW MEMBERS ARE TO BE SEALED WITH 6mm THICK PLATES AND CONTINUOUS FILLET WELDED U.N.O.
- S11. PROTECTIVE COATINGS TO BE APPLIED AFTER ALL FABRICATION COMPLETED. NO WELDING ETC TO BE CARRIED OUT DURING OR AFTER APPLICATION OF COATING SYSTEM.


| STRUCTURAL DESIGN CERTIFICATION | | | | | | | | | |
|---|--|---|----------------------|--|--|--|--|-----------|--|
| DESIGN | | | DESIGN CHECK | | | AUTHORISED FOR ISSUE | | | |
| Lenita Mendis RPEQ:8950 2014.12.10 16:34:11+10'00' | | | R.Hu (RPEQ No 13885) | | | Bala Balakumar RPEQ 3963 2014.12.11 09:02:07+10'00' | | | |
| BRISBANE CITY COUNCIL STANDARD DRAWING | | | | | | | | | |
|  | | | | | | BUSHFIRE WATER SUPPLY SHELTER TYPE 2 – NATURAL AREA NOTES – SHEET 1 OF 3 | | SCALE | |
| | | | | | | | | AS SHOWN | |
| | | | | | | DWG No. | | BSD–10352 | |
| | | | | | | ORIGINAL SIZE | | REVISION | |
| A3 | | B | | | | | | | |

| | | | | | | | | | |
|-------|-----------------------|---------------|---------------|----------------|---|---------------------|--|------|---------|
| | | | | | DRAWING AUTHORISED FOR PUBLICATION | DESIGN | CPO – P&D | DATE | DEC '14 |
| | | | | | Inga Condric 2015.06.15 07:08:53+10'00' | DRAWN | CPO – P&D | DATE | DEC '14 |
| | | | | | for ASSET ENGINEERING MANAGER STRATEGIC ASSET MANAGEMENT | CHECKED | BI – FSG – AS | DATE | DEC '14 |
| B | Drawing Title Amended | FEB '16 | JUL '16 | JUL '16 | DESIGN APPROVED | DRAWING FILENAME | BSD-10352 (B) Bushfire water supply shelter type 2 - Natural area - Notes - Sheet 1 of 3.dwg | | |
| A | ORIGINAL ISSUE | DEC '14 | DEC '14 | DEC '14 | C.Wood | ASSOCIATED PLANS | BSD-10352-Sheets 2 & 3 | | |
| ISSUE | AMENDMENT | DRAWN DATE | CHK'D DATE | APPR'D DATE | SENIOR CO-ORDINATOR NATURAL ENVIRONMENT ASSET SERVICES/BRISBANE INFRASTRUCTURE | | | | |

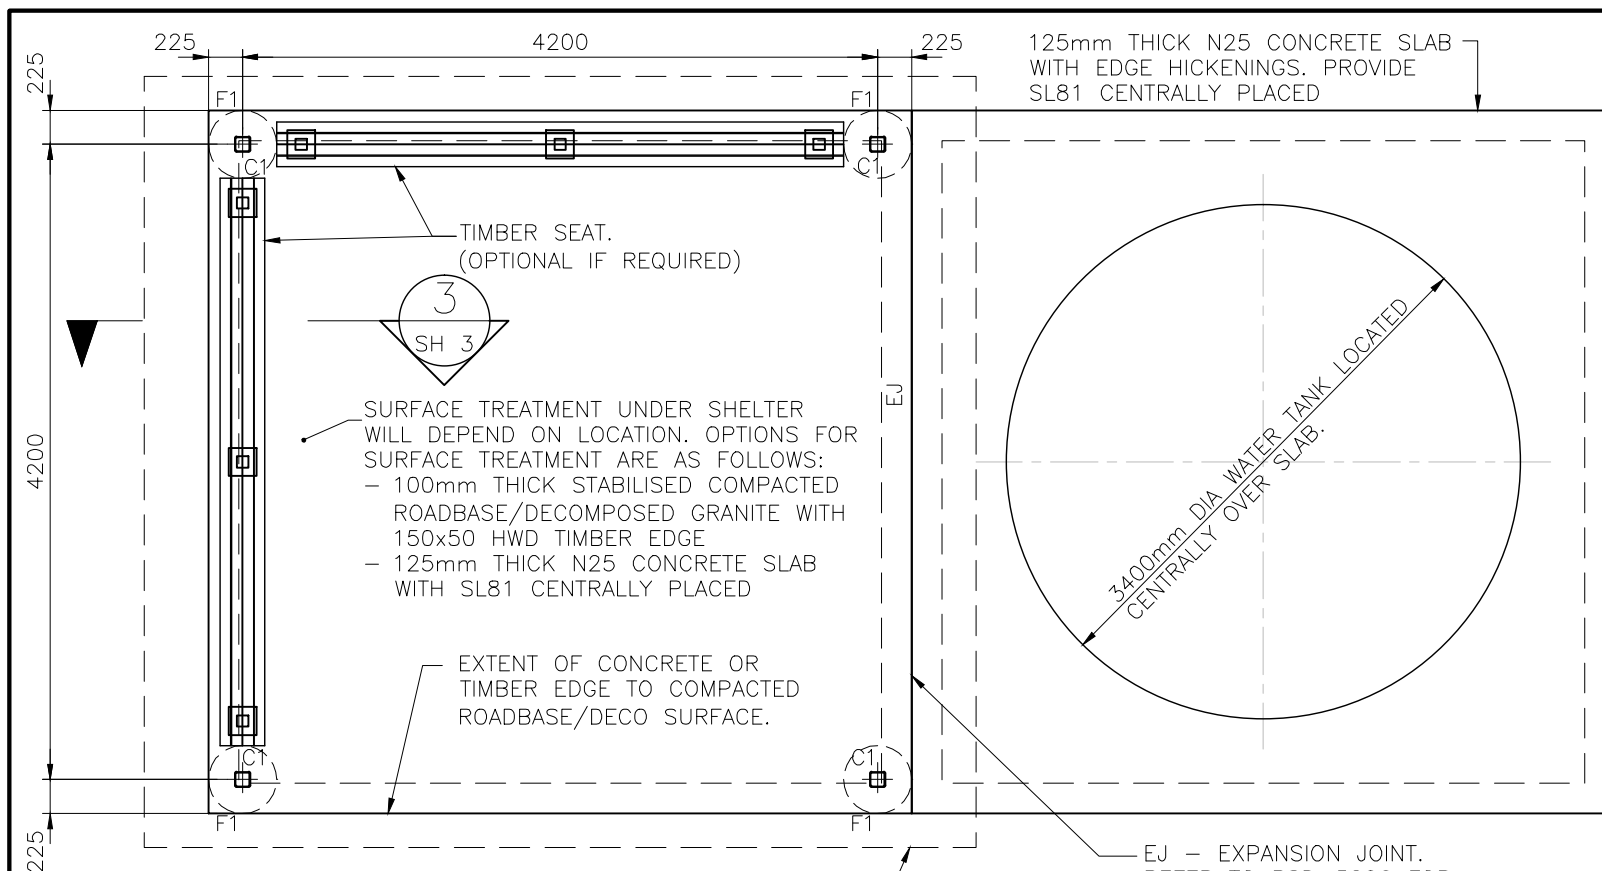

FLOOR PLAN

SCALE: 1:50

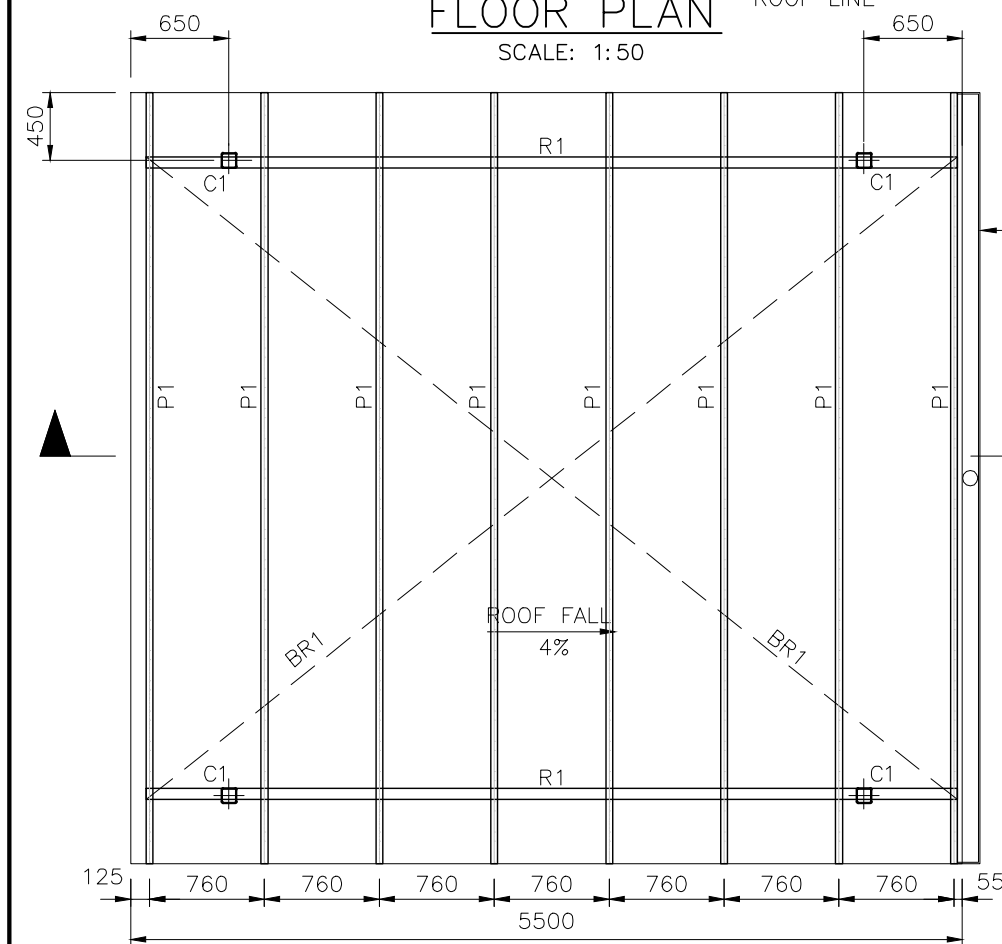


ROOF PLAN

SCALE: 1:50

| MEMBER SCHEDULE | | | |
|-----------------|-------------------------------------|---------------------------------|---|
| MARK | MEMBER | DESCRIPTION | COMMENTS |
| C1 | 100x5 SHS | POST | |
| R1 | 100x5 SHS | RAFTER | FIXED TO POST WITH 2xM16 BOLTS. 5mm END CAPS |
| P1 | 170x45 MGP12 SEASONED TIMBER | PURLIN | FIXED TO RAFTER WITH 2x M12 BOLTS. |
| BR1 | 30x1.0 GALVANISED STEEL STRAP BRACE | STRAP BRACING TO TOP OF PURLINS | 5/3.15Ø x 35mm NAILS AT EACH END OF STRAPPING FIXED TO SIDES OF SHELTER PURLINS AND ONE NAIL TO TOP OF EACH PURLIN. |
| F1 | 450Øx1500 DEEP | PIER FOOTING | N25 CONCRETE. |

IF OPTIONAL HORSE HITCHING RAIL IS REQUIRED, REFER TO BSD - 5003 FOR DETAILS. ENSURE HITCHING RAIL IS LOCATED ON HIGH SIDE OF SHELTER ROOF. MIN 1500mm AWAY.

CUSTOM ORB ROOFING OR APPROVED EQUAL FIXED IN ACCORDANCE TO MANUFACTURERS SPECIFICATIONS.

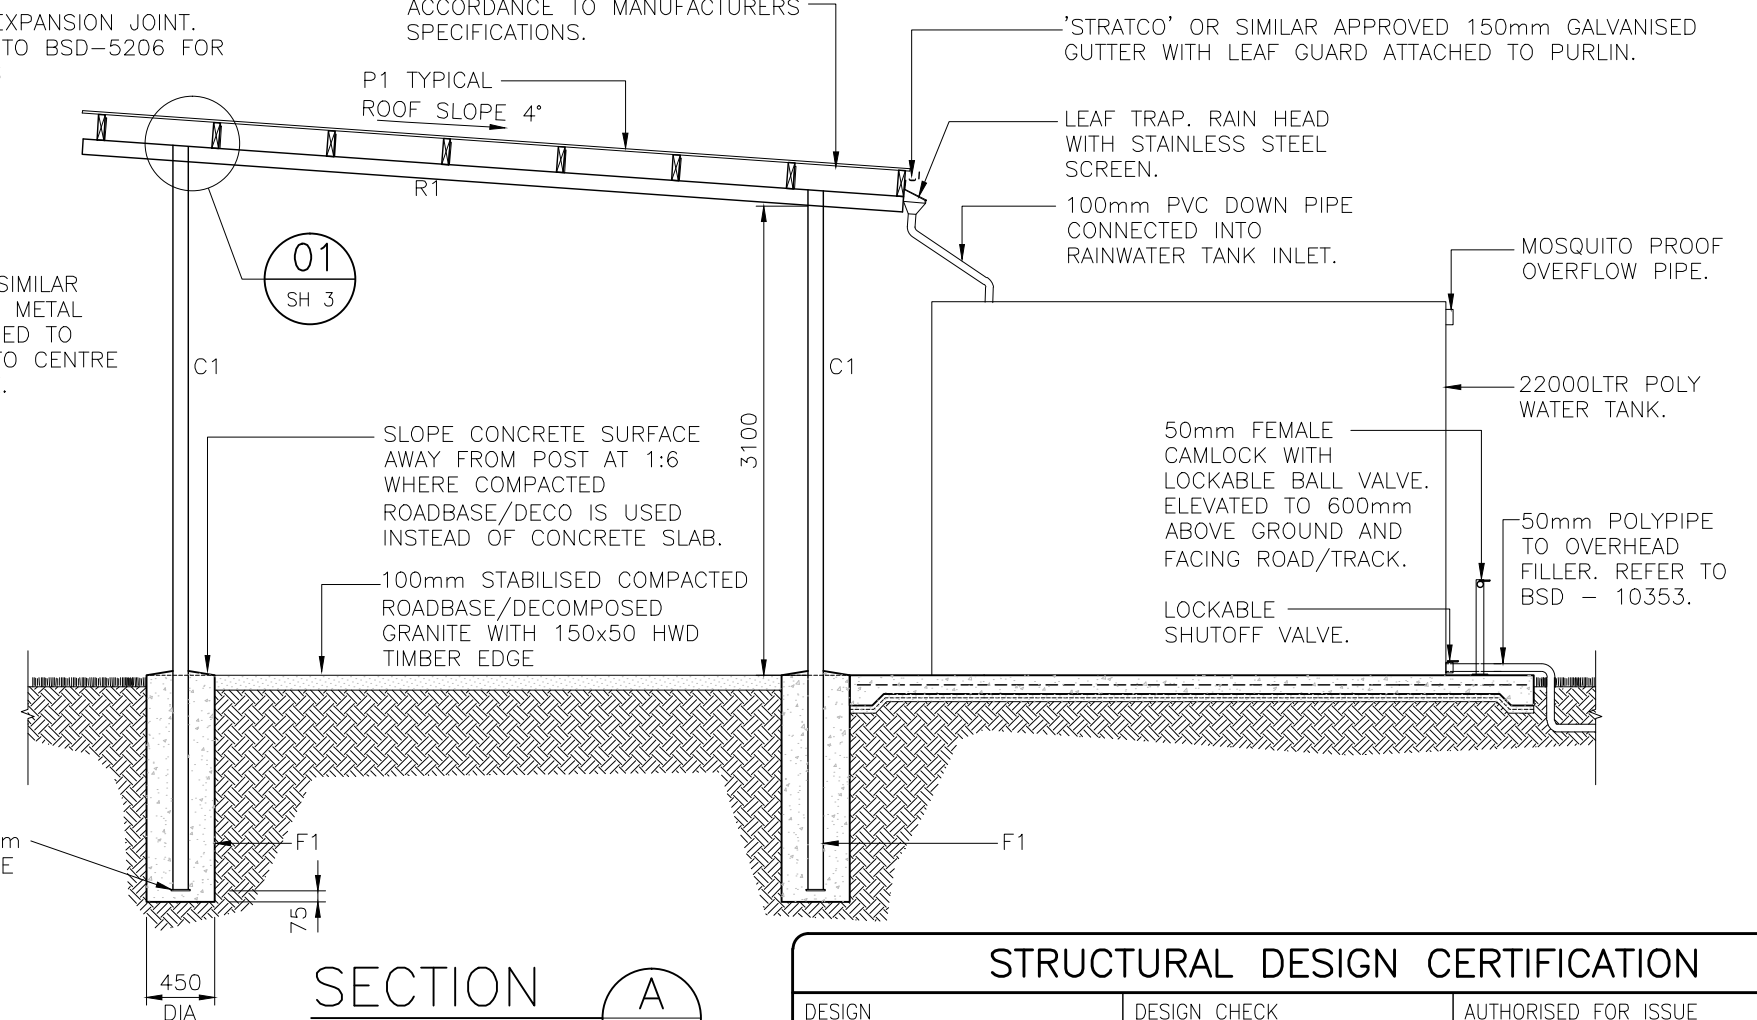

SECTION A-A

SCALE 1:50

STRUCTURAL DESIGN CERTIFICATION


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| BRISBANE CITY COUNCIL STANDARD DRAWING | |
|---|------------|
| BUSHFIRE WATER SUPPLY SHELTER TYPE 2 - NATURAL AREA PLAN - SHEET 2 OF 3 | |
| SCALE AS SHOWN | |
| DWG No. BSD-10352 | |
| ORIGINAL SIZE A3 | REVISION B |


| ISSUE | AMENDMENT | DRAWN DATE | CHK'D DATE | APPR'D DATE |
|-------|-----------------------|------------|------------|-------------|
| B | Drawing Title Amended | FEB '16 | JUL '16 | JUL '16 |
| A | ORIGINAL ISSUE | DEC '14 | DEC '14 | DEC '14 |

| DRAWING AUTHORISED FOR PUBLICATION | | | |
|---|------------------|--|--------------|
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| for ASSET ENGINEERING MANAGER STRATEGIC ASSET MANAGEMENT | DRAWN | CP0 - P&D | DATE DEC '14 |
| DESIGN APPROVED | CHECKED | BI - FSG - AS | DATE DEC '14 |
| C.Wood | DRAWING FILENAME | BSD-10352 BI Bushfire water supply shelter type 2 - Natural area - Plan - Sheet 2 of 3.dwg | |
| SENIOR CO-ORDINATOR NATURAL ENVIRONMENT ASSET SERVICES/BRISBANE INFRASTRUCTURE | ASSOCIATED PLANS | BSD-10352-Sheets 1 & 3 | |



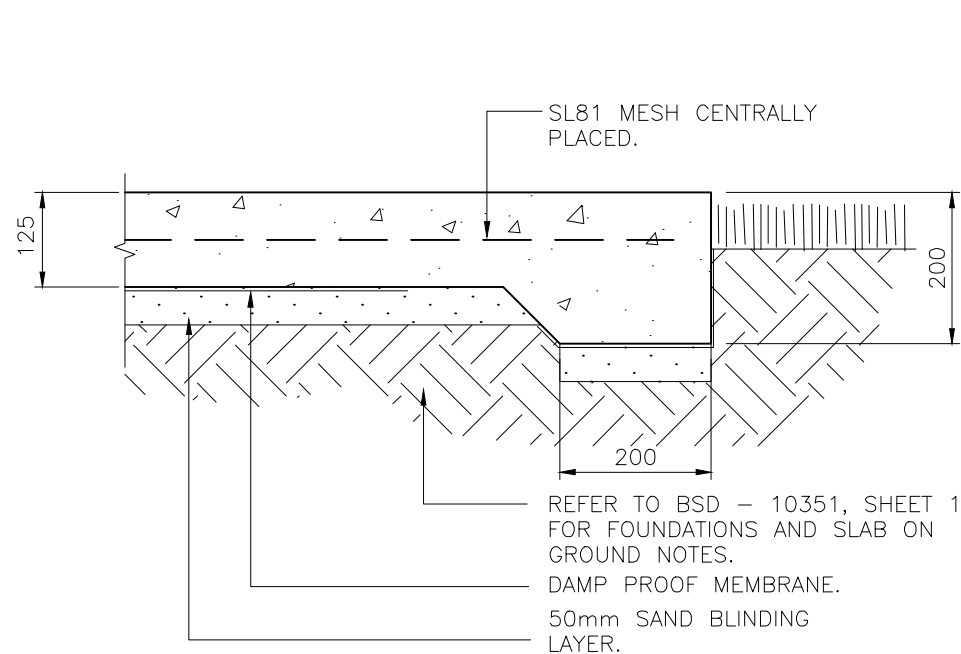


TYPICAL SLAB EDGE THICKENING DETAIL
SCALE: 1:10

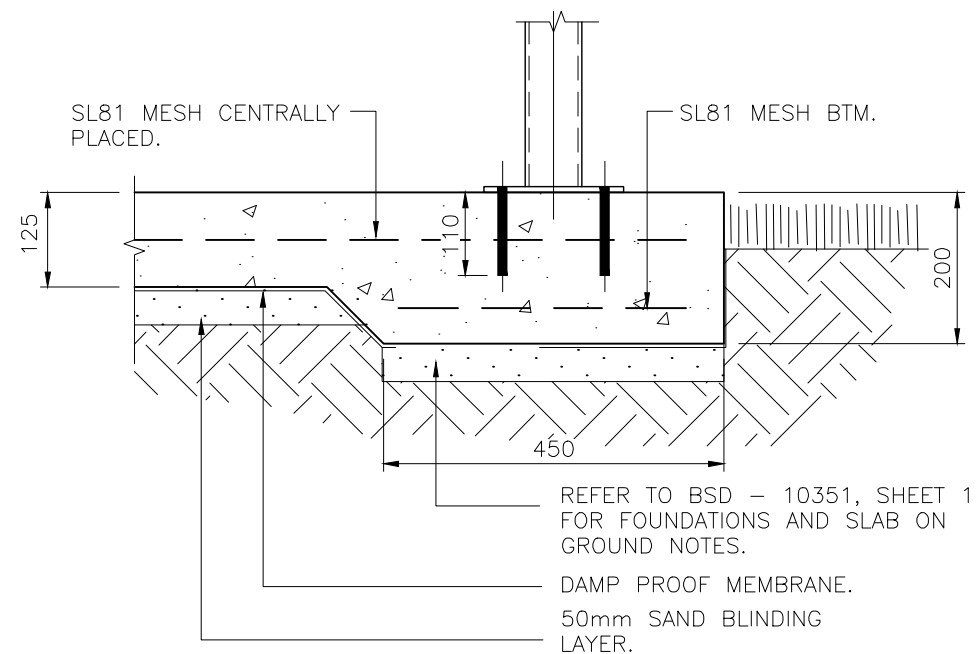


SLAB EDGE THICKENING DETAIL WHERE SEAT IS TO BE INSTALLED ON CONCRETE SLAB


SECTION 3
SCALE 1:10
SH 2

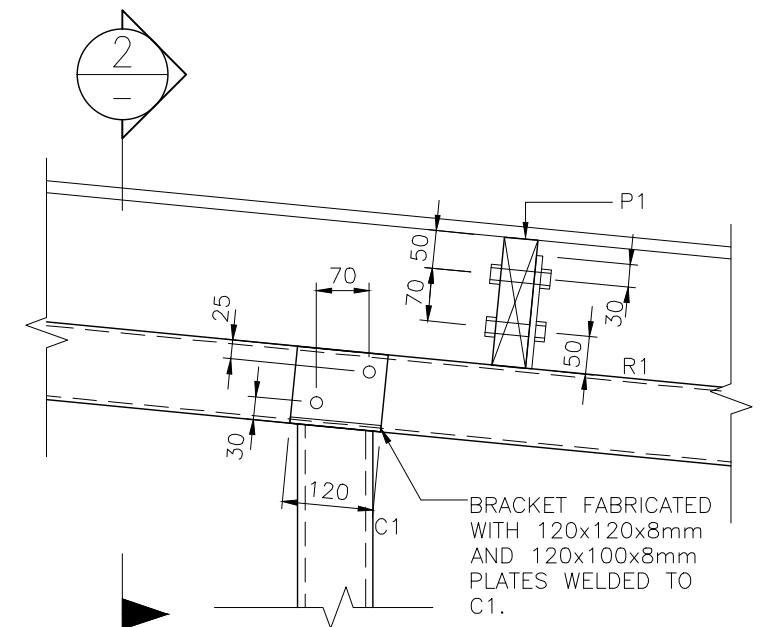


DETAIL 1
SCALE 1:10
SH 2

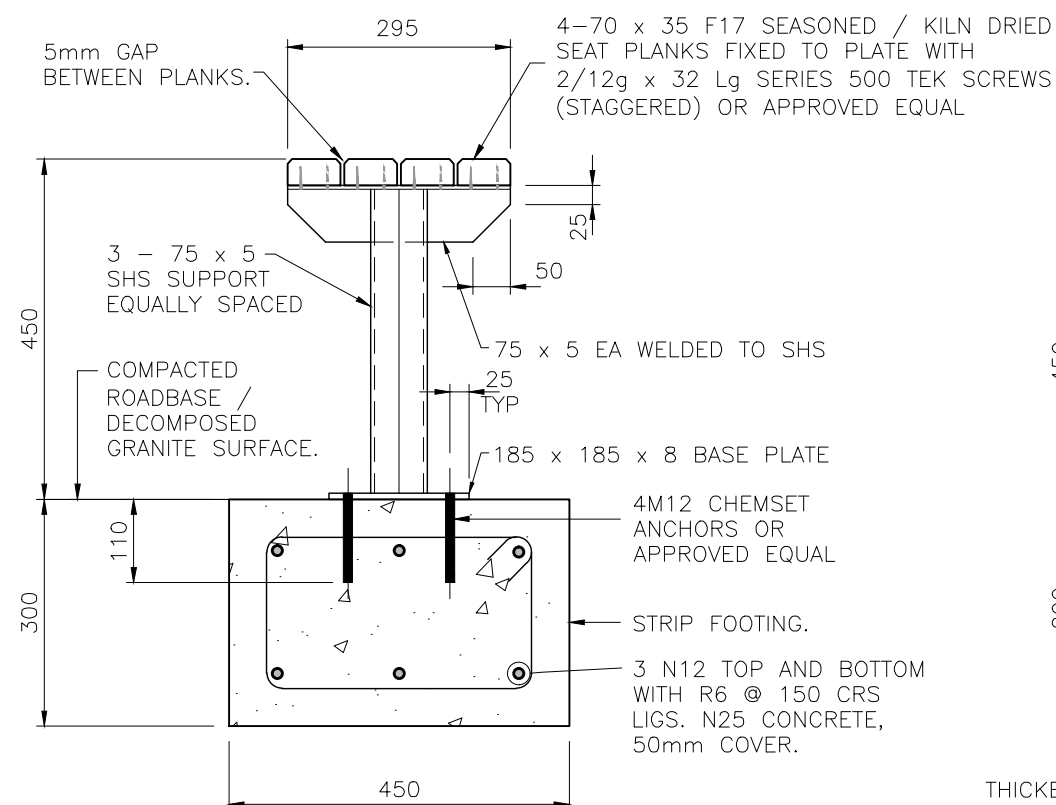

SEATING WHERE ON COMPACTED ROADBASE/DECOMPOSED GRANITE
SCALE: 1:10

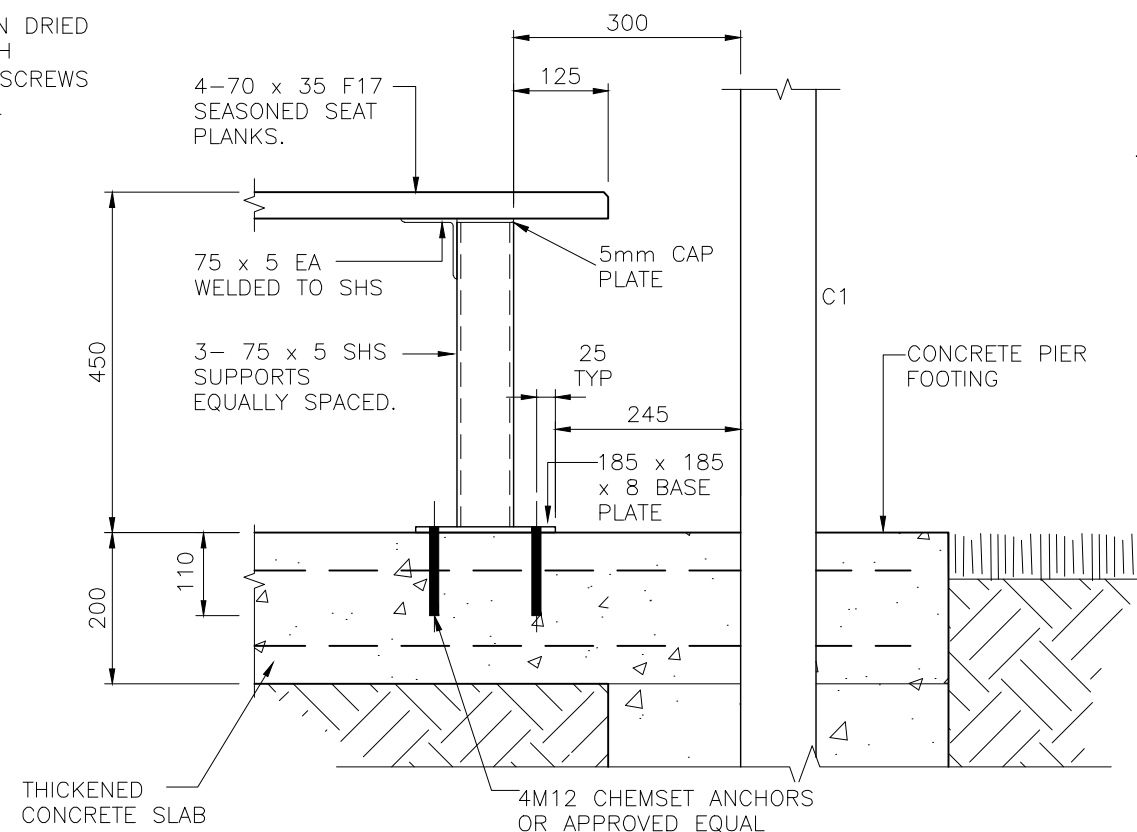


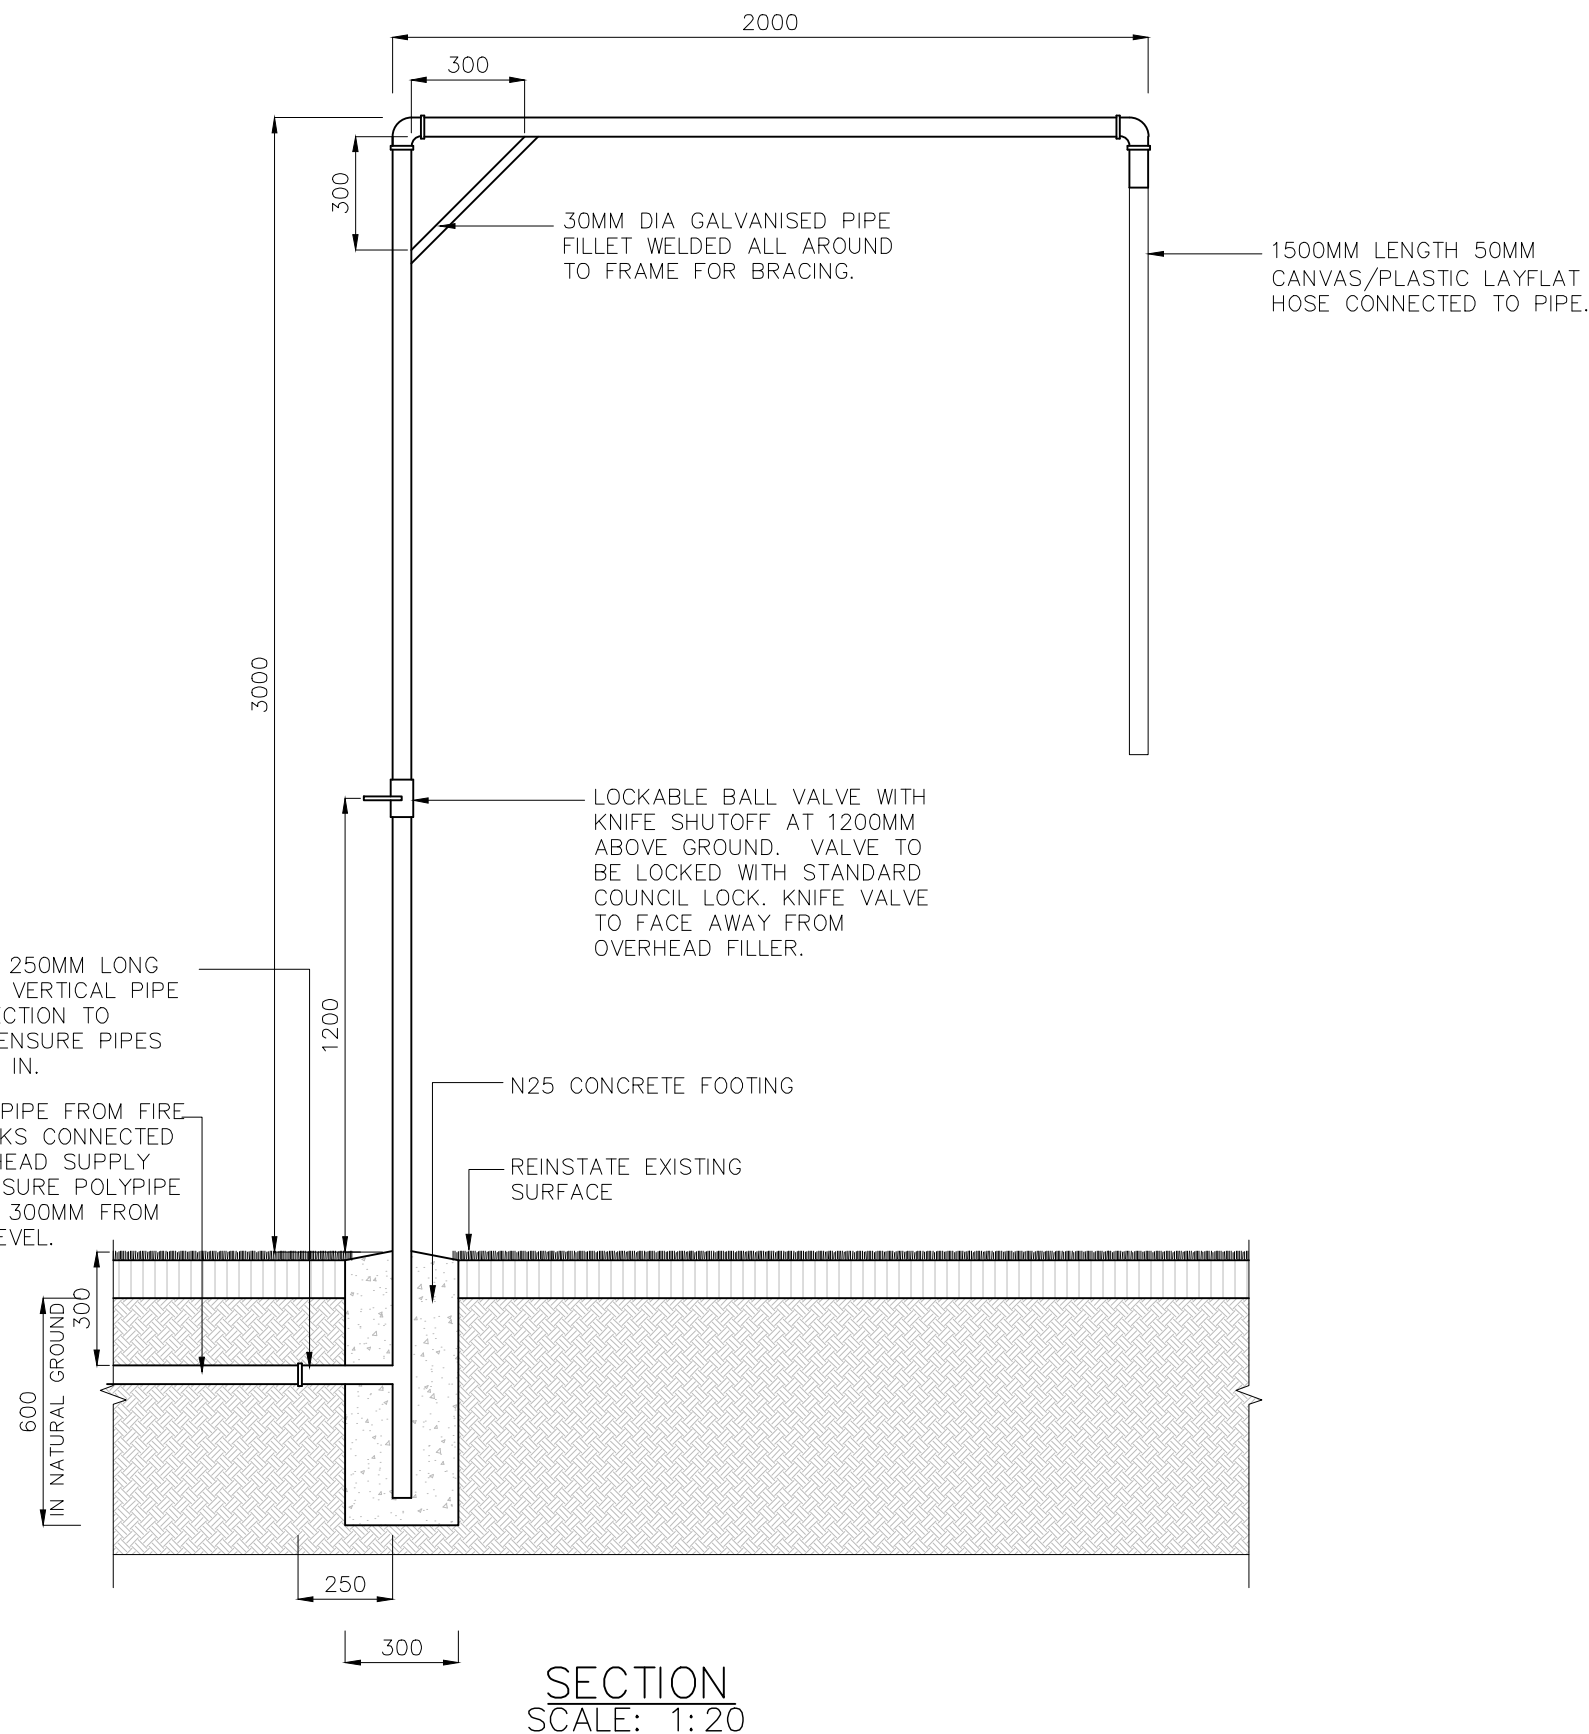
SEATING ON CONCRETE SLAB
SCALE: 1:10

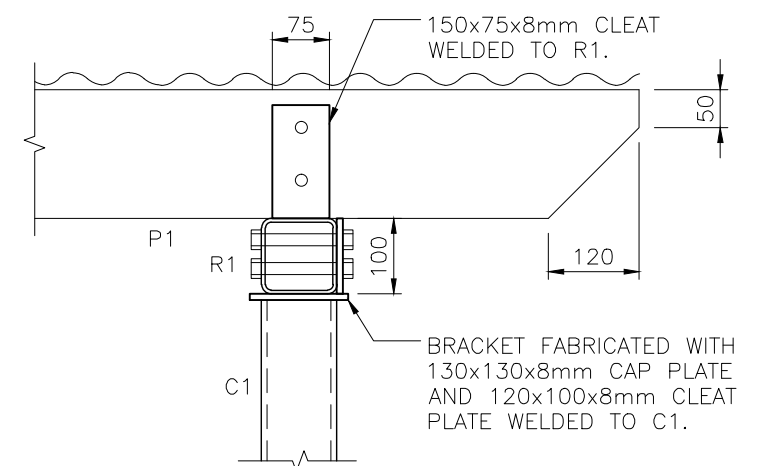

SECTION 2
SCALE 1:10

| STRUCTURAL DESIGN CERTIFICATION | | | |
|--|--|--|--|
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| BRISBANE CITY COUNCIL STANDARD DRAWING | | | |
| BUSHFIRE WATER SUPPLY SHELTER TYPE 2 – NATURAL AREA DETAILS – SHEET 3 OF 3 | | SCALE AS SHOWN | |
| | | DWG No. BSD–10352 | |
| | | ORIGINAL SIZE A3 | REVISION B |

| | | | | | | | | | | |
|-------|-----------------------|---------------|---------------|----------------|---|---------------------|--|------|---------|--|
| | | | | | <div>DRAWING AUTHORISED FOR PUBLICATION</div> <div>Inga Condric 2015.06.15 07:11:55+10'00"</div> <div>for ASSET ENGINEERING MANAGER STRATEGIC ASSET MANAGEMENT</div> <div>DESIGN APPROVED</div> <div>C.Wood</div> <div>SENIOR CO-ORDINATOR NATURAL ENVIRONMENT ASSET SERVICES/BRISBANE INFRASTRUCTURE</div> | DESIGN | CPO – P&D | DATE | DEC '14 |  <div>BRISBANE CITY</div> |
| | | | | | | DRAWN | CPO – P&D | DATE | DEC '14 | |
| | | | | | | CHECKED | BI – FSG – AS | DATE | DEC '14 | |
| B | Drawing Title Amended | FEB '16 | JUL '16 | JUL '16 | | DRAWING FILENAME | BSD-10352 (B) Bushfire water supply shelter type 2 - Natural area - Details - Sheet 3 of 3.dwg | | | |
| A | ORIGINAL ISSUE | DEC '14 | DEC '14 | DEC '14 | | ASSOCIATED PLANS | BSD-10352-Sheets 1 & 2 | | | |
| ISSUE | AMENDMENT | DRAWN DATE | CHK'D DATE | APPR'D DATE | | | | | | |




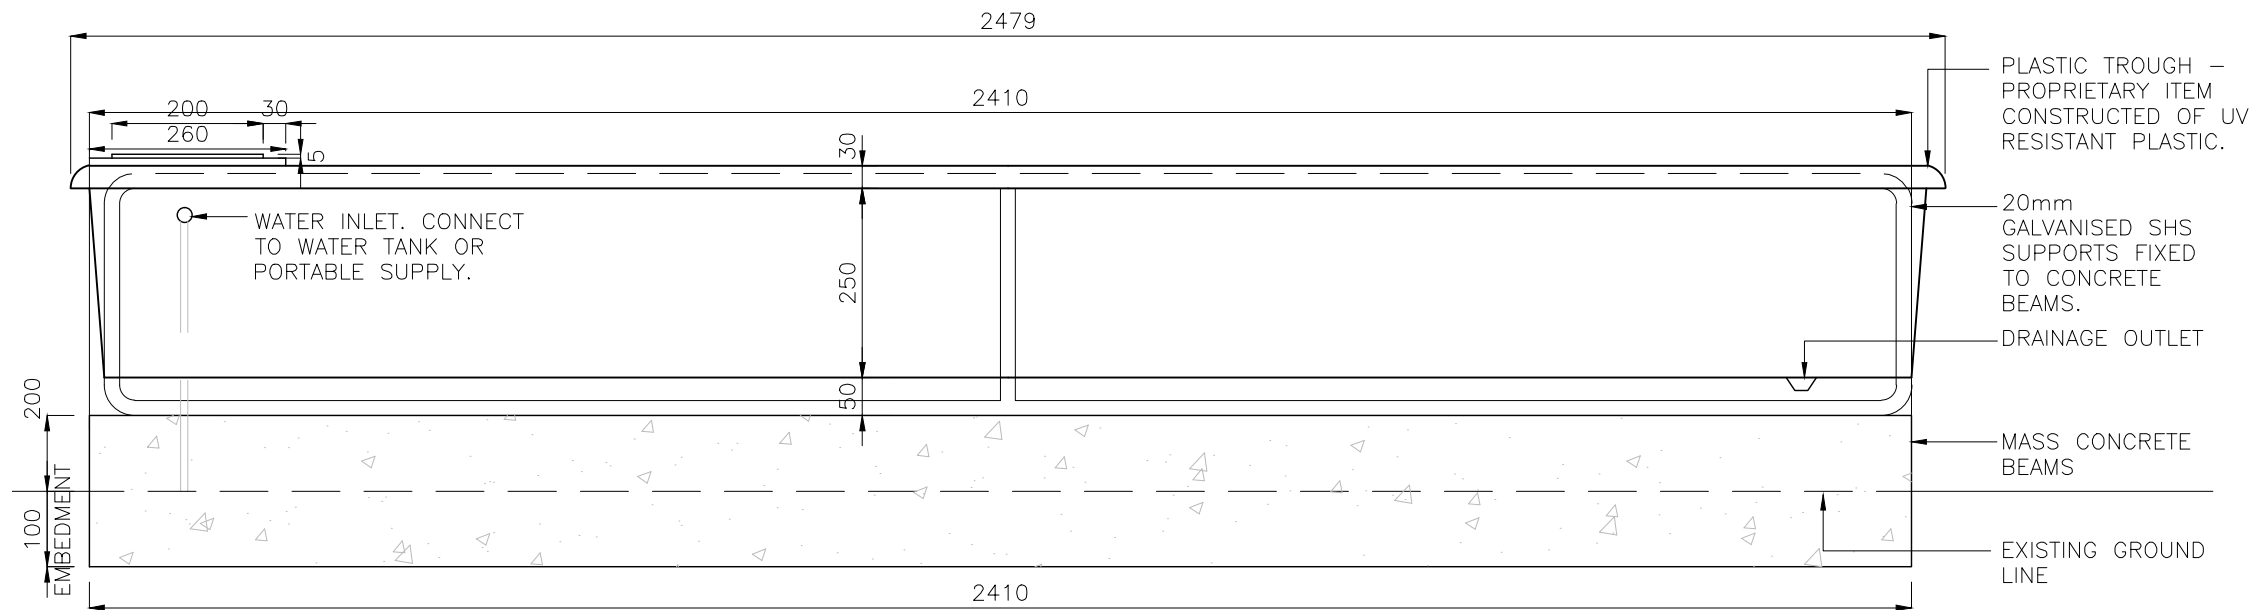
GENERAL NOTES

- ENSURE THAT WORK IS IN ACCORDANCE WITH BRISBANE CITY COUNCIL ENVIRONMENTAL BEST PRACTICE NOTES.
- SITE SETOUT TO BE VERIFIED BY SUPERINTENDENT PRIOR TO THE COMMENCEMENT OF CONSTRUCTION WORKS.
- VERIFY LOCATION OF ALL SERVICES AND EASEMENTS PRIOR TO THE COMMENCEMENT OF WORKS.
- WRITTEN DIMENSIONS TAKE PRECEDENCE OVER SCALED DISTANCES.
- VERIFY ALL DIMENSIONS ON SITE PRIOR TO CONSTRUCTION.
- STRUCTURES HAVE BEEN DESIGNED ON THE ASSUMPTION THAT THE MINIMUM ALLOWABLE BEARING CAPACITY FOR SOIL IS 100KPA AND TERRAIN CATEGORY = 2.5.
- IN EACH CASE ENGINEERING CERTIFICATION AND MODIFICATION AS NECESSARY WILL BE REQUIRED FOR PARTICULAR SOIL AND SITE CONDITIONS.
- THE COPYRIGHT OF THIS DRAWING REMAINS THE PROPERTY OF THE BRISBANE CITY COUNCIL.
- DIMENSIONS IN MILLIMETRES (UNO).


FITTINGS/FINISHES

1. WHERE STANDARD IS FOR USE IN A NON-MARINE ENVIRONMENT (UP TO 1KM FROM THE FORESHORE), THE FOLLOWING PROTECTION TREATMENT IS REQUIRED:
 - HOT DIP GALVANISING: FERROUS OPEN SECTIONS TO AS4791;
 - FERROUS HOLLOW SECTIONS TO AS4792.
2. WHERE STANDARD IS REQUIRED FOR USE WITHIN MARINE ENVIRONMENT, THE FOLLOWING PROTECTION TREATMENT IS REQUIRED:
 - STEELWORK HOT DIP GALVANISING: 85 MICRONS (600G/M²) MIN;
 - SWEEP ABRASIVE BLAST;
 - STEELWORK FIRST COAT: EPOXY PRIMER 75 MICRONS MIN;
 - STEELWORK SECOND COAT: TWO PACK ACRYLIC OR POLYURETHANE GLOSS 75 MICRONS MIN;
3. PAINT SYSTEMS TO BE IN ACCORDANCE WITH AS2312 AND IS DESIGNATED HDG600P6 AND HDG600P
4. ALL POSTS TO BE 50 NB GALVANISED STEEL TUBE TO AS/NZ1163.
5. ALL JOINTS TO BE FULLY WELDED. WELDS TO BE 5 THICK C.F.W (CONTINUOUS FILLET WELDS) TO AS554.1 WITH COLD GALVANISING TREATMENT TO COMPLETED WELDS.
6. PREFERRED COLD GALVANISING TREATMENT FOR IN-SITU WELDS, CUT ENDS OR OTHER BARE STEEL IS TO APPLY 2 COATS OF INORGANIC ZINC PRIMER APPLIED BY BRUSH.


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| | | | | | DRAWING AUTHORISED FOR PUBLICATION | DESIGN | CP0 - P&D | DATE | DEC '14 |  | BRISBANE CITY COUNCIL STANDARD DRAWING | | |
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| | | | | | for ASSET ENGINEERING MANAGER STRATEGIC ASSET MANAGEMENT | CHECKED | BI - FSG - AS | DATE | DEC '14 | | BUSHFIRE WATER SUPPLY SHELTER | | |
| | | | | | DESIGN APPROVED | DRAWING FILENAME | BSD-10353 (A) Bushfire water supply shelter - Natural area - Overhead filler.dwg | | | | BSD-10353 | | |
| | | | | | C.Wood | ASSOCIATED PLANS | | | | | ORIGINAL SIZE | REVISION | |
| A | ORIGINAL ISSUE | DEC '14 | DEC '14 | DEC '14 | SENIOR CO-ORDINATOR NATURAL ENVIRONMENT ASSET SERVICES/BRISBANE INFRASTRUCTURE | | | | | | A3 | A | |
| ISSUE | AMENDMENT | DRAWN DATE | CHK'D DATE | APPR'D DATE | | | | | | | | | |



SIDE ELEVATION
SCALE: 1:10

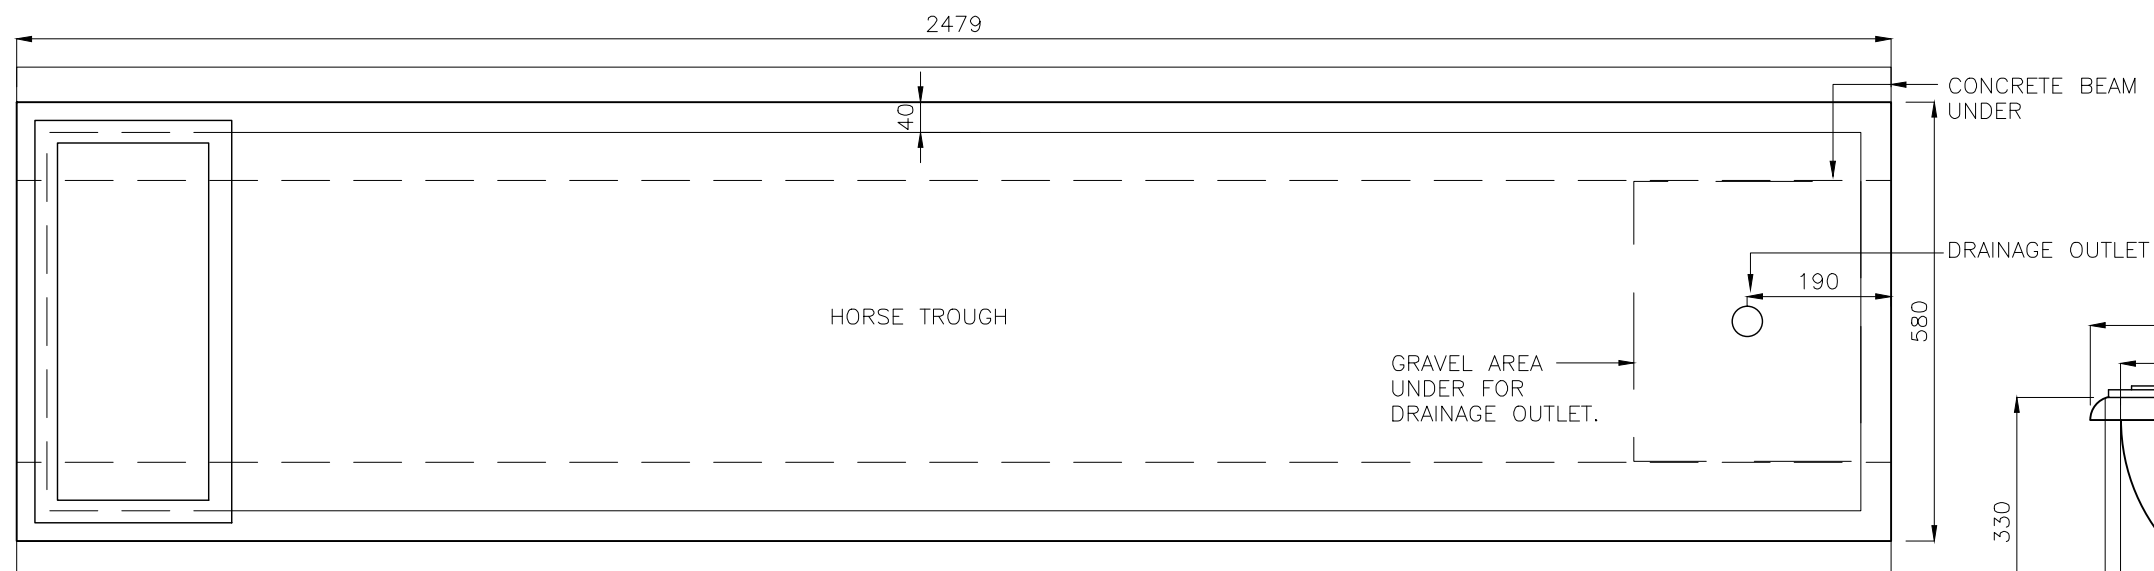


PLAN
SCALE: 1:10

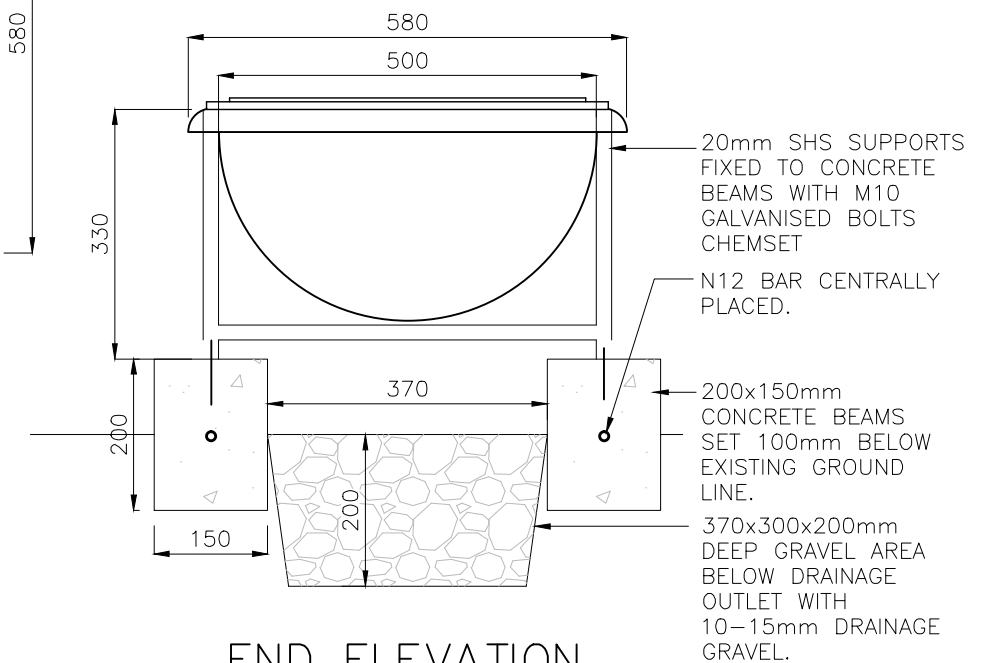

END ELEVATION
SCALE: 1:10

NOTES

- ENSURE THAT WORK IS IN ACCORDANCE WITH BRISBANE CITY COUNCIL ENVIRONMENTAL BEST PRACTICE NOTES.
- SITE SETOUT TO BE VERIFIED BY SUPERINTENDENT OR LANDSCAPE ARCHITECT PRIOR TO THE COMMENCEMENT OF CONSTRUCTION WORKS.
- VERIFY LOCATION OF ALL SERVICES AND EASEMENTS PRIOR TO THE COMMENCEMENT OF WORKS.
- WRITTEN DIMENSIONS TAKE PRECEDENCE OVER SCALED DISTANCES.
- VERIFY ALL DIMENSIONS ON SITE PRIOR TO CONSTRUCTION.
- STRUCTURES HAVE BEEN DESIGNED FOR STANDARD SOIL AND TERRAIN CATEGORY CONDITIONS. TERRAIN CATEGORY = 2.5 AND MINIMUM ALLOWABLE BEARING CAPACITY = 100KPA.
- IN EACH CASE ENGINEERING CERTIFICATION AND MODIFICATION AS NECESSARY WILL BE REQUIRED FOR PARTICULAR SOIL AND SITE CONDITIONS.
- THE COPYRIGHT OF THIS DRAWING REMAINS THE PROPERTY OF THE BRISBANE CITY COUNCIL.
- REFER TO B.05 FOR GENERAL STRUCTURAL NOTES.

| | | | | | | | | | | |
|-------|----------------|-------------------|---------------|-----------------------------|---|---|-----------------|---|---|--|
| | | | | | DRAWING AUTHORISED FOR PUBLICATION Inga Condric 2015.06.15 07:14:25+10'00' for ASSET ENGINEERING MANAGER STRATEGIC ASSET MANAGEMENT DESIGN APPROVED C.Wood SENIOR CO-ORDINATOR NATURAL ENVIRONMENT ASSET SERVICES/BRISBANE INFRASTRUCTURE | DESIGN CPO - P&D | DATE DEC '14 |  | BRISBANE CITY COUNCIL STANDARD DRAWING | |
| | | | | | | DRAWN CPO - P&D | DATE DEC '14 | | | |
| | | | | | | CHECKED BI - FSG - AS | DATE DEC '14 | | | |
| | | | | | | DRAWING FILENAME BSD-10360 (A) Horse trough - Natural area - Plan and notes.dwg | | | | |
| A | ORIGINAL ISSUE | DEC '14 | DEC '14 | DEC '14 | | | | | HORSE TROUGH NATURAL AREA PLAN AND NOTES | |
| ISSUE | AMENDMENT | DRAWN DATE | CHK'D DATE | APPR'D DATE | | | | | | |
| | | SCALE AS SHOWN | | DWG No. BSD-10360 | | ORIGINAL SIZE A3 | | REVISION A | | |

SITING NOTES

LOCATED WHERE DEMOGRAPHICS INDICATE A HIGH PROPORTION OF YOUNG CHILDREN, WITHIN 500m WALKING DISTANCE OF RESIDENCES AND WITHOUT MAJOR OBSTACLES E.G. A MAJOR ROAD.

USUALLY SITED IN LOCAL AND DISTRICT INFORMAL USE PARKS AND LESS COMMONLY IN SPORTS PARKS. AVOID SMALL "POCKET PARKS".

AVOID NOISE, AIR POLLUTION AND CONSIDER CLIMATE E.G. WIND. SHADE.

CONSIDER AMENITY OF LOCAL RESIDENTS AND PROVIDE GOOD ACCESSIBILITY TO THE PLAYGROUND.

MAXIMISE OPPORTUNITIES FOR CASUAL SURVEILLANCE FROM ACTIVITY SPACES, CAR PARKS, SEATING, PARK NEIGHBOURS AND/OR SURROUNDING STREETS.

PROVIDE PLAY EXPERIENCES TO COMPLEMENT AND ENHANCE OTHER RECREATION OPPORTUNITIES IN A PARK.

SETBACK PLAYGROUND FROM MAJOR ROADS, DRAINS, COMMUTER BIKEWAYS ETC. OR CONSTRUCT SAFETY FENCING TO MANAGE THE RISK.

PROVIDE FOR CHILDREN WITH SPECIAL NEEDS WHERE POSSIBLE.

WATER PLAY ELEMENTS ARE NOT NORMALLY INCLUDED IN LOCAL PLAYGROUNDS. IF PROVIDED, WATER PLAY TO CONSIDER SAFETY AND SUSTAINABLE WATER USE.

PROVIDE PLAY ELEMENTS IN NODES, CLUSTERED ACCORDING TO AGE GROUP.


CHECK ADJACENT PARKS TO DETERMINE WHAT AGE GROUP EXISTING PLAYGROUNDS ARE FOCUSED AT, AND DESIGN FOR A DIFFERENT GROUP.

COMBINE LANDSCAPING WITH CONSTRUCTED PLAY ELEMENTS E.G. MOUNDING, PLANTING, ETC.



MIN. 2500mm CIRCULATION SPACE AROUND PERIMETER OF PLAYGROUND

PLAY EQUIPMENT TO PROVIDE FOR A RANGE OF DEVELOPMENT SKILLS FROM TODDLER TO PRIMARY SCHOOL AGE. THE AGE RANGES CAN BE CHANGED WHERE DEMOGRAPHICS INDICATE OTHER NEEDS.

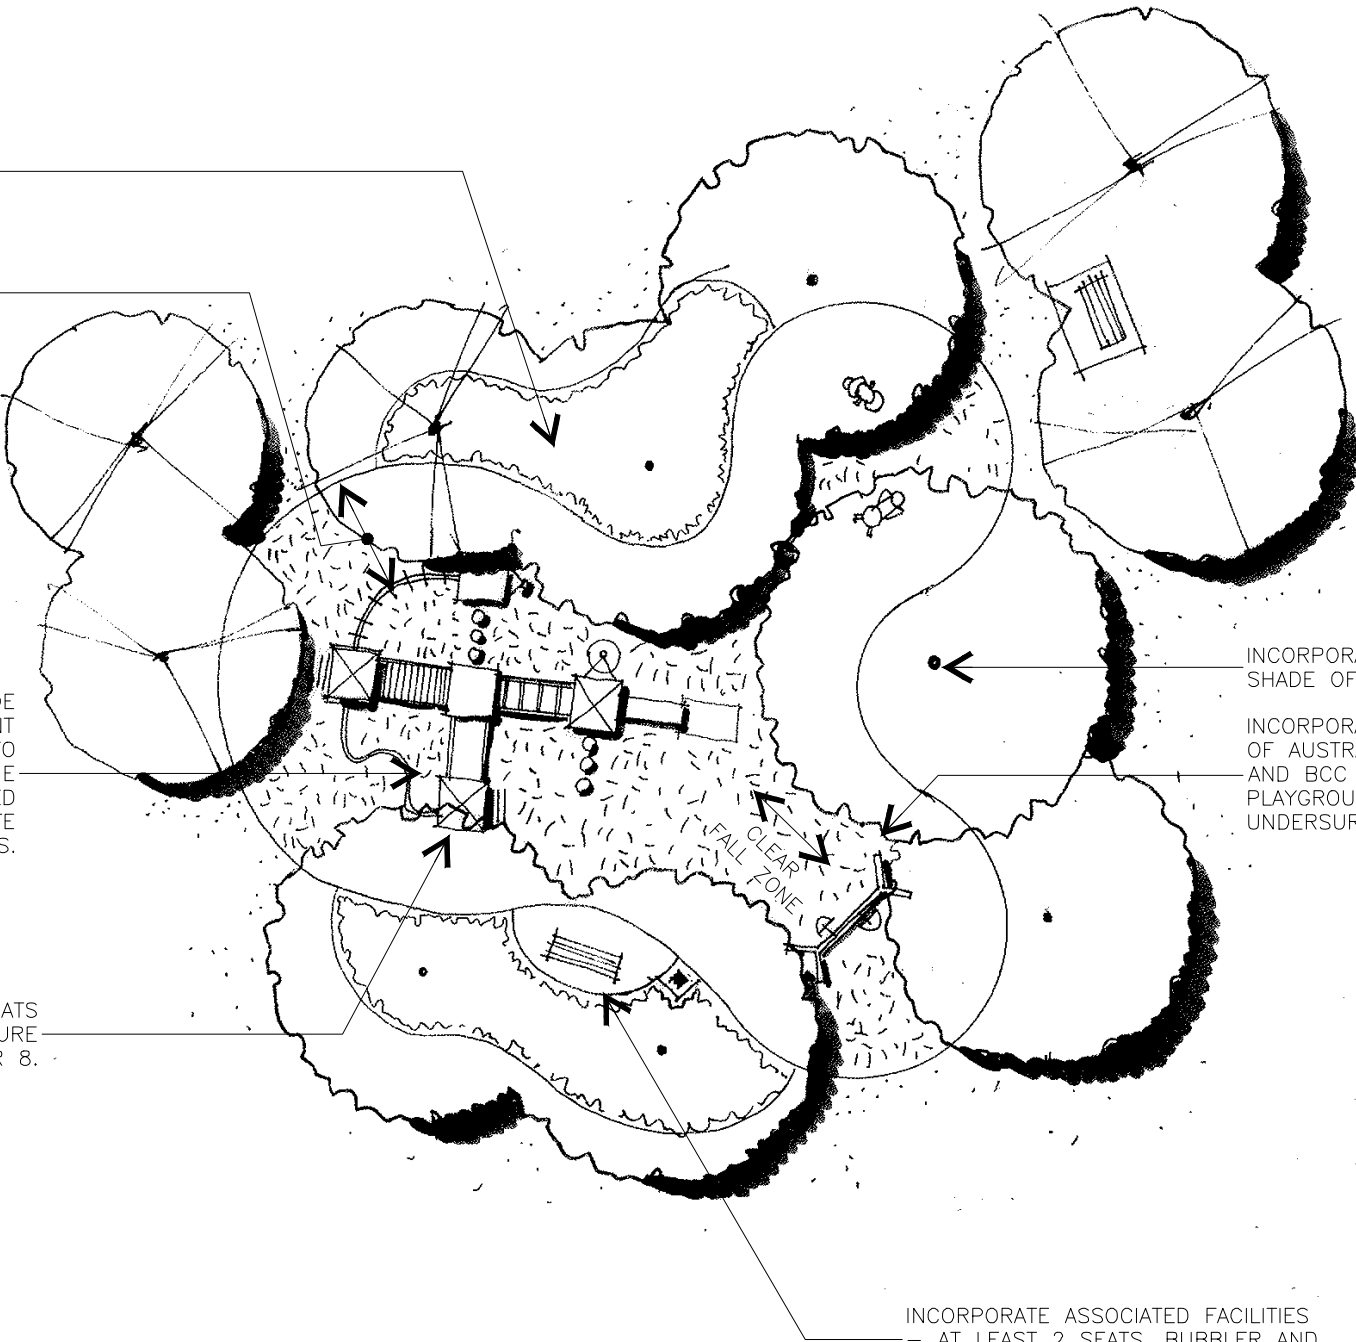UNDERSURFACING AND WEARMATS TO COMPLY WITH INFRASTRUCTURE GUIDELINES PARKS CHAPTER 8.





PLAYGROUND SITING – PLAN
NOT TO SCALE

| | | | | | | | | | | | | |
|-------|--|------------|------------|-------------|--|------------------|---|------|---------|---|--|----------|
| | | | | | <div>DRAWING AUTHORISED FOR PUBLICATION PAUL COTTON SIGNATURE ON ORIGINAL DATED 03/09/14 ----- ASSET ENGINEERING MANAGER STRATEGIC ASSET MANAGEMENT DESIGN APPROVED LAUREN TEMPLEMAN SIGNATURE ON ORIGINAL DATED 31/08/04 ----- PRICIPAL PROGRAM OFFICER PARKS</div> | DESIGN | Std Dwgs WG | DATE | OCT '13 |  | BRISBANE CITY COUNCIL STANDARD DRAWING | |
| | | | | | | DRAWN | CP0 - P&D | DATE | OCT '13 | | SCALE NOT TO SCALE | |
| | | | | | | CHECKED | UMD_E&P & IMB | DATE | OCT '13 | | LOCAL PLAYGROUNDS SITING PLAN | |
| | | | | | | DRAWING FILENAME | BSD-10401 (B) Local playgrounds - Siting plan.dwg | | | | DWG No. BSD-10401 | |
| B | Drawing Title Amended | FEB '16 | JUL '16 | JUL '16 | | ASSOCIATED PLANS | SUPERSEDES UMS-753 | | |  | ORIGINAL SIZE | REVISION |
| A | Drawing Converted from UMS Series April 2014 | APR '14 | APR '14 | APR '14 | | | | | | | | A3 |
| ISSUE | AMENDMENT | DRAWN DATE | CHK'D DATE | APPR'D DATE | | | | | | | | |

DESIGN PRINCIPLES

THE FOLLOWING DESIGN PRINCIPLES SHOULD BE FOLLOWED:

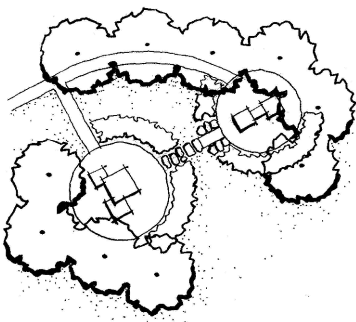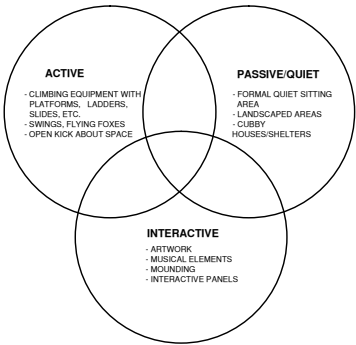

1 PROVIDE A VARIETY OF ELEMENTS TO ACCOMMODATE A NUMBER OF PLAY FORMS (ACTIVE TO FOCUSED), AND A WIDE RANGE OF DEVELOPMENT SKILLS

2 PROVIDE LINKAGES BETWEEN THE ELEMENTS AND FLOW THROUGH AND AROUND THEM TO INCREASE OPTIONS FOR USE.

3 ENSURE THAT EACH ELEMENT CAN BE USED IN SEVERAL WAYS, ALTERING AS THE SKILL LEVEL DEVELOPS

E.G. FISH AT OCTOPUS GARDEN, COLMSLIE BEACH RESERVE

4 ENSURE SAFETY WITHOUT SACRIFICING PLAY (COMPLY WITH AUSTRALIAN STANDARDS, PROVIDE SHADE)

E.G. CLIMBING NET & UNDERSURFACING AREA AT ROCKS RIVERSIDE PARK.



5 INCORPORATE ART TO COMBINE IMAGINATIVE AND PHYSICAL PLAY

E.G. ARTWORK & PLAY MOUNDS AT EINBUNPIN PARK.

6 PROVIDE SHAPES, VARIED TEXTURAL SURFACES, COLOUR AND PLANTING TO ADD LAYERS OF SENSORY DETAIL AND AN EXCITING COMPLEXITY.

E.G. CORRUGATED FORMED PATHWAY AT ORLEIGH PARK.



7 ENSURE STRONG TIES WITH THE LOCAL COMMUNITY THROUGH INTEGRATION IN THE CONCEPT, IMPLEMENTATION OF PLAYGROUND OR REFERENCING TO HISTORY.

E.G. RAVEN STREET RESERVE PLAYGROUND REFLECTING THE NATURAL ENVIRONMENT CHARACTER OF THE SITE.



8 ACHIEVE A BALANCE BETWEEN PARENTAL SUPERVISION AND INDEPENDENT PLAY.

E.G. INFORMAL PICNIC AREAS INTEGRATED TO PLAY SPACES ALLOW FOR SUPERVISION & SAFE INDEPENDENT PLAY OPPORTUNITIES.




9 ENSURE SPATIAL DIVERSITY TO ACCOMMODATE CHILDREN PLAYING ALONE, AND IN SMALL, LARGE AND FAMILY GROUPS.

E.G. ARTISTIC CUBBY HOUSE AT ORLEIGH PARK

PLAY DESIGN FOR AGE GROUPS

| Age group | Type of play features |
|-------------|--|
| 0-5 years | <ul style="list-style-type: none">• Low platform structures• Soft surfaced structures with low height platforms to ground or over water. E.g. Ladder structures, bridge structures, etc.• Enclosed structures with low height platforms. E.g. Ladder structures, etc.• Crawl or tunnel structures with low height platforms. E.g. Ladder structures, etc.• Enclosed structures with low height platforms. E.g. Ladder structures, etc.• Soft surfaced structures with low height platforms. E.g. Ladder structures, etc.• Enclosed structures with low height platforms. E.g. Ladder structures, etc.• Enclosed structures with low height platforms. E.g. Ladder structures, etc.• Soft surfaced structures with low height platforms. E.g. Ladder structures, etc. |
| 6-11 years | <ul style="list-style-type: none">• Medium platform structures• Ladder structures with low height platforms. E.g. Ladder structures, etc.• Platform structures with low height platforms. E.g. Ladder structures, etc.• Crawl or tunnel structures with low height platforms. E.g. Ladder structures, etc.• Enclosed structures with low height platforms. E.g. Ladder structures, etc.• Soft surfaced structures with low height platforms. E.g. Ladder structures, etc.• Enclosed structures with low height platforms. E.g. Ladder structures, etc.• Enclosed structures with low height platforms. E.g. Ladder structures, etc.• Soft surfaced structures with low height platforms. E.g. Ladder structures, etc. |
| 12-17 years | <ul style="list-style-type: none">• High platform structures• Net structures with low height platforms. E.g. Ladder structures, etc.• Platform structures with low height platforms. E.g. Ladder structures, etc.• Enclosed structures with low height platforms. E.g. Ladder structures, etc.• Soft surfaced structures with low height platforms. E.g. Ladder structures, etc.• Enclosed structures with low height platforms. E.g. Ladder structures, etc.• Enclosed structures with low height platforms. E.g. Ladder structures, etc.• Soft surfaced structures with low height platforms. E.g. Ladder structures, etc. |
| Adults | <ul style="list-style-type: none">• Enclosed structures with low height platforms. E.g. Ladder structures, etc.• Enclosed structures with low height platforms. E.g. Ladder structures, etc.• Enclosed structures with low height platforms. E.g. Ladder structures, etc.• Enclosed structures with low height platforms. E.g. Ladder structures, etc.• Enclosed structures with low height platforms. E.g. Ladder structures, etc.• Enclosed structures with low height platforms. E.g. Ladder structures, etc.• Enclosed structures with low height platforms. E.g. Ladder structures, etc.• Enclosed structures with low height platforms. E.g. Ladder structures, etc. |

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|-------|--|---------------|---------------|----------------|---|---------------------|--|------|---------|---|---|-----------------------------|---------------------|
| | | | | | DRAWING AUTHORISED FOR PUBLICATION PAUL COTTON SIGNATURE ON ORIGINAL DATED 03/09/04 | DESIGN | Std Dwgs WG | DATE | OCT '13 |  | BRISBANE CITY COUNCIL STANDARD DRAWING | | |
| | | | | | MANAGER INFRASTRUCTURE MANAGEMENT R.P.E.Q. 2546 | DRAWN | CPD - P&D | DATE | OCT '13 | | <div>PLAYGROUND DESIGN PRINCIPALS</div> | SCALE NOT TO SCALE | |
| B | Drawing Title Amended | FEB '16 | JUL '16 | JUL '16 | DESIGN APPROVED LAUREN TEMPLEMAN SIGNATURE ON ORIGINAL DATED 31/08/04 | CHECKED | UMD - E&P & IMP | DATE | OCT '13 | | | DWG No. BSD-10402 | |
| A | Drawing Converted from UMS Series April 2014 | APR '14 | APR '14 | APR '14 | PRINCIPAL PROGRAM OFFICER PARKS | DRAWING FILENAME | BSD-10402 (B) Playground design principals.dwg | | | | | | ORIGINAL SIZE A3 |
| ISSUE | AMENDMENT | DRAWN DATE | CHK'D DATE | APPR'D DATE | | ASSOCIATED PLANS | SUPERSEDES UMS-754 | | | | | | |

G1 THESE DRAWINGS SHALL BE READ IN CONJUNCTION WITH ALL SPECIFICATIONS AND WITH SUCH OTHER WRITTEN INSTRUCTIONS AS MAY BE ISSUED.

G2 ALL DIMENSIONS AND EXISTING CONDITIONS TO BE CHECKED BEFORE COMMENCING CONSTRUCTION. ANY DISCREPANCIES SHALL BE REFERRED TO THE SUPERINTENDENT FOR DECISION BEFORE PROCEEDING WITH THE WORK.

G3 ALL WORKMANSHIP AND MATERIALS SHALL COMPLY WITH THE APPROPRIATE AND CURRENT AUSTRALIAN STANDARDS.

G4 ALL DIMENSIONS ARE IN MILLIMETRES UNLESS NOTED OTHERWISE.

G5 DIMENSIONS SHALL NOT BE OBTAINED BY SCALING THE STRUCTURAL DRAWINGS.

G6 SETTING OUT DIMENSIONS SHOWN ON THE DRAWINGS SHALL BE VERIFIED ON SITE BEFORE CONSTRUCTION COMMENCES.

G7 DURING CONSTRUCTION THE STRUCTURE SHALL BE MAINTAINED IN A STABLE CONDITION AND NO PART SHALL BE OVERSTRESSED.

G8 U.N.O. DENOTES UNLESS NOTED OTHERWISE.

G9 ALL TEMPORARY WORKS ARE TO BE DESIGNED AND CERTIFIED BY THE CONTRACTOR'S STRUCTURAL ENGINEER. ALL TEMPORARY WORKS ARE TO BE REMOVED AT THE END OF THE PROJECT WITH GROUND MADE GOOD, ALL AT THE CONTRACTOR'S EXPENSE.

G10 SAFETY PRECAUTIONS SHALL BE TAKEN TO AVOID INJURY TO PEOPLE. THE UNATTENDED FOOTING HOLES SHALL BE COVERED OR FENCED OFF AT ALL TIMES.

| | |
|-----------------------------------|---|
| WIND LOAD: | |
| REGIONAL WIND SPEED: | Ultimate $V_{500}=57\text{m/s}$ Serviceability $V_{25}=39\text{m/s}$ |
| WIND REGION: | B |
| TERRAIN CATEGORY: | 1.5 |
| SHIELDING MULTIPLIER (M_s): | 1.0 |
| TOPOGRAPHIC MULTIPLIER (M_t): | 1.0 |

F1 ALL FOOTINGS ARE TO BE FOUNDED IN ORIGINAL UNDISTURBED MATERIAL OF MINIMUM ALLOWABLE BEARING CAPACITY OF 100 kPa. BEFORE CONSTRUCTION COMMENCES, THE ALLOWABLE BEARING CAPACITY SHALL BE VERIFIED BY A QUALIFIED GEOTECHNICAL ENGINEER (RPEQ). IF SITE CONDITION IS DIFFERENT CONSULT A STRUCTURAL ENGINEER.

F2 THE BOTTOMS OF ALL FOOTINGS ARE TO BE CLEANED OF ALL LOOSE MATERIAL, CLAY SEAMS, WATER ETC PRIOR TO CONCRETING.

C1. ALL WORKMANSHIP AND MATERIALS SHALL BE IN ACCORDANCE WITH AS3600.

C2. ALL CONCRETE SHALL BE PREMIXED BY AN APPROVED SUPPLIER.

C3. ALL CEMENT SHALL BE TYPE GP OR GB TO AS3972 UNLESS OTHERWISE SPECIFIED.

C4. ADMIXTURES SHALL NOT BE USED UNLESS APPROVED IN WRITING BY THE SUPERINTENDENT.

C5. NOMINAL AGGREGATE SIZE TO BE 20mm.
SLUMP TO BE NOT GREATER THAN 80mm.

C6. CONCRETE STRENGTH AND CLEAR CONCRETE COVER TO REINFORCEMENT SHALL BE IN ACCORDANCE WITH THE FOLLOWING TABLE U.N.O.

| ELEMENT | CONCRETE GRADE | REINFORCEMENT COVER |
|----------------|----------------|---------------------|
| BLINDING LAYER | 15 | — |
| MASS CONCRETE | 15 | — |
| BORED PIERS | 25 | 50 |

C7. ALL LAPS IN REINFORCEMENT SHALL BE AS SHOWN IN THE TABLE BELOW UNLESS NOTED OTHERWISE.

| BAR | LENGTH |
|-----|--------|
| N12 | 500 |
| N16 | 650 |
| N20 | 800 |
| N24 | 1050 |

| BAR | LENGTH |
|--------|--------|
| N28 | 500 |
| N32 | 650 |
| N36 | 800 |
| FABRIC | 1050 |

| | |
|----|--|
| R | STRUCTURAL PLAIN ROUND GRADE 250R TO AS4671. |
| N | DEFORMED BAR GRADE D500N TO AS4671. |
| L | COLD ROLLED DEFORMED BAR GRADE D500L TO AS4671. |
| SL | HARD DRAWN STEEL REINFORCING FABRIC GRADE D500L TO AS4671. |

C10. NO HOLES, CHASES OR EMBEDMENT OF PIPES OTHER THAN THOSE SHOWN ON THE STRUCTURAL DRAWINGS SHALL BE MADE IN CONCRETE MEMBERS WITHOUT PRIOR APPROVAL BY THE SUPERINTENDENT.

C12. FORMWORK SHALL BE DESIGNED, CONSTRUCTED AND STRIPPED IN ACCORDANCE WITH AS3610. REFER TO THE SPECIFICATION FOR CLASSES OF SURFACE FINISHES.

- S1. ALL WORKMANSHIP & MATERIALS SHALL BE IN ACCORDANCE WITH AS5100.6, AS4100 & AS/NZS1554 AS APPROPRIATE.
- S2. ALL STEEL SHALL BE IN ACCORDANCE WITH:
AS/NZS3679 GRADE 300 FOR HOT ROLLED SECTIONS
AS1163 GRADE C350L0 FOR RECTANGULAR HOLLOW SECTIONS
AS1163 GRADE C350L0 FOR CIRCULAR HOLLOW SECTIONS
- S3. ALL BOLTS TO BE METRIC HEXAGONAL TO AS/NZS1252 U.N.O.
ALL BOLTS TO BE M20 8.8/S TO AS/NZS 1252 U.N.O.
ALL BOLTS TO BE HOT DIP GALVANISED AS1214
ALL THREADS TO BE TREATED WITH 'LOC-TITE' TO RENDER TAMPER AND VIBRATION PROOF.
- S4. THE CONTRACTOR SHALL SUBMIT RPEQ CERTIFICATION CONFIRMING THE FOLLOWING TOGETHER WITH THE RELEVANT MILL AND TEST CERTIFICATES TO THE SUPERINTENDENT FOR APPROVAL PRIOR TO COMMENCING FABRICATION.
 - THAT THE STRUCTURAL STEEL PRODUCTS SUPPLIED ARE FROM EITHER AN AUSTRALIAN OR OVERSEAS ACRS CERTIFIED MANUFACTURER. REFER www.steelcertification.com FOR CURRENT CERTIFICATE HOLDERS. ACRS REFERS TO "AUSTRALIAN CERTIFICATION AUTHORITY FOR REINFORCING AND STRUCTURAL STEELS".
 - THAT WHERE STRUCTURAL STEEL PRODUCTS ARE SOURCED FROM OVERSEAS FOR THIS PROJECT THE CERTIFYING ENGINEER HAS REVIEWED THE MILL AND TEST CERTIFICATES FROM THE SUPPLIERS OF THE STEEL PRODUCTS AND CONFIRMS THAT THEY COMPLY WITH THE RELEVANT AUSTRALIAN STANDARDS IN RELATION TO MATERIAL COMPOSITION AND STRENGTH.
 - THAT ALL BOLTS USED SHALL COMPLY WITH AS1252 AND THE CURRENT REQUIREMENTS OF THE AUSTRALIAN STEEL INSTITUTE ASI TECHNICAL NOTE TN001 VERSION 3.

S6. THE ENDS OF ALL TUBULAR MEMBERS ARE TO BE SEALED WITH 5mm THICK PLATES AND CONTINUOUS FILLED WELDED U.N.O.


S8. BEFORE FABRICATION HAS COMMENCED, THE CONTRACTOR SHALL SUBMIT THREE (3) COPIES OF THE SHOP DRAWINGS TO THE SUPERINTENDENT FOR REVIEW. REVIEW DOES NOT INCLUDE CHECKING OF DIMENSIONS.

S10. ALL STEELWORK TO BE HOT DIP GALVANISED IN ACCORDANCE WITH AS/NZS2312 HDG600 SPECIFICATION. CORROSION PROTECTION COATING TO SURFACE PREPARATION OF SUBSTRATE MATERIAL IS CLASS 2½ TO AS1627 AND PICKLED PRIOR GALVANISING. HOT DIPPED GALVANISED COATING SHALL BE IN ACCORDANCE WITH AS/NZS4680.

S12. PROTECTIVE COATINGS TO BE APPLIED AFTER ALL FABRICATION COMPLETED. NO WELDING ETC TO BE CARRIED OUT DURING OR AFTER APPLICATION OF COATING SYSTEM.

S13. ANY POST GALVANISING DAMAGED TO BE MADE GOOD WITH A HIGH QUALITY TWO PACK EPOXY ZINC RICH PAINT CONFORMING TO AS/NZS3750.9 WITH A MINIMUM DRY FILM THICKNESS OF 100 MICRONS. SURFACE PREPARATION AS PER PAINT MANUFACTURER'S RECOMMENDATIONS.

| | | | | | | | | | |
|---|--|---------------|---------------|----------------|---|---------------------|--|------|---------|
| SPECIFICATION FOR CLASSES OF SURFACE FINISHES. | | | | | | | | | |
| <div><div><div>STRUCTURAL DESIGN CERTIFICATION</div><div><div>DESIGN</div><div>Zhuangzhi Hu RPEQ 8950 2015.03.19 14:00:02 +10'00"</div></div><div><div>DESIGN CHECK</div><div>Len'ita MendisRPEQ 8950 2015.03.20 09:05:32 +10'00"</div></div><div><div>AUTHORISED FOR ISSUE</div><div>Bala Balakumar RPEQ 3963 2015.03.20 14:01:01+10'00"</div></div></div></div> | | | | | | | | | |
| | | | | | DRAWING AUTHORISED FOR PUBLICATION | DESIGN | CPO - P&D | DATE | MAR '15 |
| | | | | | Inga Candric 2015.06.04 15:34:27+10'00" for ASSET ENGINEERING MANAGER STRATEGIC ASSET MANAGEMENT | DRAWN | CPO - P&D | DATE | MAR '15 |
| | | | | | DESIGN APPROVED | CHECKED | CPS - NEWS | DATE | MAR '15 |
| A | Drawing Converted From UMS Series March 2015 | MAR '15 | MAR '15 | MAR '15 | DANNY VAN DER WALLE SIGNATURE ON ORIGINAL APRIL 2014 | DRAWING FILENAME | BSD-10501 (A) Park Signage - General Structural Notes - Sheet 1 of 2.dwg | | |
| ISSUE | AMENDMENT | DRAWN DATE | CHK'D DATE | APPR'D DATE | SENIOR CO-ORDINATOR PARKS | ASSOCIATED PLANS | BSD-10501 SHEET 2.dwg | | |



BRISBANE CITY COUNCIL STANDARD DRAWING

PARK SIGNAGE

GENERAL STRUCTURAL NOTES

SHEET 1 OF 2

SCALE

Dwg No. BSD-10501

ORIGINAL SIZE A3

REVISION A

SAFETY IN CONSTRUCTION NOTES

1. THE CONTRACTOR SHALL BE EXPERIENCED AND COMPETENT TO CARRY OUT THE PROPOSED WORKS IN ACCORDANCE WITH ALL APPLICABLE CURRENT CONSTRUCTION INDUSTRY CODES OF PRACTICE, AUSTRALIAN STANDARDS AND WORKPLACE HEALTH AND SAFETY REGULATIONS. THE CONTRACTOR SHALL BE RESPONSIBLE FOR MITIGATING THE RISKS RELATING TO THE CONSTRUCTION OPERATIONS INCLUDING BUT NOT LIMITED TO THE FOLLOWING;
- ALL DEMOLITION WORKS

- ALL TEMPORARY WORKS

- MAINTAINING A SAFE WORKPLACE BY PROVIDING SAFE ACCESS TO ALL WORK AREAS AND THE USE OF APPROPRIATE PROTECTIVE EQUIPMENT

- LIFTING OF MATERIALS

- PROVIDING STABLE PLATFORMS FOR CRANES, PILING RIGS AND OTHER CONSTRUCTION MACHINERY

- EXCAVATIONS

- NOISE, DUST, VAPOUR, WASTE AND VIBRATION CONTROL

- PROTECTION OF AND PROTECTION FROM EXISTING OVERHEAD AND UNDERGROUND SERVICES

- CONTACT QLD DIAL BEFORE YOU DIG (DBYD) FOR ALL UNDERGROUND SERVICES

- PROTECTION OF NEIGHBOURING PROPERTIES/ADJACENT EXISTING STRUCTURES

- ENVIRONMENTAL PROTECTION AND MANAGEMENT


- MANAGEMENT OF CONTAMINATED/HAZARDOUS MATERIALS

- TRAFFIC AND PEDESTRIAN MANAGEMENT

- SITE LIGHTING AND SECURITY
2. ALL TEMPORARY WORKS, LIFTING OPERATIONS, EXCAVATIONS AND PLATFORMS FOR CONSTRUCTION MACHINERY SHALL BE DESIGNED AND CERTIFIED BY THE CONTRACTOR’S REGISTERED PROFESSIONAL ENGINEER (RPEQ) EXPERIENCED IN THE RELEVANT FIELDS.

INSPECTIONS AND CERTIFICATION NOTES

1. ARRANGE & PAY ALL COSTS FOR A REGISTERED PROFESSIONAL STRUCTURAL ENGINEER AND A GEOTECHNICAL ENGINEER (RPEQ) TO INSPECT AND CERTIFY ALL CONSTRUCTION WORK AS SPECIFIED IN THE CONTRACT.
2. THE CONSTRUCTION CERTIFICATE SHALL STATE THAT ALL CONSTRUCTION WORKS HAVE BEEN CARRIED OUT AS PER THE MOST CURRENT ISSUE OF THE CONTRACT DOCUMENTS AND SITE INSTRUCTIONS/VARIATION ORDERS ISSUED DURING CONSTRUCTION BY CITY PROJECTS OFFICE.

| | | | | | | | | | | | | | | | | | | | | | |
|--|--|--|--|--|--|--|--|--|--|---|--|--|--|--|--|---|--|---------------------|--|-----------------------|--|
| | | | | | | | | | | STRUCTURAL DESIGN CERTIFICATION | | | | | | | | | | | |
| | | | | | | | | | | DESIGN | | DESIGN CHECK | | AUTHORISED FOR ISSUE | | | | | | | |
| | | | | | | | | | | Zhuangzhi Hu RPEQ 13885 2015.03.19 13:59:36+10'00' | | Lenita MendisRPEQ 8950 2015.03.20 09:06:08 +10'00' | | Bala Balakumar RPEQ 3963 2015.03.20 14:00:30+10'00' | | | | | | | |
| | | | | | | | | | | DRAWING AUTHORISED FOR PUBLICATION | | DESIGN | | CPO - P&D | | DATE | | MAR '15 | | | |
| | | | | | | | | | | Inga Condric 2015.06.04 15:35:11+10'00' | | DRAWN | | CPO - P&D | | DATE | | MAR '15 | | | |
| | | | | | | | | | | for ASSET ENGINEERING MANAGER STRATEGIC ASSET MANAGEMENT | | CHECKED | | CPS - NEWS | | DATE | | MAR '15 | | | |
| | | | | | | | | | | DESIGN APPROVED | | DRAWING FILENAME | | BSD-10501 (A) Park Signage - General Structural Notes - Sheet 2 of 2.dwg | | | | | | | |
| A Drawing Converted From UMS Series March 2015 | | | | | | | | | | MAR '15 | | MAR '15 | | MAR '15 | | DANNY VAN DER WALLE SIGNATURE ON ORIGINAL APRIL 2014 | | | | | |
| ISSUE AMENDMENT | | | | | | | | | | DRAWN DATE | | CHK'D DATE | | APPR'D DATE | | SENIOR CO-ORDINATOR PARKS | | ASSOCIATED PLANS | | BSD-10501 SHEET 1.dwg | |
| | | | | | | | | | | | | | | | |  | | | | | |
| | | | | | | | | | | BRISBANE CITY COUNCIL STANDARD DRAWING | | | | | | | | | | | |
| | | | | | | | | | | PARK SIGNAGE GENERAL STRUCTURAL NOTES SHEET 2 OF 2 | | | | | | SCALE | | DWG No. | | BSD-10501 | |
| | | | | | | | | | | | | | | | | ORIGINAL SIZE | | REVISION | | A3 A | |

GENERAL SIGN NOTES

- ALL DIMENSIONS IN MILLIMETRES (U.N.O.).
- REFER TO BSD - 10501 (SHEETS 1 AND 2) FOR STRUCTURAL NOTES.
- REFER TO BSD - 10503 FOR GRAPHIC NOTES
- REFER TO BSD - 10504 FOR STANDARD SIZES AND EXAMPLE LAYOUTS.
- REFER TO BSD - 10506 FOR ORDINANCE SIGNAGE DETAILS.
- REFER TO BSD - 10507 FOR PICTOGRAM SUITE DETAILS.

SIGNAGE PANEL:


- PANELS TO BE 16 GAUGE, 1.6mm THICK ALUMINIUM SHEETING.
- CORNERS OF PANEL TO HAVE 5mm RADIUS WITH ALL CORNERS / EDGES TO BE FREE OF BURRS.
- ANTI-GRAFFITI CLEAR FILM OR SIMILAR PRODUCT TO FINISHED SURFACE OF PANEL.
- REFER TO BSD - 10503 AND BSD - 10504 FOR SIZES OF SIGN PANELS, TYPICAL LAYOUTS AND GRAPHIC NOTES.

SIGNAGE STIFFENING RAILS:

- REFER TO DEPARTMENT OF TRANSPORT AND MAIN ROADS DRAWING 1369 FOR DETAILS OF SIGN RAIL EXTRUSIONS.
- SIGN RAIL TO BE 44mm WIDE X 40mm DEEP AND 3mm THICK. (TYPE 2A AS PER TRANSPORT AND MAIN ROADS DRAWING 1369).
- SIGN RAIL TO BE POP RIVETED TO SIGN USING 'HENHUB' SELF PIERCING RIVETING SYSTEM OR SIMILAR APPROVED, AT A SPACING BETWEEN 250-300mm APART DEPENDING ON BEST PLACEMENT IN RELATION TO SIGN DESIGN / PANEL COMBINATIONS.
- SIGN RAILS ARE TO BE TYPICALLY POSITIONED 100mm IN FROM TOP AND BOTTOM EDGE OF SIGN AND 50mm FROM SIDE EDGES OF SIGN. IN SOME CASES THIS IS TO VARY TO ENSURE SIGN TEXT AND GRAPHICS ARE UNOBSTRUCTED BY FIXING HOLES.

SIGNAGE POSTS:

- SIGNS ARE TO BE ATTACHED TO POSTS USING STANDARD (API BRAND OR APPROVED SIMILAR) SADDLE BRACKETS TO SUIT SIZE OF POST. SADDLE BRACKETS TO BE STAINLESS STEEL WITH STAINLESS STEEL NUTS AND BOLTS.
- BLACK PLASTIC CAPS TO BE INSTALLED TO END OF POSTS. END CAPS TO SUIT POST SIZE AS SPECIFIED.

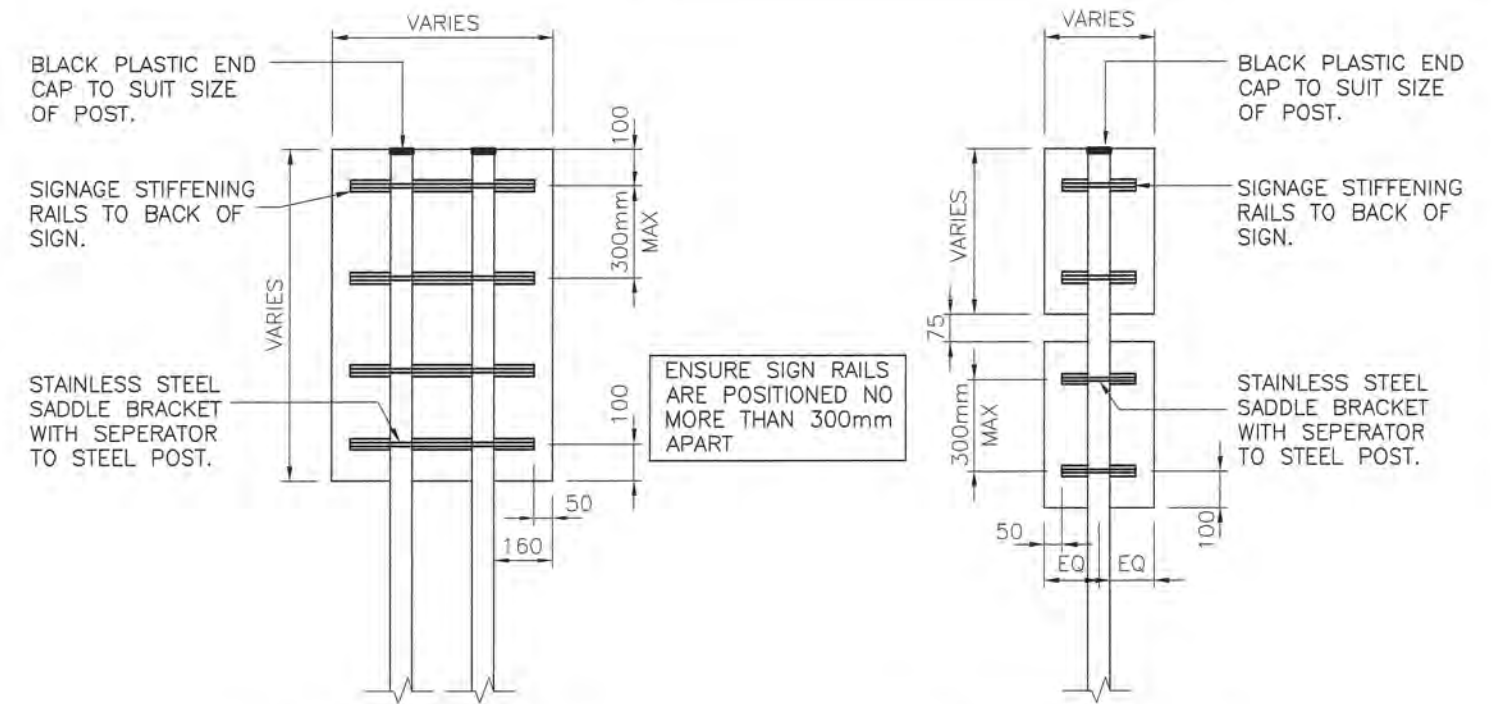


DOUBLE (2) POST TO PANEL

SINGLE (1) POST TO PANEL

FIXING DETAILS

SCALE: 1:20

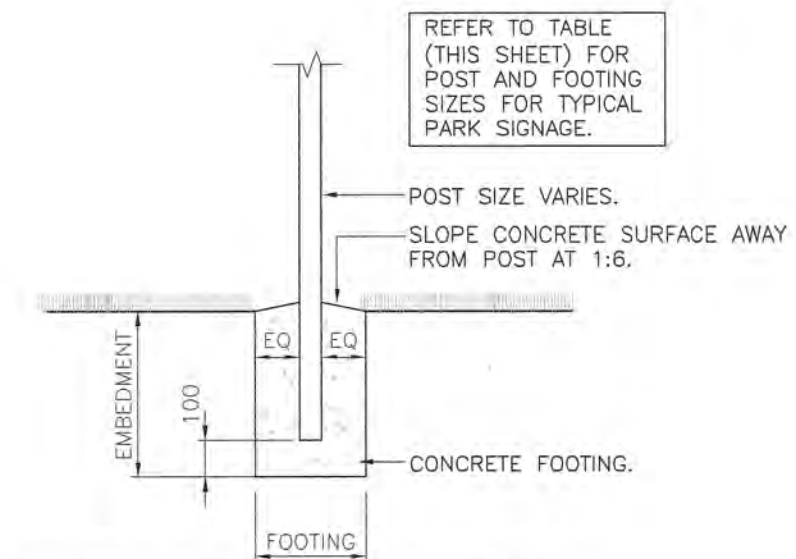

CONCRETE FOOTING DETAIL

SCALE: 1:20

TYPICAL POST, FOOTING AND EMBEDMENT SIZES FOR STANDARD SIGNS SHOWN ON BSD - 10504


| SIGNAGE PANEL SIZES HEIGHT x WIDTH | NUMBER OF POST | TERRAIN CATEGORY = 1.5 and ABOVE | | |
|--|-------------------|--------------------------------------|-------------------------|-----------|
| | | POST (STEEL) DIAMETER x THICKNESS | FOOTING | EMBEDMENT |
| 900x1200 | 2 | 76.1x3.2 CHS | 300 Dia (2 FOOTINGS) | 800 |
| 1200x900 | | | | |
| 600x900 (MAX 2 600x900 PANELS) | | | | |
| 900x600 | 2 | 60.3x2.9 CHS | 450 Dia | 900 |
| 400x600 x2 Panels | | | | |
| 600x400 x2 Panels | 1 | 76.1x3.2 CHS | 300 Dia | 800 |
| 400x600 | | | | |
| 450x300 (WITH MAX 3 OPTIONAL 200x300 PANELS) | | | | |
| 300x450 x3 Panels | | | | |
| 200x300 | 1 | 60.3x2.9 CHS | 300 Dia | 700 |
| 450x300 x2 Panels | | | | |
| 300x200 x3 Panels | | | | |

STRUCTURAL DESIGN CERTIFICATION


| | | |
|---|---|--|
| DESIGN <i>Zhuangzhi Hu</i> | DESIGN CHECK <i>Lanita Mendis</i> | AUTHORISED FOR ISSUE <i>Bala Balakumar</i> |
| Zhuangzhi Hu RPEQ:13885 2015.03.20 11:40:17 +10'00' | Lanita Mendis RPEQ:8950 2015.03.20 12:09:42 +10'00' | Bala Balakumar, RPEQ:3963 2015.03.20 14:01:31 +10'00' |

BRISBANE CITY COUNCIL STANDARD DRAWING


| | | |
|---|--|---------------------|
| PARK SIGNAGE - TYPICAL INSTALLATION DETAILS AND NOTES | | SCALE 1:20 |
| DVG No. BSD-10502 | | ORIGINAL SIZE A3 |
| | | REVISION A |

| | | | | | | | | | |
|-------|--|---------------|---------------|----------------|---|---------------------|--------------------|------|---------|
| | | | | | <div>DRAWING AUTHORISED FOR PUBLICATION</div> <div>FOR ASSET ENGINEERING MANAGER STRATEGIC ASSET MANAGEMENT DESIGN APPROVED</div> <div></div> <div>SENIOR CO-ORDINATOR PARKS</div> | DESIGN | CPO – P&D | DATE | MAR '15 |
| | | | | | | DRAWN | CPO – P&D | DATE | MAR '15 |
| | | | | | | CHECKED | CPS – NEWS | DATE | MAR '15 |
| A | Drawing Converted From UMS Series March 2015 | MAR '15 | MAR '15 | MAR '15 | | DRAWING FILENAME | BSD-10502.dwg | | |
| ISSUE | AMENDMENT | DRAWN DATE | CHK'D DATE | APPR'D DATE | | ASSOCIATED PLANS | SUPERSEDES UMS-775 | | |




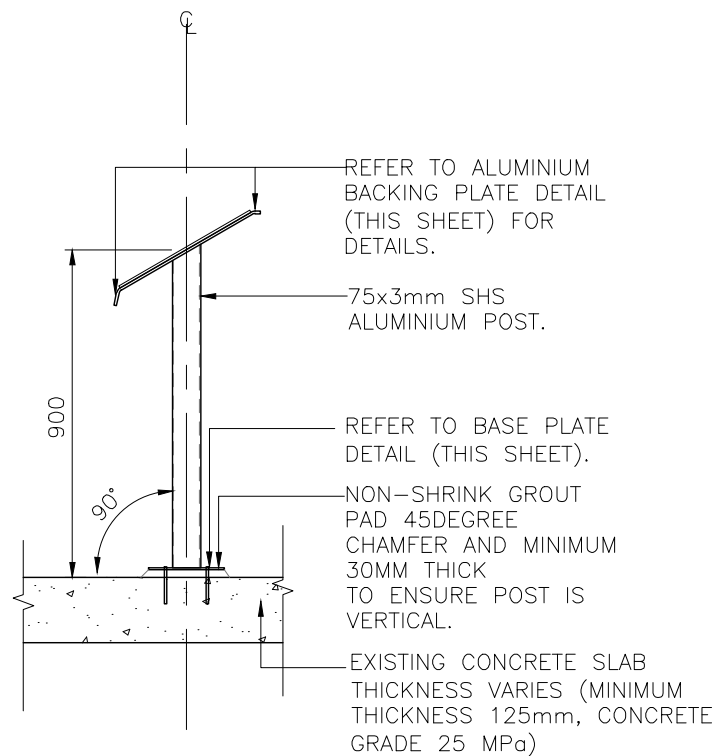


INTERPRETIVE SIGN IN EXISTING CONCRETE SIDE ELEVATION
SCALE: 1:20

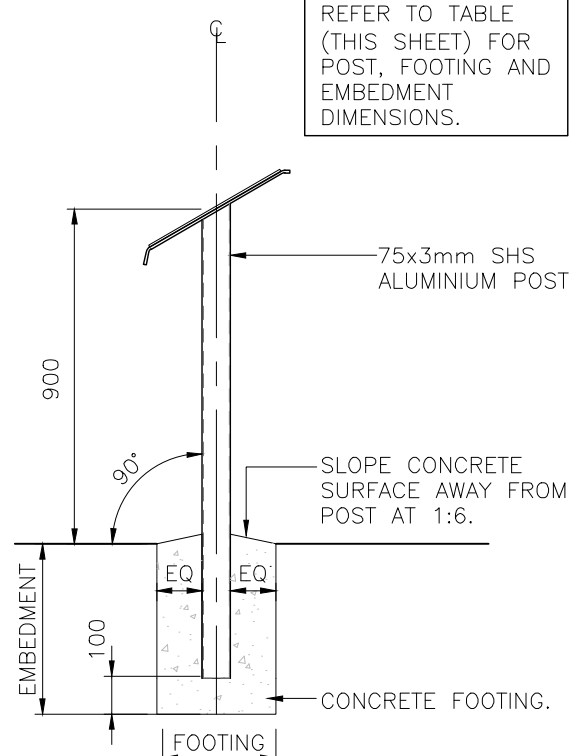

INTERPRETIVE SIGN IN NEW CONCRETE FOOTING – SIDE ELEVATION
SCALE: 1:20

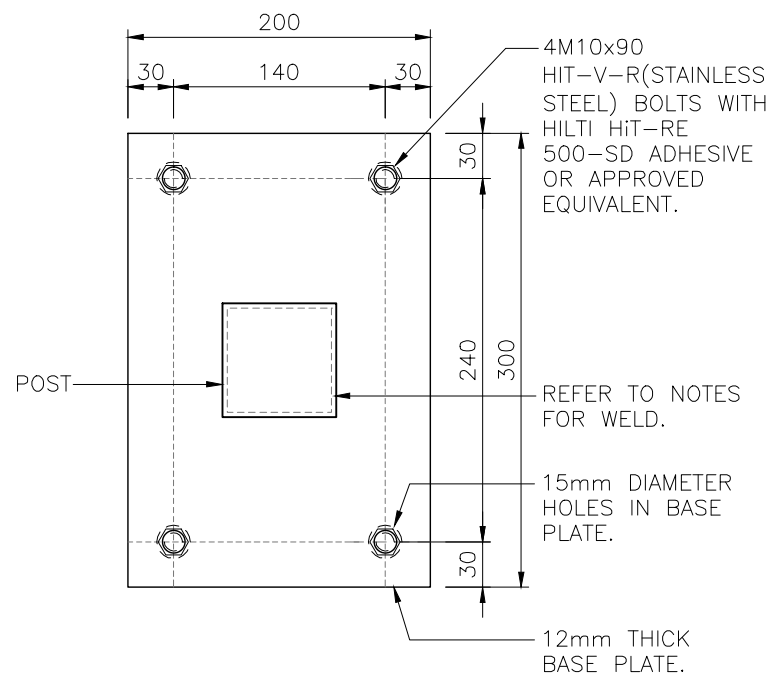

BASE PLATE DETAIL – PLAN
SCALE: 1:5

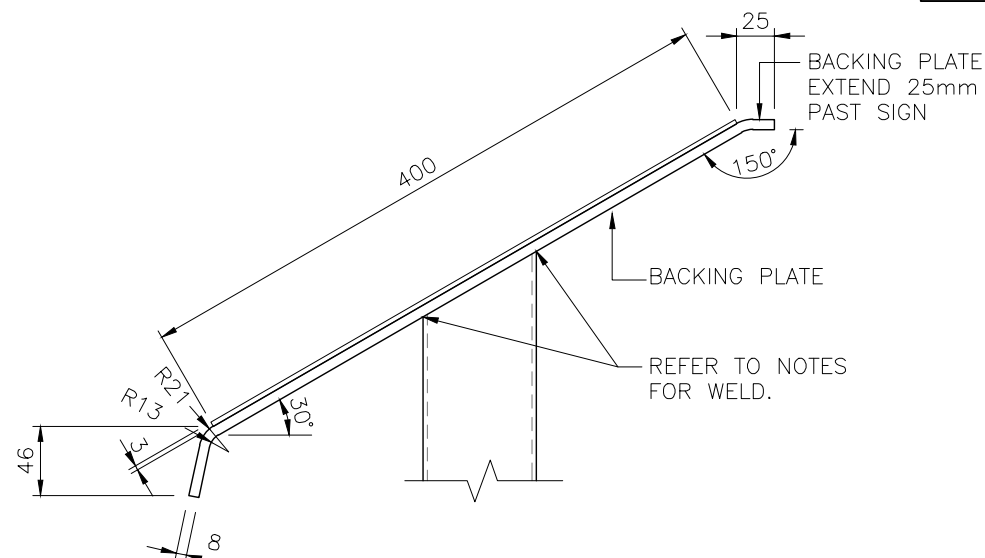

ALUMINIUM BACKING PLATE DETAIL
SCALE: 1:5

GENERAL SIGN NOTES

- ALL DIMENSIONS IN MILLIMETRES (U.N.O.).
- REFER TO BSD – 10501 (SHEETS 1 AND 2) FOR STRUCTURAL CONCRETE NOTES.
- REFER TO BSD – 10503 FOR GRAPHIC NOTES.
- ALL FRAMING SECTIONS TO BE GRADE 6060 T5 ALUMINIUM UNLESS NOTED OTHERWISE.
- ALL PLATES TO BE GRADE 5083-H321 ALUMINIUM UNO.
- ALL BOLTS TO BE STAINLESS STEEL GR 316 UNO. PROVIDE APPROVED ISOLATION WASHERS TO ALUMINIUM FRAME.
- ALL WELDS ARE CATEGORY B 4mm CONTINUOUS FILLET WELD TO AS1665.

SIGNAGE PANEL:

- PANEL TO BE 400mm HIGH x 600mm WIDE, 16 GAUGE, 3mm THICK ALUMINIUM SHEETING.
- CORNERS OF PANEL TO HAVE 5mm RADIUS WITH ALL CORNERS / EDGES TO BE FREE OF BURRS.
- ANTI-GRAFFITI CLEAR FILM OR SIMILAR PRODUCT TO FINISHED SURFACE OF PANEL.
- FIX SIGNAGE PANEL TO BACKING PLATE USING SIKAFLEX-221 OR APPROVED EQUAL AS PER MANUFACTURERS SPECIFICATIONS.

SIGNAGE POSTS:


- 75x3mm SHS ALUMINIUM POST.

DESIGN DATA

- DESIGN STANDARD: AS1664.1, AS1170, AS1665
- LIVE LOAD: MAX. 1.5kN CONCENTRATED (LATERAL) LOAD
- WIND LOAD: REGIONAL WIND SPEED: Ultimate V₅₀₀=57m/s Serviceability V₂₅=39m/s
- WIND REGION: B
- TERRAIN CATEGORY: 1.5
- SHIELDING MULTIPLIER (M_s): 1.0
- TOPOGRAPHIC MULTIPLIER (M_t): 1.0

POST, FOOTING AND EMBEDMENT DETAILS

| SIGN NAME | PANEL SIZE | NUMBER OF POST | TERRAIN CATEGORY = 1.5 AND ABOVE | | |
|-------------------|------------|----------------|----------------------------------|---------|-----------|
| | | | POST | FOOTING | EMBEDMENT |
| INTERPRETIVE SIGN | 400x600 | 1 | 75x3mm SHS ALUMINIUM | 300 DIA | 600 |

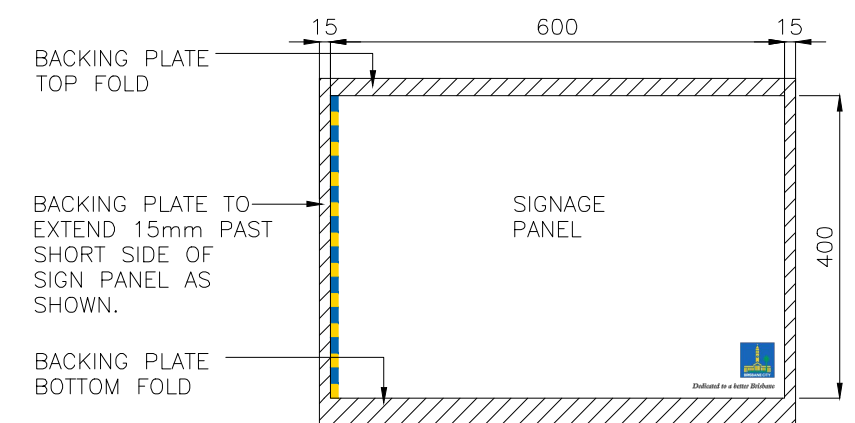

SIGNAGE PANEL TO BACKING PLATE – PLAN
SCALE: 1:10

STRUCTURAL DESIGN CERTIFICATION

| | | |
|--------|--------------|----------------------|
| DESIGN | DESIGN CHECK | AUTHORISED FOR ISSUE |
|--------|--------------|----------------------|

BRISBANE CITY COUNCIL STANDARD DRAWING


PARK PODIUM INTERPRETIVE SIGNAGE

| | |
|---------------|-----------|
| SCALE | 1:20 |
| DWG No. | BSD-10505 |
| ORIGINAL SIZE | A3 |
| REVISION | A |

| | | | | | | | | | |
|-------|--|---------------|---------------|----------------|---|---------------------|--|------|---------|
| | | | | | DRAWING AUTHORISED FOR PUBLICATION | DESIGN | CPO – P&D | DATE | MAR '15 |
| | | | | | Ingo Condric 2015.06.04 15:45:06+10'00' | DRAWN | CPO – P&D | DATE | MAR '15 |
| | | | | | for ASSET ENGINEERING MANAGER STRATEGIC ASSET MANAGEMENT | CHECKED | CPS – NEWS | DATE | MAR '15 |
| | | | | | DESIGN APPROVED | DRAWING FILENAME | BSD-10505 (A) Park Podium Interpretive Signage.dwg | | |
| A | Drawing Converted From UMS Series March 2015 | MAR '15 | MAR '15 | MAR '15 | DANNY VAN DER WALLE SIGNATURE ON ORIGINAL APRIL 2014 | ASSOCIATED PLANS | | | |
| ISSUE | AMENDMENT | DRAWN DATE | CHK'D DATE | APPR'D DATE | SENIOR CO-ORDINATOR PARKS | | | | |



| | | | | |
|-------|--|------------|------------|-------------|
| A | Drawing Converted From UMS Series March 2015 | MAR '15 | MAR '15 | MAR '15 |
| ISSUE | AMENDMENT | DRAWN DATE | CHK'D DATE | APPR'D DATE |

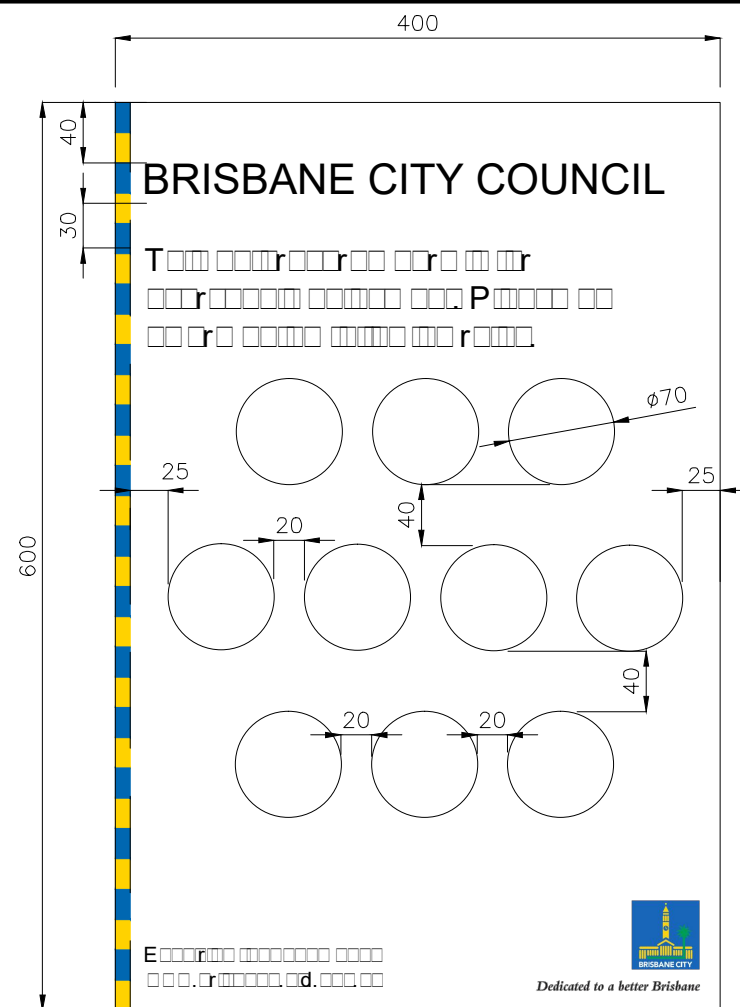


GENERAL NOTES: STANDARD PARK ORDINANCE
SIGNAGE:

- ALL DIMENSIONS IN MILLIMETRES (U.N.O.).
- REFER TO BSD - 10501 FOR STRUCTURAL NOTES (SHEETS 1 AND 2)
- REFER TO BSD - 10502 FOR TYPICAL PARK SIGNAGE INSTALLATION DETAILS
- REFER TO BSD - 10503 FOR GRAPHIC NOTES

THERE ARE TWO SUITES OF SIGNS WHICH ARE USED FOR PARK ORDINANCE SIGNAGE AS FOLLOWS:

- PARK ORDINANCE SIGNAGE
- NATURAL AREA ORDINANCE SIGNAGE

STANDARD ORDINANCE SIGNS USE THE 10 SPECIFIC PICTOGRAMS AS SHOWN ON THE STANDARD PICTOGRAM SETOUT DRAWINGS ABOVE. SIGNS WITH 11 OR 12 PICTOGRAMS ARE OPTIONAL WHERE 1 OR 2 ADDITIONAL PICTOGRAMS ARE REQUIRED. REFER TO BSD – 10507 FOR PARK PICTOGRAM SUITE.

| | | | | | | | | | | | | | |
|-------|--|---------------|---------------|----------------|---|---------------------|--|------|---------|---|--|----------|--|
| | | | | | DRAWING AUTHORISED FOR PUBLICATION Inga Condric 2015.06.04 15:45:43+10'00' for ASSET ENGINEERING MANAGER STRATEGIC ASSET MANAGEMENT | DESIGN | CPO - P & D | DATE | MAR '15 |  | BRISBANE CITY COUNCIL STANDARD DRAWING | | |
| | | | | | ----- DESIGN APPROVED DANNY VAN DER WALLE SIGNATURE ON ORIGINAL APRIL 2014 ----- | DRAWN | CPO - P & D | DATE | MAR '15 | | SCALE 1:20 | | |
| | | | | | | CHECKED | CPS - NEWS | DATE | MAR '15 | | DWG No. BSD-10506 | | |
| A | Drawing Converted From UMS Series March 2015 | MAR '15 | MAR '15 | MAR '15 | | DRAWING FILENAME | BSD-10506 (A) Park signage - Ordinance.dwg | | | | ORIGINAL SIZE | REVISION | |
| ISSUE | AMENDMENT | DRAWN DATE | CHK'D DATE | APPR'D DATE | SENIOR CO-ORDINATOR PARKS | ASSOCIATED PLANS | SUPERSEDES UMS-776 | | | | A3 | A | |

GENERAL NOTES: PARK PICTOGRAM SIGNAGE:


- ALL DIMENSIONS IN MILLIMETRES (U.N.O.)
- REFER TO BSD – 10503 FOR GRAPHIC NOTES.
- REFER BSD – 1003 FOR BCC CORPORATE COLOUR PALETTE DETAILS.
- PICTOGRAMS WILL BE PROVIDED DIGITALLY AND MUST BE SCALED PROPORTIONALLY.
- ONLY PICTOGRAMS SHOWN ON THIS SHEET ARE TO BE USED. FOR NON-STANDARD PICTOGRAMS, CONTACT CITY PROJECTS OFFICE/CORPORATE COMMUNICATIONS BRISBANE CITY COUNCIL FOR APPROVAL.

PARK PICTOGRAMS – ACTIVITIES



PARK PICTOGRAM – FACILITIES



| | | | | | | | | | | | |
|-------|--|---------------|---------------|----------------|--|--|--|--|---|---|---------------|
| | | | | | DRAWING AUTHORISED FOR PUBLICATION Inga Condric 2015.06.04 15:46:39+10'00' for ASSET ENGINEERING MANAGER STRATEGIC ASSET MANAGEMENT DESIGN APPROVED DANNY VAN DER WALLE SIGNATURE ON ORIGINAL APRIL 2014 SENIOR CO-ORDINATOR PARKS | DESIGN CPO - P&D DATE MAR '15 | | |  | BRISBANE CITY COUNCIL STANDARD DRAWING | |
| | | | | | | DRAWN CPO - P&D DATE MAR '15 | | | | PARK SIGNAGE PICTOGRAM SUITE SHEET 1 OF 2 | |
| | | | | | | CHECKED CPS - NEWS DATE MAR '15 | | | | SCALE DWG No. BSD-10507 | |
| A | Drawing Converted From UMS Series March 2015 | MAR '15 | MAR '15 | MAR '15 | | DRAWING FILENAME BSD-10507 (A) Park signage pictogram suite - Sheet 1 of 2.dwg | | | | ORIGINAL SIZE A3 | REVISION A |
| ISSUE | AMENDMENT | DRAWN DATE | CHK'D DATE | APPR'D DATE | | ASSOCIATED PLANS SUPERSEDES UMS-774 | | | | | |

GENERAL NOTES: PARK PICTOGRAM SIGNAGE:


- ALL DIMENSIONS IN MILLIMETRES (U.N.O.)
- REFER TO BSD – 10503 FOR GRAPHIC NOTES.
- REFER BSD – 1003 FOR BCC CORPORATE COLOUR PALETTE DETAILS.
- PICTOGRAMS WILL BE PROVIDED DIGITALLY AND MUST BE SCALED PROPORTIONALLY.
- ONLY PICTOGRAMS SHOWN ON THIS SHEET ARE TO BE USED. FOR NON-STANDARD PICTOGRAMS, CONTACT CITY PROJECTS OFFICE/CORPORATE COMMUNICATIONS BRISBANE CITY COUNCIL FOR APPROVAL.

PARK PICTOGRAMS – ORDINANCE



PARK PICTOGRAMS – ENVIRONMENTAL



| | | | | | | | | | | | | | |
|-------|--|---------------|---------------|----------------|---|---------------------|---|------|---------|---|---|-----------|-------|
| | | | | | DRAWING AUTHORISED FOR PUBLICATION | DESIGN | CPO - P&D | DATE | MAR '15 |  | BRISBANE CITY COUNCIL STANDARD DRAWING | | |
| | | | | | Inga Condric 2015.06.04 15:47:32+10'00' | DRAWN | CPO - P&D | DATE | MAR '15 | | PARK SIGNAGE PICTOGRAM SUITE SHEET 2 OF 2 | | |
| | | | | | for ASSET ENGINEERING MANAGER STRATEGIC ASSET MANAGEMENT | CHECKED | CPS - NEWS | DATE | MAR '15 | | | | SCALE |
| | | | | | DESIGN APPROVED | DRAWING FILENAME | BSD-10507 (A) Park signage pictogram suite - Sheet 2 of 2.dwg | | | | DWG No. | BSD-10507 | |
| A | Drawing Converted From UMS Series March 2015 | MAR '15 | MAR '15 | MAR '15 | DANNY VAN DER WALLE SIGNATURE ON ORIGINAL APRIL 2014 | ASSOCIATED PLANS | SUPERSEDES UMS-774 | | | | ORIGINAL SIZE | REVISION | |
| ISSUE | AMENDMENT | DRAWN DATE | CHK'D DATE | APPR'D DATE | SENIOR CO-ORDINATOR PARKS | | | | | | A3 | A | |

GENERAL SIGN NOTES

- ALL DIMENSIONS IN MILLIMETRES (U.N.O.).
- REFER TO BSD – 10501 (SHEETS 1 AND 2) FOR STRUCTURAL NOTES.
- REFER TO BSD – 10506 FOR ORDINANCE SIGNAGE DETAILS.
- REFER TO BSD – 10507 FOR PICTOGRAM SUITE DETAILS.
- REFER TO BSD – 10508 (SHEET 2 OF 4) FOR GRAPHIC NOTES.
- REFER TO BSD – 10508 (SHEET 3 OF 4) FOR EXAMPLE LAYOUTS.
- REFER TO BSD – 10508 (SHEET 4 OF 4) FOR DETAILED DIMENSIONS FOR DOG OFF–LEASH SIGNS 1 AND 2.

SIGNAGE PANEL:


- PANELS TO BE 16 GAUGE, 1.6mm THICK ALUMINIUM SHEETING.
- CORNERS OF PANEL TO HAVE 5mm RADIUS WITH ALL CORNERS / EDGES TO BE FREE OF BURRS.
- ANTI–GRAFFITI CLEAR FILM OR SIMILAR PRODUCT TO FINISHED SURFACE OF PANEL.

SIGNAGE STIFFENING RAILS:

- REFER TO DEPARTMENT OF TRANSPORT AND MAIN ROADS DRAWING 1369 FOR DETAILS OF SIGN RAIL EXTRUSIONS.
- SIGN RAIL TO BE 44mm WIDE X 40mm DEEP AND 3mm THICK. (TYPE 2A AS PER TRANSPORT AND MAIN ROADS DRAWING 1369).
- SIGN RAIL TO BE POP RIVETED TO SIGN USING ‘HENHUB’ SELF PIERCING RIVETING SYSTEM OR SIMILAR APPROVED, AT A SPACING BETWEEN 250–300mm APART DEPENDING ON BEST PLACEMENT IN RELATION TO SIGN DESIGN / PANEL COMBINATIONS.
- SIGN RAILS ARE TO BE TYPICALLY POSITIONED 100mm IN FROM TOP AND BOTTOM EDGE OF SIGN AND 50mm FROM SIDE EDGES OF SIGN. IN SOME CASES THIS IS TO VARY TO ENSURE SIGN TEXT AND GRAPHICS ARE UNOBSTRUCTED BY FIXING HOLES.


SIGNAGE POSTS:

- SIGNS ARE TO BE ATTACHED TO POSTS USING STANDARD (API BRAND OR APPROVED SIMILAR) SADDLE BRACKETS TO SUIT SIZE OF POST. SADDLE BRACKETS TO BE STAINLESS STEEL WITH STAINLESS STEEL NUTS AND BOLTS.
- BLACK PLASTIC CAPS TO BE INSTALLED TO END OF POSTS. END CAPS TO SUIT POST SIZE AS SPECIFIED.

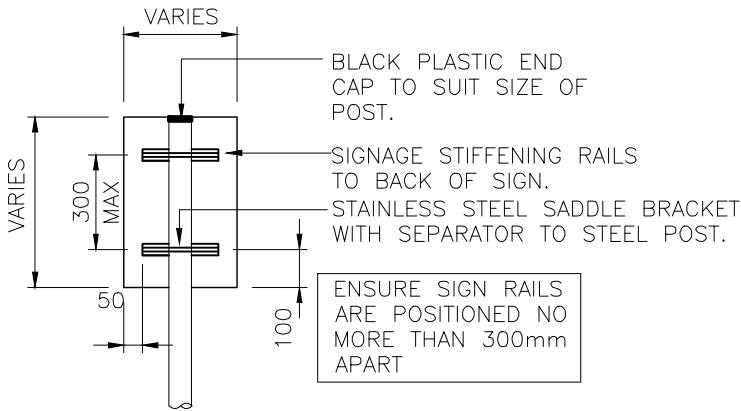


SINGLE (1) POST TO PANEL C FIXING DETAIL

SCALE: 1:20

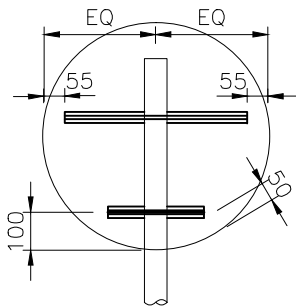


TYPICAL PANEL D FIXING DETAIL

SCALE: 1:20

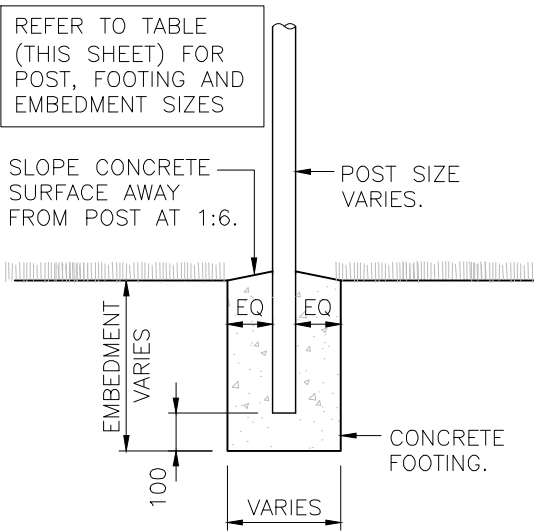


CONCRETE FOOTING DETAIL

SCALE: 1:20

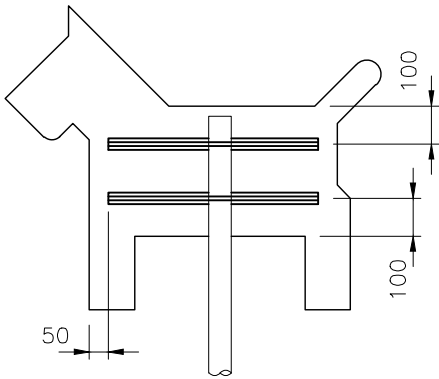

TYPICAL PANEL A FIXING DETAIL

SCALE: 1:20

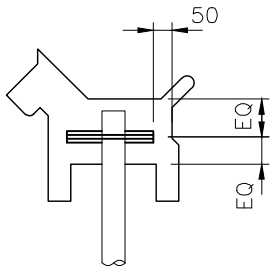

TYPICAL PANEL B FIXING DETAIL

SCALE: 1:20

| POST, FOOTING AND EMBEDMENT DETAILS | | | | |
|--------------------------------------|----------------|--------------------------------------|---------|-----------|
| SIGN NAME (REFER TO SHEETS 2 & 3) | NUMBER OF POST | TERRAIN CATEGORY = 1.5 AND ABOVE | | |
| | | POST (STEEL) DIAMETER x THICKNESS | FOOTING | EMBEDMENT |
| DOG OFF–LEASH SIGN – 1 | 1 | 114.3x3.6 CHS | 300 Dia | 1000 |
| DOG OFF–LEASH SIGN – 2 | 1 | 76.1x3.2 CHS | 300 Dia | 700 |
| PLAYGROUND NODE SIGN | 1 | 76.1x3.2 CHS | 300 Dia | 700 |

| STRUCTURAL DESIGN CERTIFICATION | | |
|---|--|--|
| DESIGN | DESIGN CHECK | AUTHORISED FOR ISSUE |
| Zhuangzhi Hu RPEQ 13885 2015.03.23 08:41:04 +10'00' | Lenita MendisRPEQ 8950 2015.03.23 08:46:25 +10'00' | Bala Balakumar RPEQ 3963 2015.03.23 11:47:41+10'00' |

| |
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GENERAL GRAPHIC NOTES FOR SIGNAGE

- ALL DIMENSIONS IN MILLIMETRES (U.N.O.).
- REFER TO BSD – 10501 (SHEETS 1 AND 2) FOR STRUCTURAL NOTES.
- REFER TO BSD – 10506 FOR ORDINANCE SIGNAGE DETAILS.
- REFER TO BSD – 10507 FOR PICTOGRAM SUITE DETAILS.
- REFER TO BSD – 10508 (SHEET 1 OF 4) FOR POST, FOOTING AND EMBEDMENT DETAILS.
- REFER TO BSD – 10508 (SHEET 3 OF 4) FOR EXAMPLE LAYOUTS.
- REFER TO BSD – 10508 (SHEET 4 OF 4) FOR DETAILED DIMENSIONS FOR DOG OFF–LEASH SIGNS 1 AND 2.

PANEL:

- PANEL COLOUR: 7 YEAR CAST VINYL BLUE (PMS 293 BLUE) U.N.O.

BCC LOGO AND CLEAT:

- BCC TAGLINE "Dedicated to a better Brisbane" TEXT FONT: Bembo Italic.
- BCC LOGO AND TAGLINE TO BE SCALED AS SHOWN IN THE TABLE BELOW. ENSURE CORRECT LOGO IS USED, PERMISSION FOR USE GRANTED BY CORPORATE COMMUNICATION, BRISBANE CITY COUNCIL.
- (BCC LOGO TO BE FULL COLOUR WITH 5mm WHITE BORDER AND NON–REFLECTIVE).
- BCC CLEAT SIZE AS PER BELOW TABLE.
- BCC CLEAT COLOUR TO COMMENCE ON BLUE UNIT AT TOP OF THE PANEL AND FINISH WITH A WHOLE CLEAT UNIT AT THE BOTTOM OF THE PANEL. CLEAT YELLOW TO BE 7 YEAR CAST VINYL YELLOW (PMS 116 YELLOW).
- BCC WEBSITE – www.brisbane.qld.gov.au. TO BE POSITIONED UNDER BCC CONTACT NUMBER ONLY WHEN SIGN CONVEYS INFORMATION THAT IS SPECIFICALLY REFERRED TO ON BRISBANE CITY COUNCIL WEBSITE.

TEXT FONT TYPE AND SIZE:

- TEXT FONT: AVENIR MEDIUM.
- TEXT SIZES AS PER BELOW TABLE (U.N.O)
- FONT COLOUR (FOR MAIN TEXT FONT AND TAGLINE TEXT FONT): 7 YEAR CAST VINYL WHITE WHERE PANEL COLOUR IS PMS 293 BLUE.
- TEXT SIZES LISTED BELOW ARE TO BE USED AS A GUIDE ONLY.

STANDARD PARK ORDINANCE SIGNAGE – GRAPHIC STANDARDS

- PICTOGRAM IMAGES TO BE SOURCED VIA CITY PROJECTS OFFICE/CORPORATE COMMUNICATIONS – BRISBANE CITY COUNCIL.

OTHER COLOURS (WHERE APPLICABLE):

BLUE – PMS 293 BLUE

GREEN – PMS 355 GREEN

YELLOW – PMS 116 YELLOW

RED – PMS 485 RED

COLOURS NOT LISTED ABOVE ARE TO BE APPROVED PRIOR TO MANUFACTURE. OTHER COLOURS MAY BE APPLICABLE WITH PRIOR APPROVAL.

| ALTERNATIVE TEXT SIZES | | | | |
|---|--|---|--|--|
| SIGN CATEGORY DESCRIPTIONS | | TEXT RANGE | | |
| INTERPRETIVE, MINOR INFORMATION SIGNS | | 10mm MIN. 15–25mm PREFERRED. HEADINGS 25–45mm | | |
| LARGE HEADINGS, WARNING SIGNS, MINOR IDENTIFICATION NAMES | | 50mm–100mm | | |
| PARK NAMES, MAJOR INFORMATION | | 130mm–150mm | | |



NOTE:

ALTERNATIVE TEXT SIZES ARE TO BE READ IN CONJUNCTION WITH STANDARD TEXT SIZES SHOWN IN PANEL TYPE GRAPHIC DETAILS TABLE.

SIGN PANEL GRAPHIC DETAILS

| SIGNAGE/PANEL TYPE (REFER TO SHEETS 2 &3) | CLEAT UNIT SIZE (H X W) | | LOGO HEIGHT INCLUDING TAGLINE | CLEAR SPACE AROUND LOGO/OFFSET FROM EDGE OF PANEL (MIN) | TEXT OFFSET FROM EDGE OF PANEL | HEADING TEXT SIZE | SUB HEADING TEXT SIZE | BODY TEXT SIZE |
|--|-------------------------------|----|--|---|--------------------------------------|----------------------|-----------------------------|-------------------|
| | | | | | | | | |
| DOG OFF–LEASH SIGN – 1 (PANEL A) | N/A | | 120 | 25 | 35 | 50 | 26 | 20 |
| DOG OFF–LEASH SIGN – 2 (PANEL B) | N/A | | 58 | 20 | 35 | 30 | 20 | 18 |
| DOG OFF–LEASH SIGN – ½ (PANEL C) | 20 | 10 | 60 | 13 | 20 | 30 | 20 | 18 |
| PLAYGROUND NODE SIGN – (PANEL D) | 45 | 25 | 74 | 20 | 42 | 140 | N/A | N/A |


COLOUR LOGOS – POSITIVE AND REVERSE VERSIONS

| | |
|--|--|
| COLOUR POSITIVE:  <i>Dedicated to a better Brisbane</i> | NOTE THE BACKGROUND REPRESENTS THE LIGHT COLOUR OF ARTWORK |
| COLOUR REVERSE:  <i>Dedicated to a better Brisbane</i> | NOTE THE BACKGROUND REPRESENTS THE DARK COLOUR OF ARTWORK |


NOTE:

COUNCIL'S POSITIVE LOGO IS USED ON WHITE OR LIGHT BACKGROUND COLOURS. THE POSITIVE LOGO DOES NOT HAVE A KEYLINE AROUND THE CITY HALL SQUARE BLOCK AND THE TAGLINE APPEARS IN BLACK LETTERING. THE REVERSE LOGO IS USED WHEN THE LOGO NEEDS TO BE VISIBLE ON A BLACK, DARK BLUE OR OTHER DARK COLOUR BACKGROUND. THE REVERSE LOGO FEATURES A WHITE KEYLINE AROUND THE CITY HALL SQUARE BLOCK AND THE TAGLINE APPEARS IN WHITE LETTERING. TO ENSURE THE REVERSE LOGO IS CORRECT, ALWAYS APPLY A REVERSE LOGO FILE AVAILABLE FROM CORPORATE COMMUNICATION TO ARTWORK WITH A DARK BACKGROUND. THE REVERSE LOGO SHOULD NOT BE "CONSTRUCTED" FROM THE POSITIVE LOGO BY CHANGING A KEYLINE OR LETTERING COLOURS.

IMAGE LOGO
ACCESS DENIED
FOR REINER – NOT
LOADING

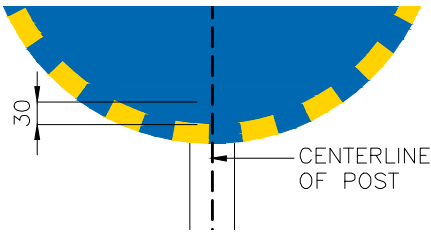

PLAYGROUND NODE SIGN –
LOGO LOCATION DETAIL

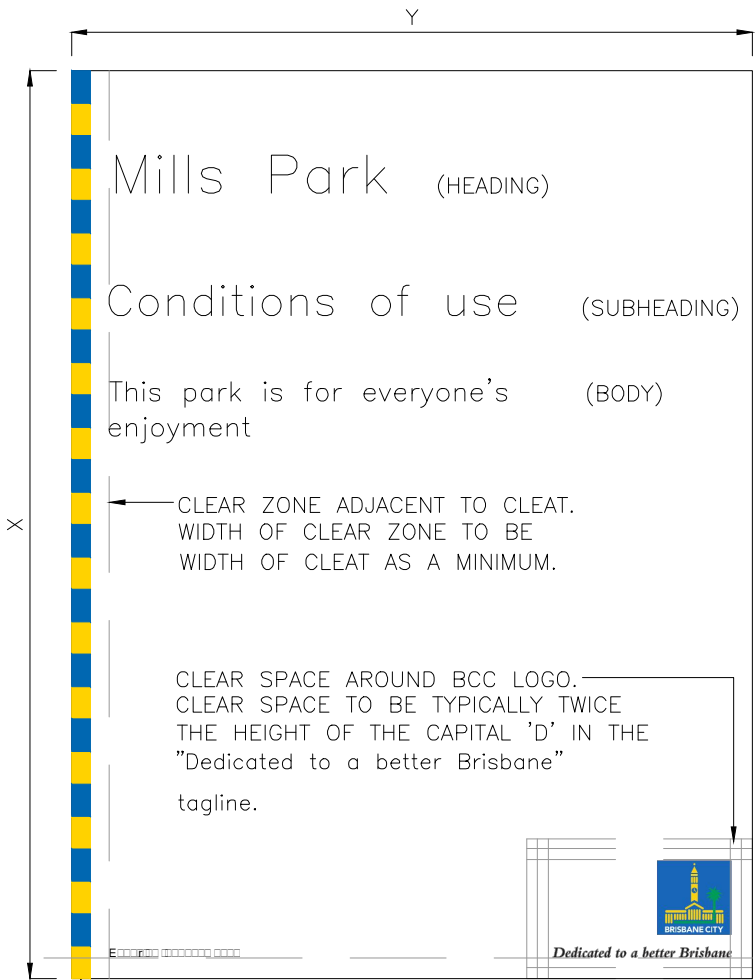


TYPICAL GRAPHIC LAYOUT


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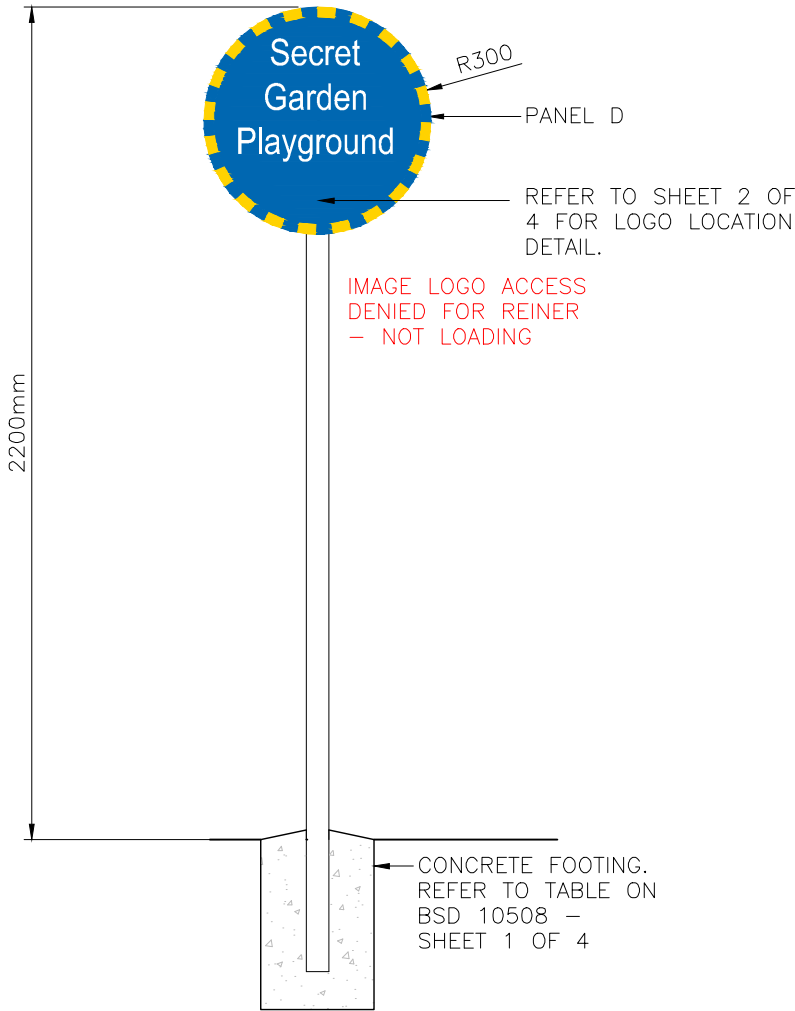
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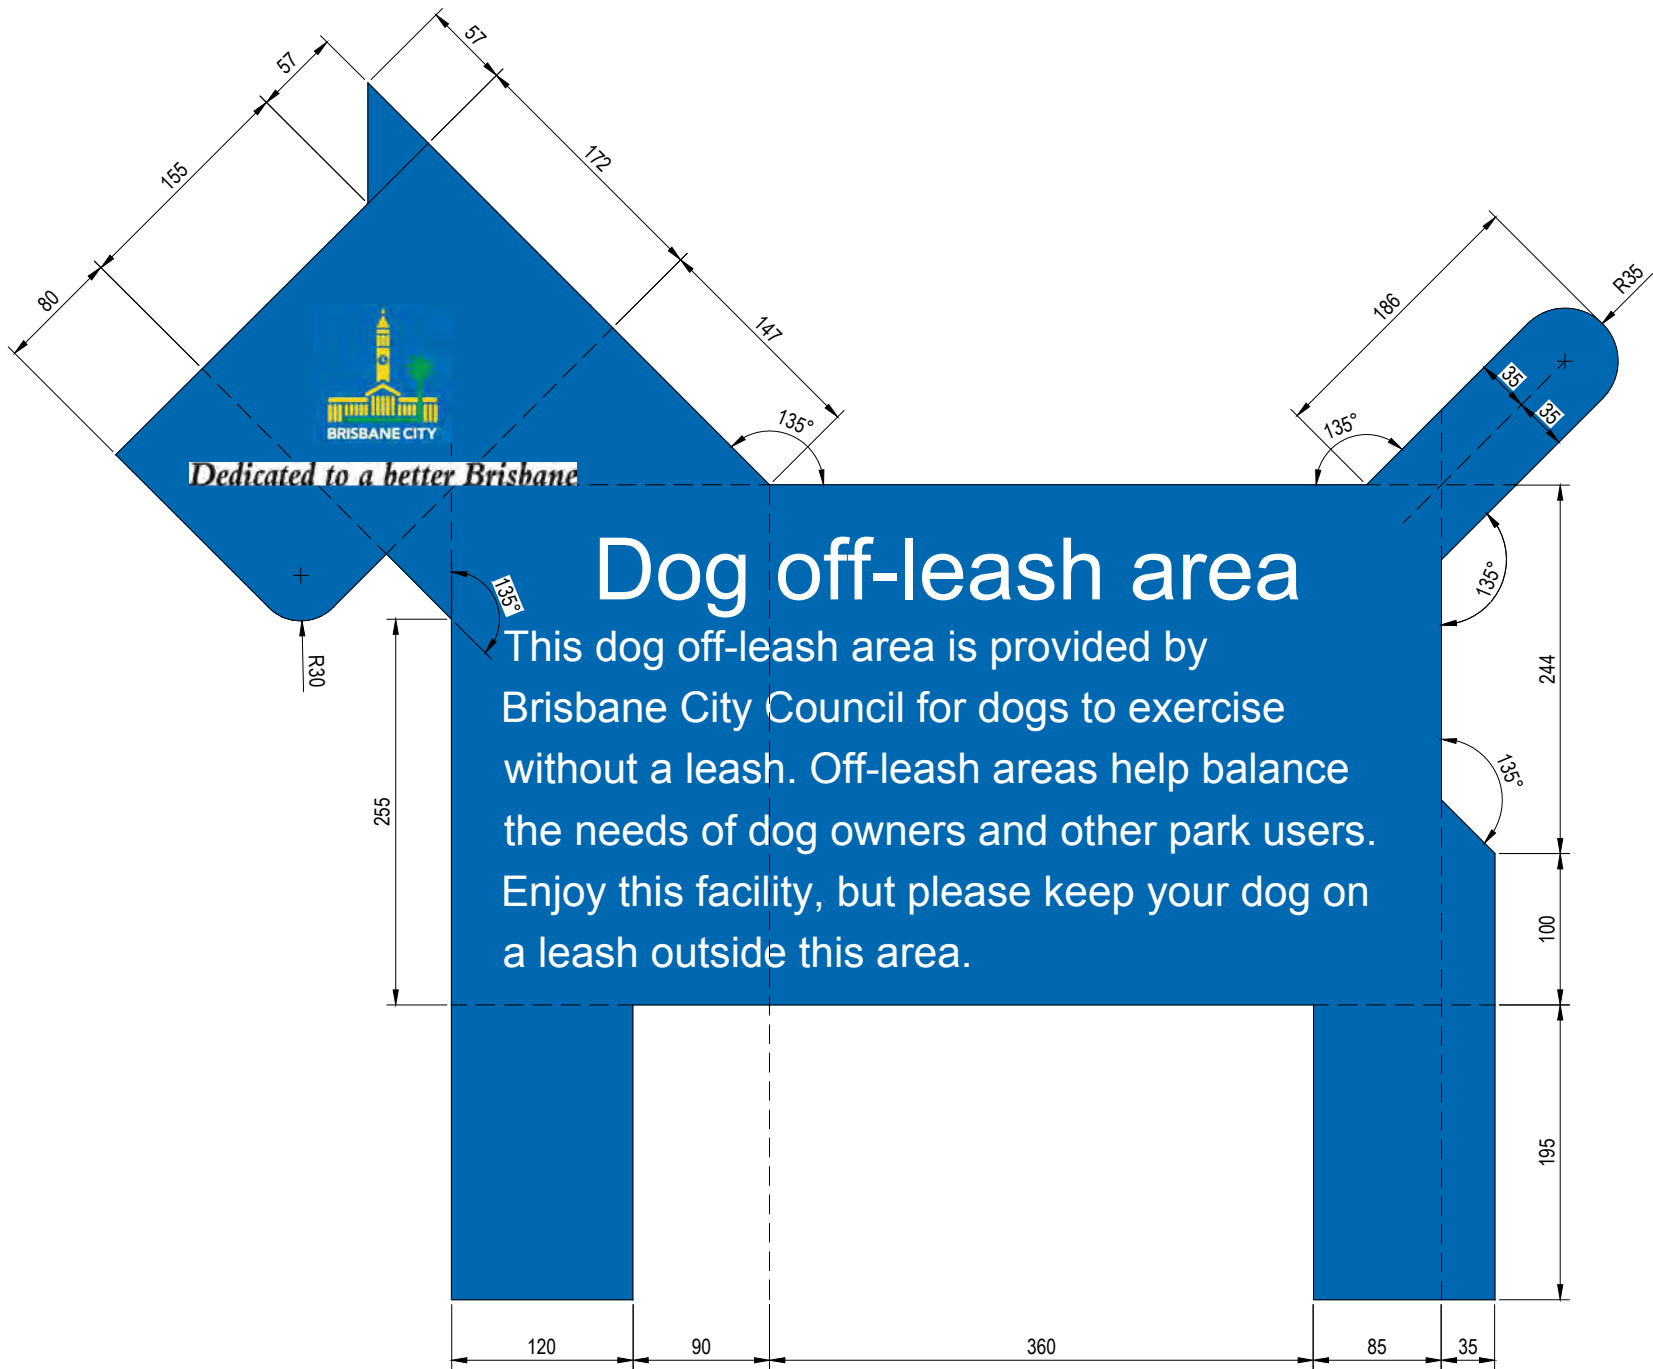


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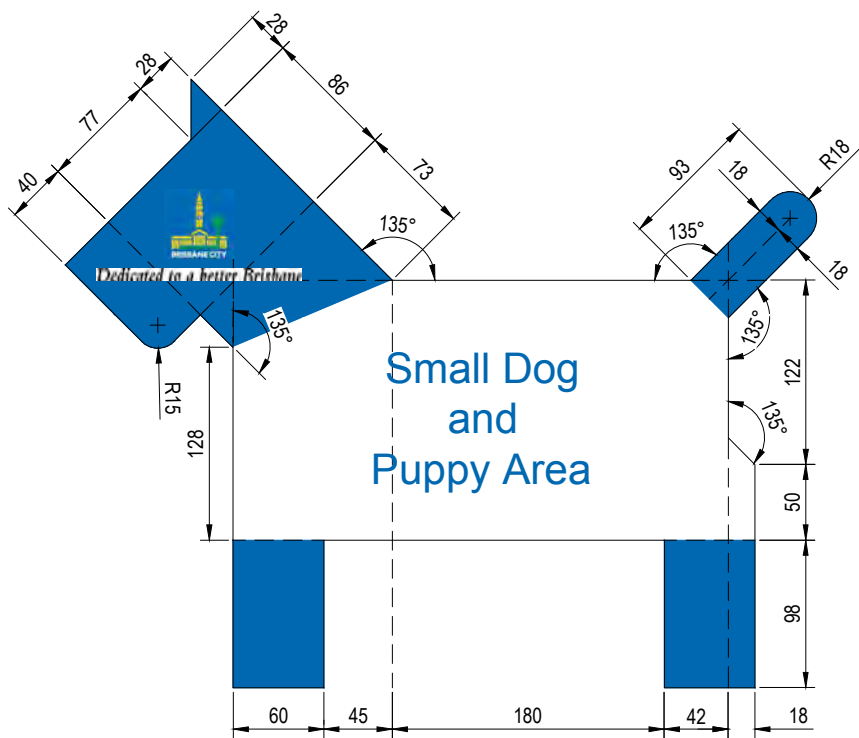
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
- 1. ALL DIMENSIONS IN MILLIMETRES (U.N.O.).
- 2. REFER TO BSD-10501 (SHEETS 1 AND 2) FOR STRUCTURAL NOTES.
- 3. REFER TO BSD-10506 FOR ORDINANCE SIGNAGE DETAILS.
- 4. REFER TO BSD-10507 FOR PICTOGRAM SUITE DETAILS.
- 5. REFER TO BSD-10508 (SHEET 1 OF 4) FOR POST, FOOTING AND EMBEDMENT DETAILS.
- 6. REFER TO BSD-10508 (SHEET 2 OF 4) FOR GRAPHIC NOTES.
- 7. REFER TO BSD-10508 (SHEET 3 OF 4) FOR EXAMPLE LAYOUTS

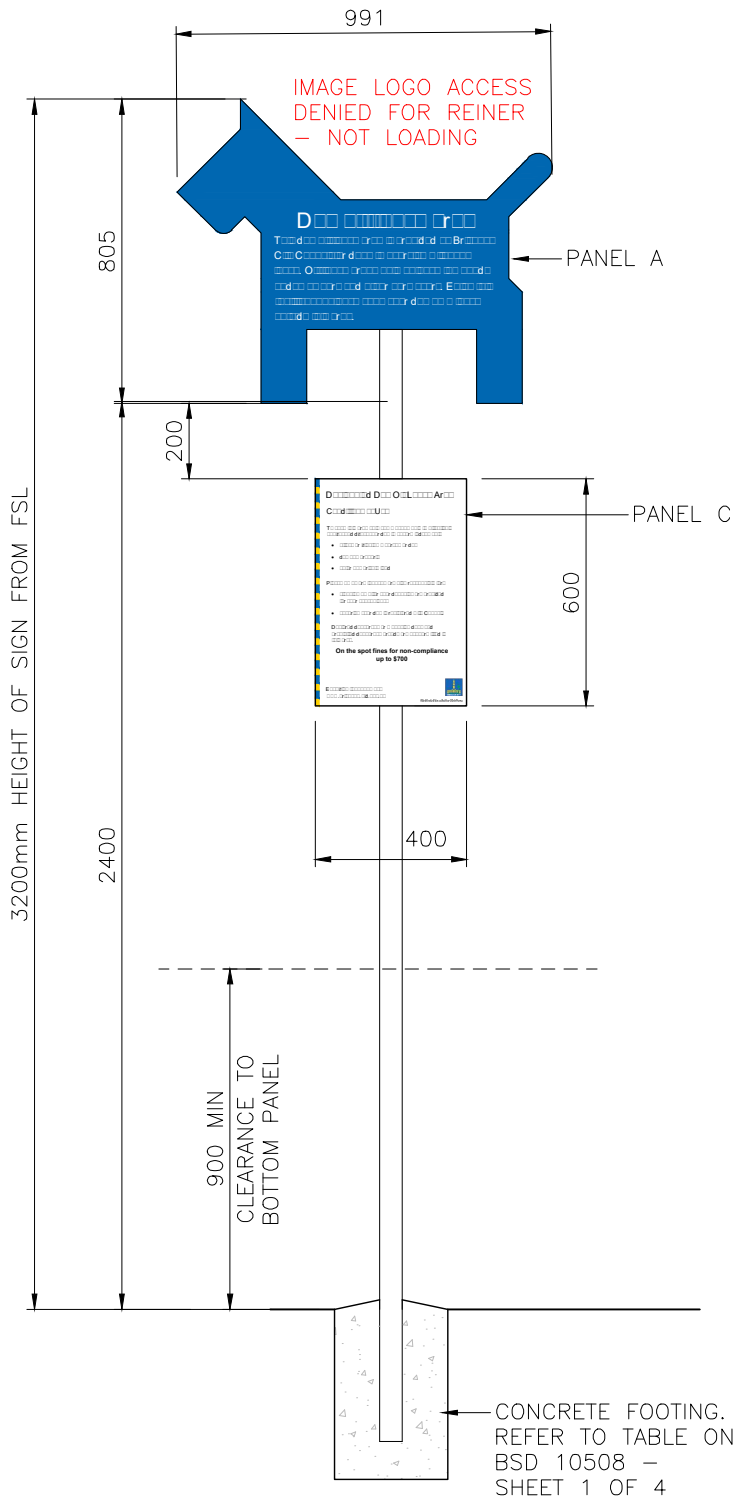

DOG OFF-LEASH SIGN - 1
PANEL A DETAIL
SCALE: 1:5

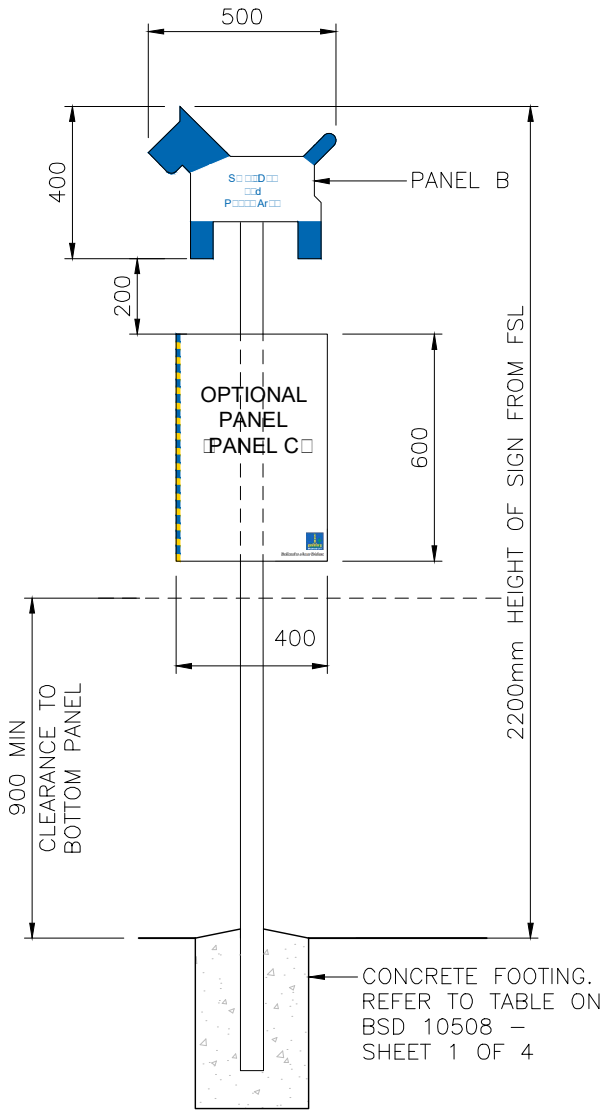

DOG OFF-LEASH SIGN - 2
PANEL B DETAIL
SCALE: 1:5

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| | | | | | DRAWING AUTHORISED FOR PUBLICATION | | | | DESIGN | CPO – P&D | DATE | MAR '15 |  | BRISBANE CITY COUNCIL STANDARD DRAWING | | | |
| | | | | | Inga Condric 2015.06.04 15:50:29+10'00' | | | | DRAWN | CPO – P&D | DATE | MAR '15 | | | | | |
| | | | | | FOR ASSET ENGINEERING MANAGER STRATEGIC ASSET MANAGEMENT | | | | CHECKED | CPS – NEWS | DATE | MAR '15 | | PARK NODE SIGNAGE DOG OFF LEASH SIGN DETAIL SHEET 4 OF 4 | | SCALE 1:5 | |
| B | Council Logo Shown on Signs (Previously Omitted) | JAN '19 | APR '19 | APR '19 | DESIGN APPROVED | | | | DRAWING FILENAME | BSD-10508 (B) Park Node Signage - Dog Off Leash Sign Detail - Sheet 4 of 4.dwg | | | | | | Dwg No. BSD-10508 | |
| A | Drawing Converted From UMS Series March 2015 | MAR '15 | MAR '15 | MAR '15 | DANNY VAN DER WALLE SIGNATURE ON ORIGINAL APRIL 2014 | | | | ASSOCIATED PLANS | BSD-10508 SHEETS 1, 2 & 3.dwg | | | | | | ORIGINAL SIZE A3 | |
| ISSUE | AMENDMENT | DRAWN DATE | CHK'D DATE | APPR'D DATE | SENIOR CO-ORDINATOR PARKS | | | | | | | REVISION B | | | | | |
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GENERAL SIGN NOTES

- ALL DIMENSIONS IN MILLIMETRES (U.N.O.).
- REFER TO BSD – 10501 (SHEETS 1 AND 2) FOR STRUCTURAL NOTES.
- REFER TO BSD – 10507 FOR PICTOGRAM SUITE DETAILS.
- REFER TO BSD – 10509 (SHEET 2 OF 4) FOR GRAPHIC NOTES.
- REFER TO BSD – 10509 (SHEET 3 OF 4) FOR GRAPHIC SETOUT DETAILS.
- REFER TO BSD – 10509 (SHEET 4 OF 4) FOR DIRECTIONAL SIGNAGE TYPICAL LAYOUTS.

SIGNAGE PANELS C AND D:

- PANELS TO BE 16 GAUGE, 1.6mm THICK ALUMINIUM SHEETING.
- CORNERS OF PANEL TO HAVE 5mm RADIUS WITH ALL CORNERS / EDGES TO BE FREE OF BURRS.
- ANTI-GRAFFITI CLEAR FILM OR SIMILAR PRODUCT TO FINISHED SURFACE OF PANEL.

SIGNAGE STIFFENING RAILS:


- REFER TO DEPARTMENT OF TRANSPORT AND MAIN ROADS DRAWING 1369 FOR DETAILS OF SIGN RAIL EXTRUSIONS.
- SIGN RAIL TO BE 44mm WIDE X 40mm DEEP AND 3mm THICK. (TYPE 2A AS PER TRANSPORT AND MAIN ROADS DRAWING 1369).
- SIGN RAIL TO BE POP RIVETED TO SIGN USING 'HENHUB' SELF PIERCING RIVETING SYSTEM OR SIMILAR APPROVED. AT A SPACING BETWEEN 250–300mm APART DEPENDING ON BEST PLACEMENT IN RELATION TO SIGN DESIGN / PANEL COMBINATIONS.
- SIGN RAILS ARE TO BE TYPICALLY POSITIONED 100mm IN FROM TOP AND BOTTOM EDGE OF SIGN AND 50mm FROM SIDE EDGES OF SIGN. IN SOME CASES THIS IS TO VARY TO ENSURE SIGN TEXT AND GRAPHICS ARE UNOBSTRUCTED BY FIXING HOLES.

SIGNAGE POSTS:

- POSTS ARE TO BE POSITIONED 160mm (UNLESS OTHERWISE SHOWN) FROM EDGE OF PANEL OR PLACED CENTRALLY ON SIGN.
- SIGNS ARE TO BE ATTACHED TO POSTS USING STANDARD (API BRAND) SADDLE BRACKETS TO SUIT SIZE OF POST. SADDLE BRACKETS TO BE STAINLESS STEEL WITH STAINLESS STEEL NUTS AND BOLTS.
- BLACK PLASTIC CAPS TO BE INSTALLED TO END OF POSTS. END CAPS TO SUIT POST SIZE AS SPECIFIED.


SIGNAGE PANELS A AND B:

- REFER TO BSD–3102 FOR FIXING DETAILS FOR OPTIONS 1 AND 2 (AS SHOWN ON SHEET 4 OF 4).

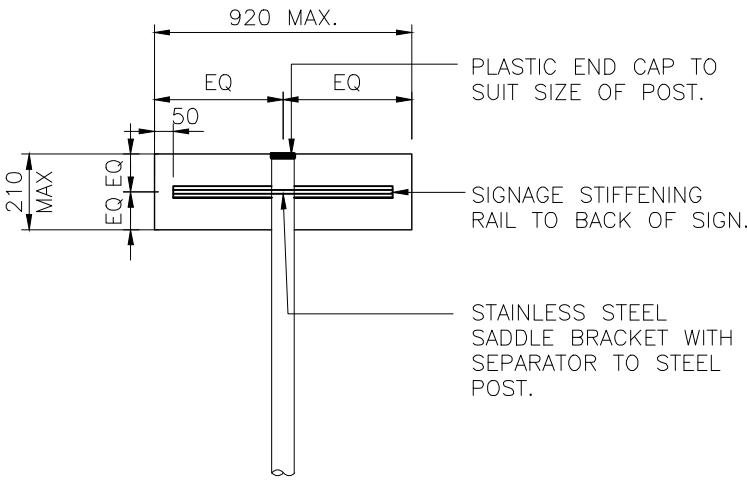


SINGLE (1) POST TO PANEL B
OPTION 3 FIXING DETAIL ONLY

SCALE: 1:20

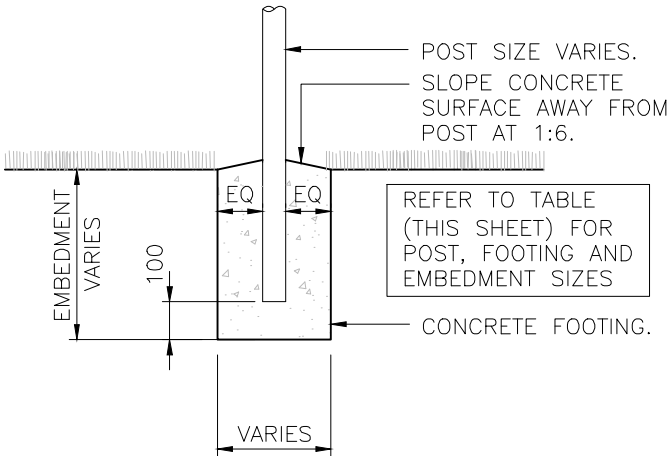


CONCRETE FOOTING DETAIL
SINGLE POST

SCALE: 1:20

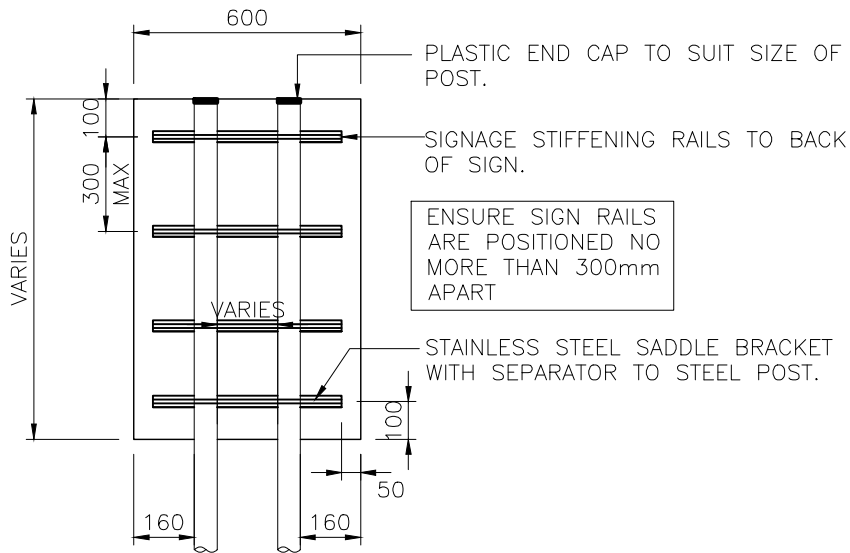

DOUBLE (2) POST TO PANELS C & D
FIXING DETAIL

SCALE: 1:20

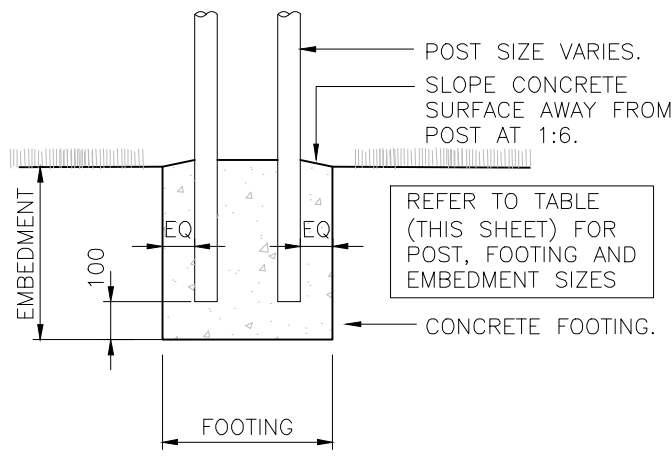

CONCRETE FOOTING DETAIL
DOUBLE POST

SCALE: 1:20


| POST, FOOTING AND EMBEDMENT DETAILS | | | | |
|--------------------------------------|-------------------|--------------------------------------|---------|-----------|
| SIGN NAME (REFER TO SHEET 3) | NUMBER OF POST | TERRAIN CATEGORY = 1.5 AND ABOVE | | |
| | | POST (STEEL) DIAMETER x THICKNESS | FOOTING | EMBEDMENT |
| DIRECTIONAL SIGN – OPTION 1 | 1 | 114.3x3.2 CHS | 300 Dia | 900 |
| DIRECTIONAL SIGN – OPTION 2 AND 3 | 1 | 88.9x3.2 CHS | 300 Dia | 800 |
| DIRECTIONAL PARK MAP SIGN | 2 | 60.3x2.9 CHS | 450 Dia | 1000 |


| STRUCTURAL DESIGN CERTIFICATION | | |
|--|--|--|
| DESIGN | DESIGN CHECK | AUTHORISED FOR ISSUE |
| Zhuangzhi Hu RPEQ 13885 2015.03.20 11:45:20 +10'00' | Lenita MendisRPEQ 8950 2015.03.20 12:10:59 +10'00' | Bala Balakumar RPEQ 3963 2015.03.20 14:03:10+10'00' |
| BRISBANE CITY COUNCIL STANDARD DRAWING | | |
| PARK DIRECTIONAL SIGNAGE TYPICAL INSTALLATION DETAILS SHEET 1 OF 4 | | SCALE AS SHOWN DWG No. BSD–10509 ORIGINAL SIZE A3 REVISION A |

| | | | | | | | | | |
|-------|--|---------------|---------------|----------------|---|---------------------|--|------|---------|
| | | | | | DRAWING AUTHORISED FOR PUBLICATION | DESIGN | CPD – P&D | DATE | MAR '15 |
| | | | | | Inga Condric 2015.06.04 15:51:03+10'00' | DRAWN | CPD – P&D | DATE | MAR '15 |
| | | | | | for ASSET ENGINEERING MANAGER STRATEGIC ASSET MANAGEMENT | CHECKED | CPS – NEWS | DATE | MAR '15 |
| | | | | | DESIGN APPROVED | | | | |
| A | Drawing Converted From UMS Series March 2015 | MAR '15 | MAR '15 | MAR '15 | DANNY VAN DER WALLE SIGNATURE ON ORIGINAL APRIL 2014 | DRAWING FILENAME | BSD-10509 (A) Park Directional Signage - Typical Installation Details - Sheet 1 of 4.dwg | | |
| ISSUE | AMENDMENT | DRAWN DATE | CHK'D DATE | APPR'D DATE | SENIOR CO-ORDINATOR PARKS | ASSOCIATED PLANS | BSD-10509 SHEETS 2, 3 & 4.dwg | | |




- ALL DIMENSIONS IN MILLIMETRES (U.N.O.).
- REFER TO BSD - 10501 (SHEETS 1 AND 2) FOR STRUCTURAL NOTES.
- REFER TO BSD - 10506 FOR ORDINANCE SIGNAGE DETAILS.
- REFER TO BSD - 10507 FOR PICTOGRAM SUITE DETAILS.
- REFER TO BSD - 10509 (SHEET 1 OF 4) FOR INSTALLATION NOTES AND DETAILS.
- REFER TO BSD - 10509 (SHEET 2 OF 4) FOR GRAPHIC NOTES.
- REFER TO BSD - 10509 (SHEET 4 OF 4) FOR DIRECTIONAL SIGNAGE TYPICAL LAYOUTS.

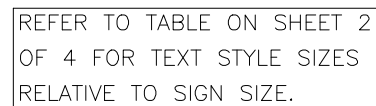

| | | | | | | | | | | | | | | |
|-------|--|---------------|---------------|----------------|--|---------------------|--|------|---------|---|---|---------------|-----------|--|
| | | | | | <div>DRAWING AUTHORISED FOR PUBLICATION</div> <div>Inga Condric 2015.06.04 15:52:41+10'00'</div> <div>for ASSET ENGINEERING MANAGER STRATEGIC ASSET MANAGEMENT</div> <div>DESIGN APPROVED</div> <div>DANNY VAN DER WALLE SIGNATURE ON ORIGINAL APRIL 2014</div> <div>SENIOR CO-ORDINATOR PARKS</div> | DESIGN | CPO - P&D | DATE | MAR '15 |  | BRISBANE CITY COUNCIL STANDARD DRAWING | | | |
| | | | | | | DRAWN | CPO - P&D | DATE | FEB '14 | | <div>PARK DIRECTIONAL SIGNAGE GRAPHIC SETOUT DETAILS SHEET 3 OF 4</div> | SCALE | | |
| | | | | | | CHECKED | CPS - NEWS | DATE | MAR '15 | | | DWG No. | BSD-10509 | |
| | | | | | | DRAWING FILENAME | BSD-10509 (A) Park Directional Signage - Graphic Setout Details - Sheet 3 of 4.dwg | | | | | ORIGINAL SIZE | REVISION | |
| A | Drawing Converted From UMS Series March 2015 | MAR '15 | MAR '15 | MAR '15 | | ASSOCIATED PLANS | BSD-10509 SHEETS 1, 2 & 4.dwg | | | | | A3 | A | |
| ISSUE | AMENDMENT | DRAWN DATE | CHK'D DATE | APPR'D DATE | | | | | | | | | | |

GENERAL SIGN NOTES


- ALL DIMENSIONS IN MILLIMETRES (U.N.O.).
- REFER TO BSD - 10501 (SHEETS 1 AND 2) FOR STRUCTURAL NOTES.
- REFER TO BSD - 10507 FOR PICTOGRAM SUITE DETAILS.
- REFER TO BSD - 10509 (SHEET 1 OF 4) FOR INSTALLATION NOTES AND DETAILS.
- REFER TO BSD - 10509 (SHEET 2 OF 4) FOR GRAPHIC NOTES.
- REFER TO BSD - 10509 (SHEET 3 OF 4) FOR GRAPHIC SETOUT DETAILS.

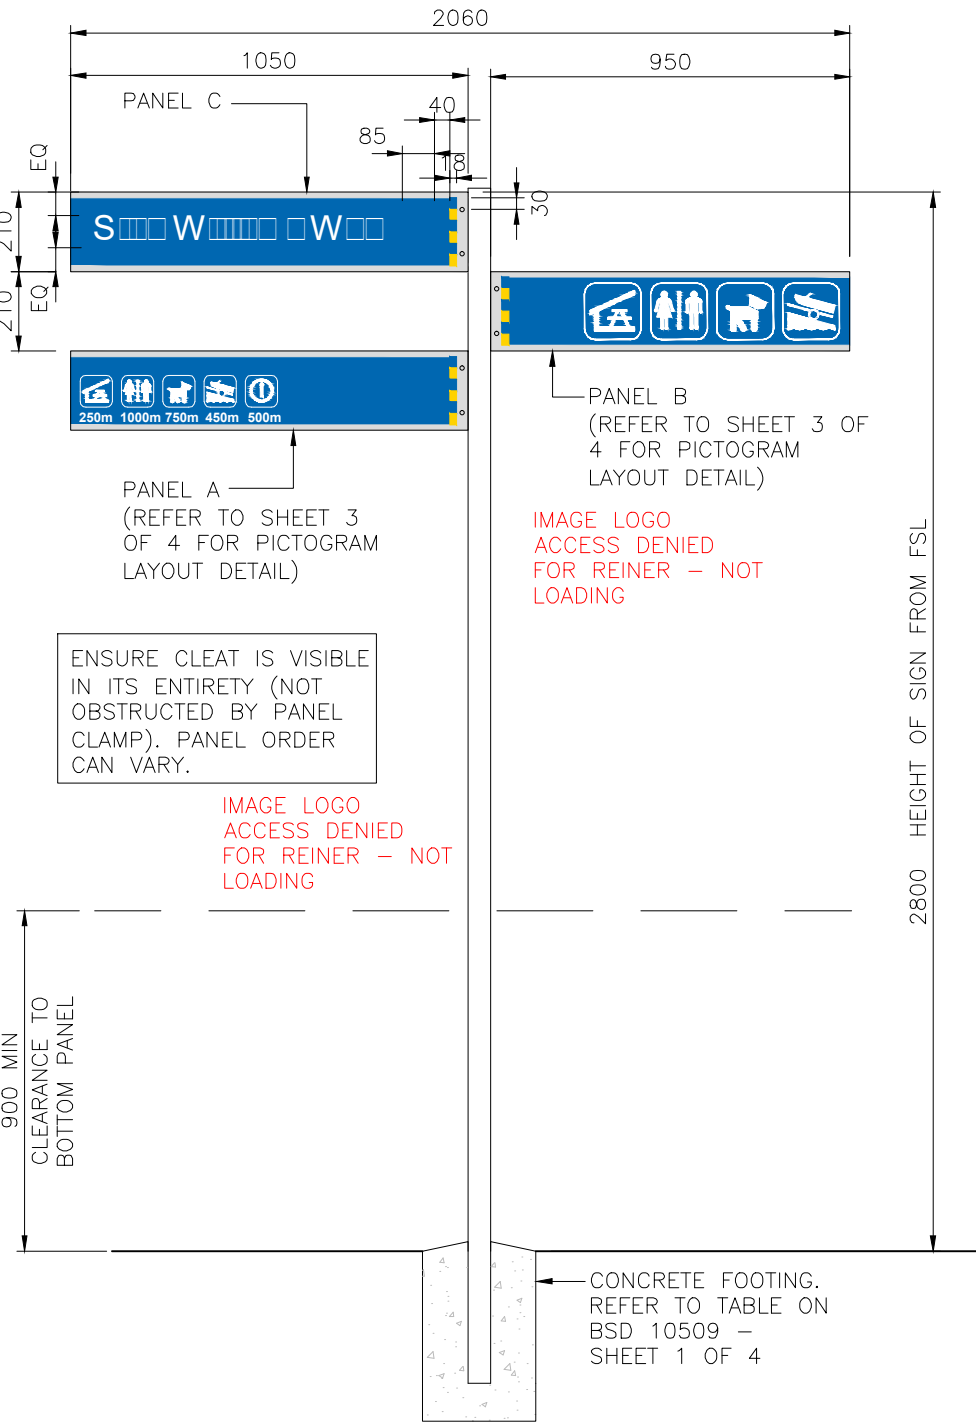


OPTION 1

DIRECTIONAL SIGNS

SCALE: 1:20

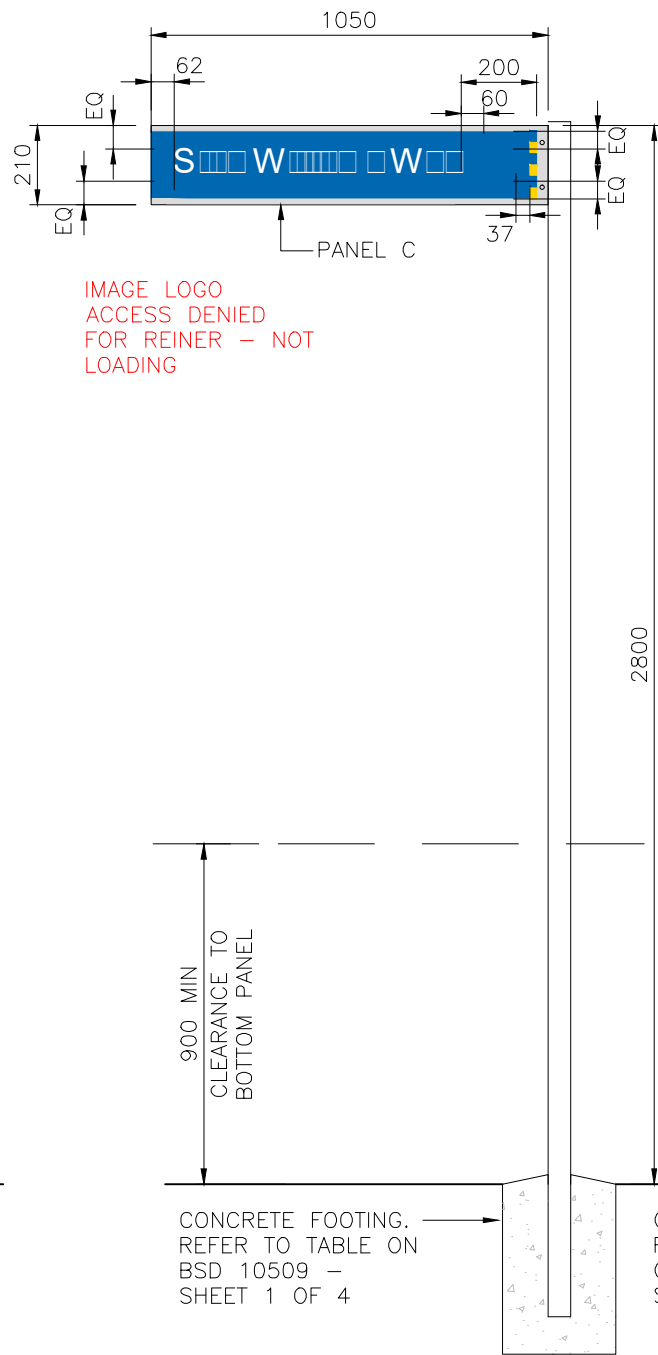


OPTION 2

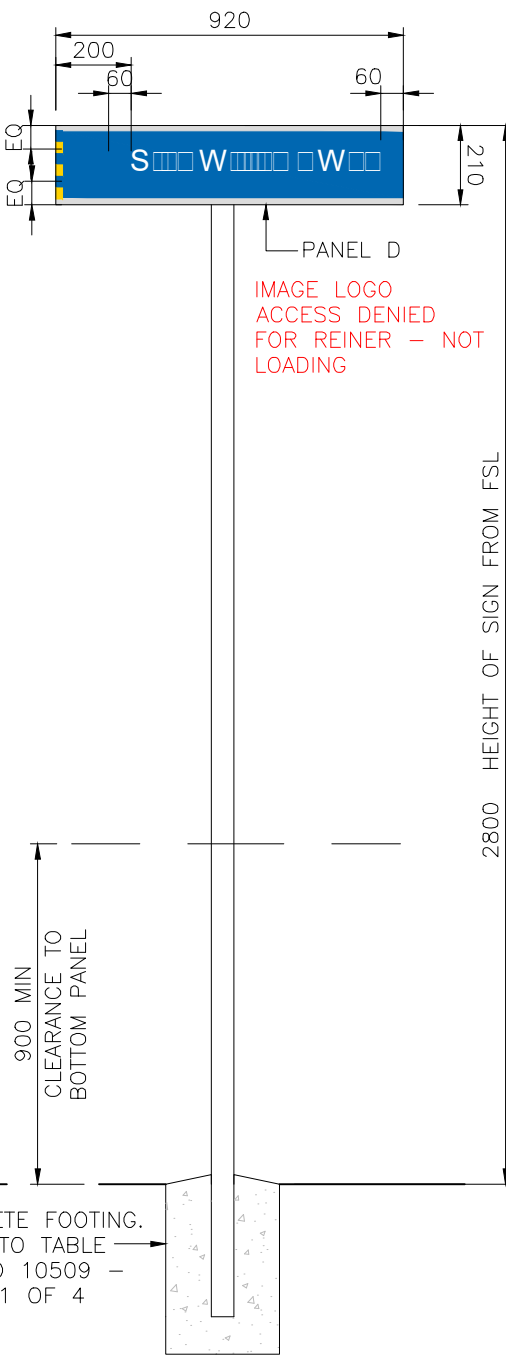

OPTION 3

(DIRECTIONAL/NODE)

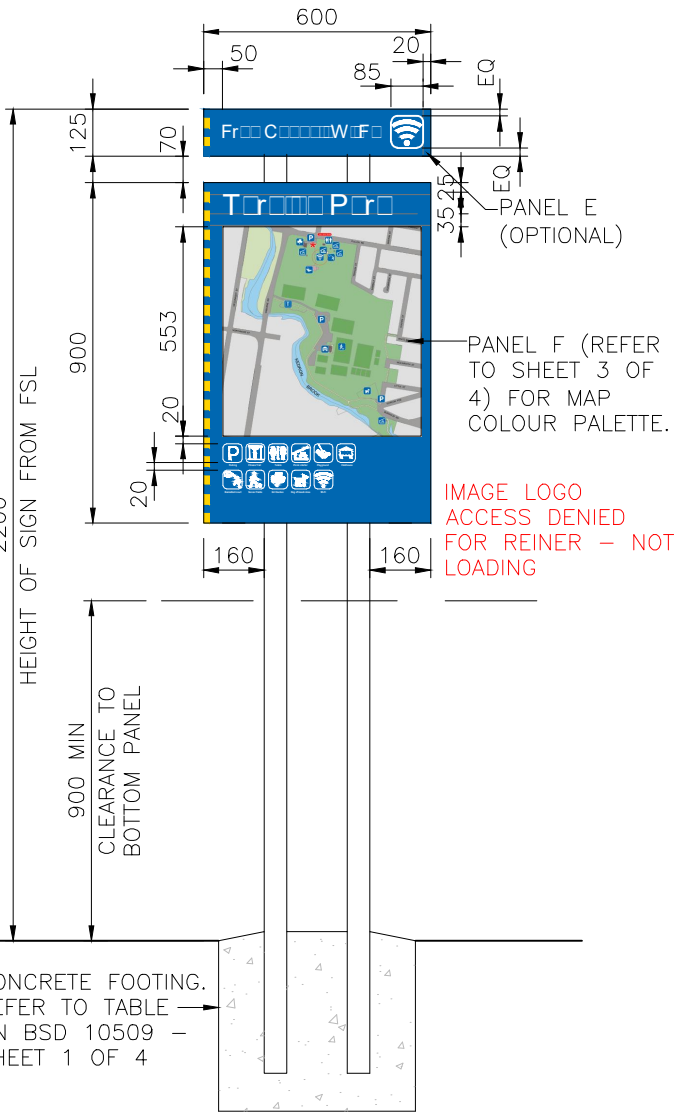

DIRECTIONAL PARK MAP SIGN

SCALE: 1:20

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GENERAL SIGN NOTES

SIGNAGE PANEL:

- PANELS TO BE 16 GAUGE, 1.6mm THICK ALUMINIUM SHEETING.
- CORNERS OF PANEL TO HAVE 5mm RADIUS WITH ALL CORNERS/EDGES TO BE FREE OF BURRS.
- ANTI-GRAFFITI CLEAR FILM OR SIMILAR PRODUCT TO FINISHED SURFACE OF PANEL.
- REFER TO BSD – 10510 – SHEET 5 OF 6 AND SHEET 6 OF 6 FOR SIZES OF SIGN PANELS, POSSIBLE LAYOUTS AND GRAPHIC NOTES.

SIGNAGE STIFFENING RAILS:

- REFER TO DEPARTMENT OF TRANSPORT AND MAIN ROADS DRAWING 1369 FOR DETAILS OF SIGN RAIL EXTRUSIONS.
- SIGN RAIL TO BE 44mm WIDE X 40mm DEEP AND 3mm THICK. (TYPE 2A AS PER TRANSPORT AND MAIN ROADS DRAWING 1369).
- SIGN RAIL TO BE POP RIVETED TO SIGN USING 'HENHUB' SELF PIERCING RIVETING SYSTEM OR SIMILAR APPROVED. AT A SPACING BETWEEN 250–300mm APART DEPENDING ON BEST PLACEMENT IN RELATION TO SIGN DESIGN / PANEL COMBINATIONS.
- SIGN RAILS ARE TO BE TYPICALLY POSITIONED 100mm IN FROM TOP AND BOTTOM EDGE OF SIGN AND 50mm FROM SIDE EDGES OF SIGN. IN SOME CASES THIS IS TO VARY TO ENSURE SIGN TEXT AND GRAPHICS ARE UNOBSTRUCTED BY FIXING HOLES.

SIGNAGE POSTS:

- SIGNS ARE TO BE ATTACHED TO POSTS USING STANDARD (API BRAND OR APPROVED SIMIALR) SADDLE BRACKETS TO SUIT SIZE OF POST. SADDLE BRACKETS TO BE STAINLESS STEEL WITH STAINLESS STEEL NUTS AND BOLTS.
- BLACK PLASTIC CAPS TO BE INSTALLED TO END OF POSTS. END CAPS TO SUIT POST SIZE AS SPECIFIED.

GENERAL NOTES

- G1 THESE DRAWINGS SHALL BE READ IN CONJUNCTION WITH ALL SPECIFICATIONS AND WITH SUCH OTHER WRITTEN INSTRUCTIONS AS MAY BE ISSUED.
- G2 ALL DIMENSIONS AND EXISTING CONDITIONS TO BE CHECKED BEFORE COMMENCING CONSTRUCTION. ANY DISCREPANCIES SHALL BE REFERRED TO THE SUPERINTENDENT FOR DECISION BEFORE PROCEEDING WITH THE WORK.
- G3 ALL WORKMANSHIP AND MATERIALS SHALL COMPLY WITH THE APPROPRIATE AND CURRENT AUSTRALIAN STANDARDS.
- G4 ALL DIMENSIONS ARE IN MILLIMETRES UNLESS NOTED OTHERWISE.
- G5 DIMENSIONS SHALL NOT BE OBTAINED BY SCALING THE STRUCTURAL DRAWINGS.
- G6 SETTING OUT DIMENSIONS SHOWN ON THE DRAWINGS SHALL BE VERIFIED ON SITE BEFORE CONSTRUCTION COMMENCES.
- G7 DURING CONSTRUCTION THE STRUCTURE SHALL BE MAINTAINED IN A STABLE CONDITION AND NO PART SHALL BE OVERSTRESSED.
- G8 U.N.O. DENOTES UNLESS NOTED OTHERWISE.
- G9 ALL TEMPORARY WORKS ARE TO BE DESIGNED AND CERTIFIED BY THE CONTRACTOR’S STRUCTURAL ENGINEER. ALL TEMPORARY WORKS ARE TO BE REMOVED AT THE END OF THE PROJECT WITH GROUND MADE GOOD, ALL AT THE CONTRACTOR’S EXPENSE.

G10 SAFETY PRECAUTIONS SHALL BE TAKEN TO AVOID INJURY TO PEOPLE. THE UNATTENDED FOOTING HOLES SHALL BE COVERED OR FENCED OFF AT ALL TIMES.

DESIGN DATA

WIND LOAD:
REGIONAL WIND SPEED : Ultimate V500=57m/s
 : Serviceability V25=39m/s
WIND REGION : B
TERRAIN CATEGORY : 1.5
SHIELDING MULTIPLIER (Ms) : 1.0
TOPOGRAPHIC MULTIPLIER (Mt) : 1.0

FOOTING NOTES

- F1 ALL FOOTINGS ARE TO BE FOUNDED IN ORIGINAL UNDISTURBED MATERIAL OF MINIMUM ALLOWABLE BEARING CAPACITY OF 100 kPa. BEFORE CONSTRUCTION COMMENCES, THE ALLOWABLE BEARING CAPACITY SHALL BE VERIFIED BY A QUALIFIED GEOTECHNICAL ENGINEER (RPEQ). IF SITE CONDITION IS DIFFERENT CONSULT A STRUCTURAL ENGINEER.
- F2 THE BOTTOMS OF ALL FOOTINGS ARE TO BE CLEANED OF ALL LOOSE MATERIAL, CLAY SEAMS, WATER ETC PRIOR TO CONCRETING.

CONCRETE NOTES

- C1. ALL WORKMANSHIP AND MATERIALS SHALL BE IN ACCORDANCE WITH AS3600
- C2. ALL CONCRETE SHALL BE PREMIXED BY AN APPROVED SUPPLIER.
- C3. ALL CEMENT SHALL BE TYPE GP OR GB TO AS3972 UNLESS OTHERWISE SPECIFIED.
- C4. ADMIXTURES SHALL NOT BE USED UNLESS APPROVED IN WRITING BY THE SUPERINTENDENT.
- C5. NOMINAL AGGREGATE SIZE TO BE 20mm SLUMP TO BE NOT GREATER THAN 80mm
- C6. CONCRETE STRENGTH AND CLEAR CONCRETE COVER TO REINFORCEMENT SHALL BE IN ACCORDANCE WITH THE FOLLOWING TABLE U.N.O.

| ELEMENT | CONCRETE GRADE | REINFORCEMENT COVER |
|----------------|----------------|---------------------|
| BLINDING LAYER | 15 | – |
| MASS CONCRETE | 15 | – |
| BORED PIERS | 25 | 50 |

C7. ALL LAPS IN REINFORCEMENT SHALL BE AS SHOWN IN THE TABLE BELOW UNLESS NOTED OTHERWISE.

| BAR | LENGTH | BAR | LENGTH |
|-----|--------|--------|--------|
| N12 | 500 | N28 | 500 |
| N16 | 650 | N32 | 650 |
| N20 | 800 | N36 | 800 |
| N24 | 1050 | FABRIC | 1050 |

C8. REINFORCEMENT SYMBOLS:


R STRUCTURAL PLAIN ROUND GRADE 250R TO AS4671.
N DEFORMED BAR GRADE D500N TO AS4671.
L COLD ROLLED DEFORMED BAR GRADE D500L TO AS4671.
SL HARD DRAWN STEEL REINFORCING FABRIC GRADE D500L TO AS4671.


C9. SIZES OF CONCRETE ELEMENTS DO NOT INCLUDE THICKNESS OF APPLIED FINISHES.

C10. NO HOLES, CHASES OR EMBEDMENT OF PIPES OTHER THAN THOSE SHOWN ON THE STRUCTURAL DRAWINGS SHALL BE MADE IN CONCRETE MEMBERS WITHOUT PRIOR APPROVAL BY THE SUPERINTENDENT.

C11. ALL CONCRETE SHALL BE COMPACTED USING A MECHANICAL VIBRATION PROCESS.

C12. FORMWORK SHALL BE DESIGNED, CONSTRUCTED AND STRIPPED IN ACCORDANCE WITH AS 3610. REFER TO THE SPECIFICATION FOR CLASSES OF SURFACE FINISHES.

| STRUCTURAL DESIGN CERTIFICATION | | | | | | | | | |
|---|--|--|--|--|--|---|----------------|--|---|
| DESIGN | | | | | DESIGN CHECK | | | AUTHORISED FOR ISSUE | |
| Zhuangzhi Hu RPEQ 13885 2015.03.20 11:45:46+10'00' | | | | | Lenita MendisRPEQ 8950 2015.03.20 12:12:03 +10'00' | | | Bala Balakumar RPEQ 3963 2015.03.20 14:03:47+10'00' | |
| BRISBANE CITY COUNCIL STANDARD DRAWING | | | | | | | | | |
| PARK NAME SIGNAGE GENERAL STRUCTURAL NOTES SHEET 1 OF 6 | | | | | SCALE 1:20 | | | | |
| | | | | | DWG No. BSD-10510 | | | | |
| | | | | | ORIGINAL SIZE A3 | | REVISION A | | |
| DRAWING AUTHORISED FOR PUBLICATION | | | | | DESIGN | CPO - P&D | DATE | MAR '15 |  |
| Inga Condric 2015.06.04 15:54:48+10'00' | | | | | DRAWN | CPO - P&D | DATE | MAR '15 | |
| for ASSET ENGINEERING MANAGER STRATEGIC ASSET MANAGEMENT | | | | | CHECKED | CPS - NEWS | DATE | MAR '15 | |
| DESIGN APPROVED | | | | | DRAWING FILENAME | BSD-10510 (A) Park Name Signage - General Structural Notes - Sheet 1 of 6.dwg | | | |
| DANNY VAN DER WALLE SIGNATURE ON ORIGINAL APRIL 2014 | | | | | ASSOCIATED PLANS | BSD-10510 SHEETS 2, 3, 4, 5 & 6.dwg | | | |
| SENIOR CO-ORDINATOR PARKS | | | | | | | | | |
| | | | | | | | | | |
| | | | | | | | | | |
| | | | | | | | | | |
| A | Drawing Converted From UMS Series March 2015 | | | | MAR '15 | MAR '15 | MAR '15 | | |
| ISSUE | AMENDMENT | | | | DRAWN DATE | CHK'D DATE | APPR'D DATE | | |

| | | | | | | | | | | | | | | | | | | | | | | | | | |
|-------|--|--|--|--|--|---------------|--|---------------|--|---|--|---|--|--|--|---------|--|---|---|--|--|--|---------------|--|--|
| | | | | | | | | | | STRUCTURAL DESIGN CERTIFICATION | | | | | | | | | | | | | | | |
| | | | | | | | | | | DESIGN | | DESIGN CHECK | | AUTHORISED FOR ISSUE | | | | | | | | | | | |
| | | | | | | | | | | Zhuangzhi Hu RPEQ 13885 2015.03.19 14:02:26+10'00' | | Lenita Mendis RPEQ 8950 2015.03.20 09:35:38+10'00' | | Bala Balakumar RPEQ 3963 2015.03.20 14:04:21+10'00' | | | | | | | | | | | |
| | | | | | | | | | | DESIGN | | CPO - P&D | | DATE | | MAR '15 | |  | BRISBANE CITY COUNCIL STANDARD DRAWING | | | | | | |
| | | | | | | | | | | DRAWN | | CPO - P&D | | DATE | | MAR '15 | | | PARK NAME SIGNAGE GENERAL STRUCTURAL NOTES SHEET 2 OF 6 | | | | SCALE 1:20 | | |
| | | | | | | | | | | CHECKED | | CPS - NEWS | | DATE | | MAR '15 | | | DWG No. BSD-10510 | | | | | | |
| | | | | | | | | | | DRAWING FILENAME | | BSD-10510_SHEET 2 of 6.dwg | | | | | | | ORIGINAL SIZE A3 | | | | REVISION A | | |
| | | | | | | | | | | ASSOCIATED PLANS | | BSD-10510 SHEETS 1, 3, 4, 5 & 6.dwg | | | | | | | | | | | | | |
| | | | | | | | | | | DRAWING AUTHORISED FOR PUBLICATION | | | | | | | | | | | | | | | |
| | | | | | | | | | | Ingo Condric 2015.06.04 15:55:28+10'00' | | | | | | | | | | | | | | | |
| | | | | | | | | | | for ASSET ENGINEERING MANAGER STRATEGIC ASSET MANAGEMENT | | | | | | | | | | | | | | | |
| | | | | | | | | | | DESIGN APPROVED | | | | | | | | | | | | | | | |
| | | | | | | | | | | DANNY VAN DER WALLE SIGNATURE ON ORIGINAL APRIL 2014 | | | | | | | | | | | | | | | |
| | | | | | | | | | | SENIOR CO-ORDINATOR PARKS | | | | | | | | | | | | | | | |
| A | | Drawing Converted From UMS Series March 2015 | | | | MAR '15 | | MAR '15 | | MAR '15 | | | | | | | | | | | | | | | |
| ISSUE | | AMENDMENT | | | | DRAWN DATE | | CHK'D DATE | | APPR'D DATE | | | | | | | | | | | | | | | |

GENERAL GRAPHIC NOTES FOR SIGNAGE

- ALL DIMENSIONS IN MILLIMETRES (U.N.O.).
- REFER TO BSD – 10507 FOR PICTOGRAM SUITE DETAILS.
- REFER TO BSD – 10510 (SHEETS 1 AND 2) FOR STRUCTURAL NOTES.
- REFER TO BSD – 10510 (SHEET 4 OF 6) FOR GRAPHIC SETOUT DETAILS.
- REFER TO BSD – 10510 (SHEET 5 OF 6) FOR PARK NAME SIGN – HORIZONTAL – STANDARD – INSTALLATION NOTES.
- REFER TO BSD – 10510 (SHEET 6 OF 6) FOR PARK NAME SIGN – VERTICAL – ALTERNATIVE – INSTALLATION NOTES.

PANEL:

- PANEL COLOUR: 7 YEAR CAST VINYL BLUE (PMS 293 BLUE) U.N.O.

BCC LOGO AND CLEAT:

- BCC TAGLINE "Dedicated to a better Brisbane" TEXT FONT: Bembo Italic.
- BCC LOGO AND TAGLINE TO BE SCALED AS SHOWN IN THE TABLE BELOW. ENSURE CORRECT LOGO IS USED, PERMISSION FOR USE GRANTED BY CORPORATE COMMUNICATION, BRISBANE CITY COUNCIL.
- (BCC LOGO TO BE FULL COLOUR WITH 5mm WHITE BORDER AND NON-REFLECTIVE).
- BCC CLEAT SIZE AS PER BELOW TABLE.
- BCC CLEAT COLOUR TO COMMENCE ON BLUE UNIT AT TOP OF THE PANEL AND FINISH WITH A WHOLE CLEAT UNIT AT THE BOTTOM OF THE PANEL. CLEAT YELLOW TO BE 7 YEAR CAST VINYL YELLOW (PMS 116 YELLOW).
- BCC WEBSITE – www.brisbane.qld.gov.au. TO BE POSITIONED UNDER BCC CONTACT NUMBER ONLY WHEN SIGN CONVEYS INFORMATION THAT IS SPECIFICALLY REFERRED TO ON BRISBANE CITY COUNCIL WEBSITE.

TEXT FONT TYPE AND SIZE:

- TEXT FONT: AVENIR MEDIUM.
- TEXT SIZES AS PER BELOW TABLE (U.N.O)
- FONT COLOUR (FOR MAIN TEXT FONT AND TAGLINE TEXT FONT): 7 YEAR CAST VINYL WHITE WHERE PANEL COLOUR IS PMS 293 BLUE.
- TEXT SIZES LISTED BELOW ARE TO BE USED AS A GUIDE ONLY.

STANDARD PARK ORDINANCE SIGNAGE – GRAPHIC STANDARDS

- PICTOGRAM IMAGES TO BE SOURCED VIA CITY PROJECTS OFFICE/CORPORATE COMMUNICATIONS – BRISBANE CITY COUNCIL.

OTHER COLOURS (WHERE APPLICABLE):

BLUE – PMS 293 BLUE

GREEN – PMS 355 GREEN

YELLOW – PMS 116 YELLOW

RED – PMS 485 RED

COLOURS NOT LISTED ABOVE ARE TO BE APPROVED PRIOR TO MANUFACTURE.


OTHER COLOURS MAY BE APPLICABLE WITH PRIOR APPROVAL.

SIGN PANEL GRAPHIC DETAILS FOR HORIZONTAL STANDARD SIGN (REFER SHEET 5 OF 6)

| PANEL | CLEAT UNIT SIZE (H X W) | | LOGO HEIGHT INCLUDING TAGLINE | CLEAR SPACE AROUND LOGO/OFFSET FROM EDGE OF PANEL | TEXT OFFSET FROM EDGE OF PANEL | HEADING TEXT SIZE | SUB HEADING TEXT SIZE | BODY TEXT SIZE | PICTOGRAM DIMENSIONS |
|-------|-------------------------|----|-------------------------------|---|--------------------------------|-------------------|-----------------------|----------------|----------------------|
| A | 40 | 24 | 196 | 41 | 124 | 160 (100 MIN) | N/A | N/A | N/A |
| B | 40 | 24 | N/A | N/A | 124 | N/A | N/A | N/A | 150x150 |
| C | 40 | 24 | N/A | N/A | 124 | N/A | 45 | 30 | N/A |

SIGN PANEL GRAPHIC DETAILS FOR VERTICAL – ALTERNATIVE SIGN (REFER SHEET 6 OF 6)

| SIGN TYPE | CLEAT UNIT SIZE (H X W) | | LOGO HEIGHT INCLUDING TAGLINE | CLEAR SPACE AROUND LOGO/OFFSET FROM EDGE OF PANEL | TEXT OFFSET FROM EDGE OF PANEL | HEADING TEXT SIZE | SUB HEADING TEXT SIZE | BODY TEXT SIZE | PICTOGRAM DIMENSIONS |
|-------------------------|-------------------------|----|-------------------------------|---|-----------------------------------|-------------------|-----------------------|----------------|----------------------|
| ALTERNATIVE 1 | 43 | 26 | 148 | 31 | 100 (PREFERRED) 30 MIN (AS SHOWN) | 160 (100 MIN) | 35 | N/A | N/A |
| ALTERNATIVE 2 | 43 | 26 | 148 | 31 | 100 (PREFERRED) 30 MIN (AS SHOWN) | 160 (100 MIN) | 35 | N/A | N/A |
| ALTERNATIVE 2 – PANEL B | 43 | 26 | N/A | N/A | N/A | N/A | N/A | N/A | 150X150 |
| ALTERNATIVE 3 | 43 | 26 | 148 | 31 | 100 (PREFERRED) 30 MIN (AS SHOWN) | 160 (100 MIN) | 35 | N/A | 150X150 |

| | | | | | | | | | | | | |
|-------|--|---------------|---------------|----------------|---|--|------|---------|---|--|--|--|
| | | | | | DRAWING AUTHORISED FOR PUBLICATION | | | |  | BRISBANE CITY COUNCIL STANDARD DRAWING | | |
| | | | | | Inga Condric 2015.06.04 15:56:00+10'00' | | | | | SCALE 1:20 | | |
| | | | | | for ASSET ENGINEERING MANAGER STRATEGIC ASSET MANAGEMENT | | | | | DWG No. BSD-10510 | | |
| | | | | | DESIGN APPROVED | | | | | ORIGINAL SIZE A3 | | |
| A | Drawing Converted From UMS Series March 2015 | MAR '15 | MAR '15 | MAR '15 | DANNY VAN DER WALLE SIGNATURE ON ORIGINAL APRIL 2014 | | | | | REVISION A | | |
| ISSUE | AMENDMENT | DRAWN DATE | CHK'D DATE | APPR'D DATE | SENIOR CO-ORDINATOR PARKS | | | | | PARK NAME SIGNAGE GRAPHIC NOTES SHEET 3 OF 6 | | |
| | | | | | DESIGN | CPO – P&D | DATE | MAR '15 | | | | |
| | | | | | DRAWN | CPO – P&D | DATE | MAR '15 | | | | |
| | | | | | CHECKED | CPS – NEWS | DATE | MAR '15 | | | | |
| | | | | | DRAWING FILENAME | BSD-10510 (A) Park Name Signage - Graphic Notes - Sheet 3 of 6.dwg | | | | | | |
| | | | | | ASSOCIATED PLANS | BSD-10510 SHEETS 1, 2, 4, 5 & 6.dwg | | | | | | |

- ALL DIMENSIONS IN MILLIMETRES (U.N.O.).
- REFER TO BSD - 10507 FOR PICTOGRAM SUITE DETAILS.
- REFER TO BSD - 10510 (SHEETS 1 AND 2) FOR STRUCTURAL NOTES.
- REFER TO BSD - 10510 (SHEET 3 OF 6) FOR GRAPHIC NOTES.
- REFER TO BSD - 10510 (SHEET 5 OF 6) FOR PARK NAME SIGN - HORIZONTAL - STANDARD - INSTALLATION NOTES.
- REFER TO BSD - 10510 (SHEET 6 OF 6) FOR PARK NAME SIGN - VERTICAL - ALTERNATIVE - INSTALLATION NOTES.

COLOUR POSITIVE:



Dedicated to a better Brisbane

NOTE THE
BACKGROUND
REPRESENTS THE
LIGHT COLOUR OF
ARTWORK

COLOUR REVERSE:




Dedicated to a better Brisbane


NOTE THE
BACKGROUND
REPRESENTS THE
DARK COLOUR OF
ARTWORK

COUNCIL'S POSITIVE LOGO IS USED ON WHITE OR LIGHT BACKGROUND COLOURS. THE POSITIVE LOGO DOES NOT HAVE A KEYLINE AROUND THE CITY HALL SQUARE BLOCK AND THE TAGLINE APPEARS IN BLACK LETTERING. THE REVERSE LOGO IS USED WHEN THE LOGO NEEDS TO BE VISIBLE ON A BLACK, DARK BLUE OR OTHER DARK COLOUR BACKGROUND. THE REVERSE LOGO FEATURES A WHITE KEYLINE AROUND THE CITY HALL SQUARE BLOCK AND THE TAGLINE APPEARS IN WHITE LETTERING.

TO ENSURE THE REVERSE LOGO IS CORRECT, ALWAYS APPLY A REVERSE LOGO FILE AVAILABLE FROM CORPORATE COMMUNICATION TO ARTWORK WITH A DARK BACKGROUND. THE REVERSE LOGO SHOULD NOT BE "CONSTRUCTED" FROM THE POSITIVE LOGO BY CHANGING A KEYLINE OR LETTERING COLOURS.

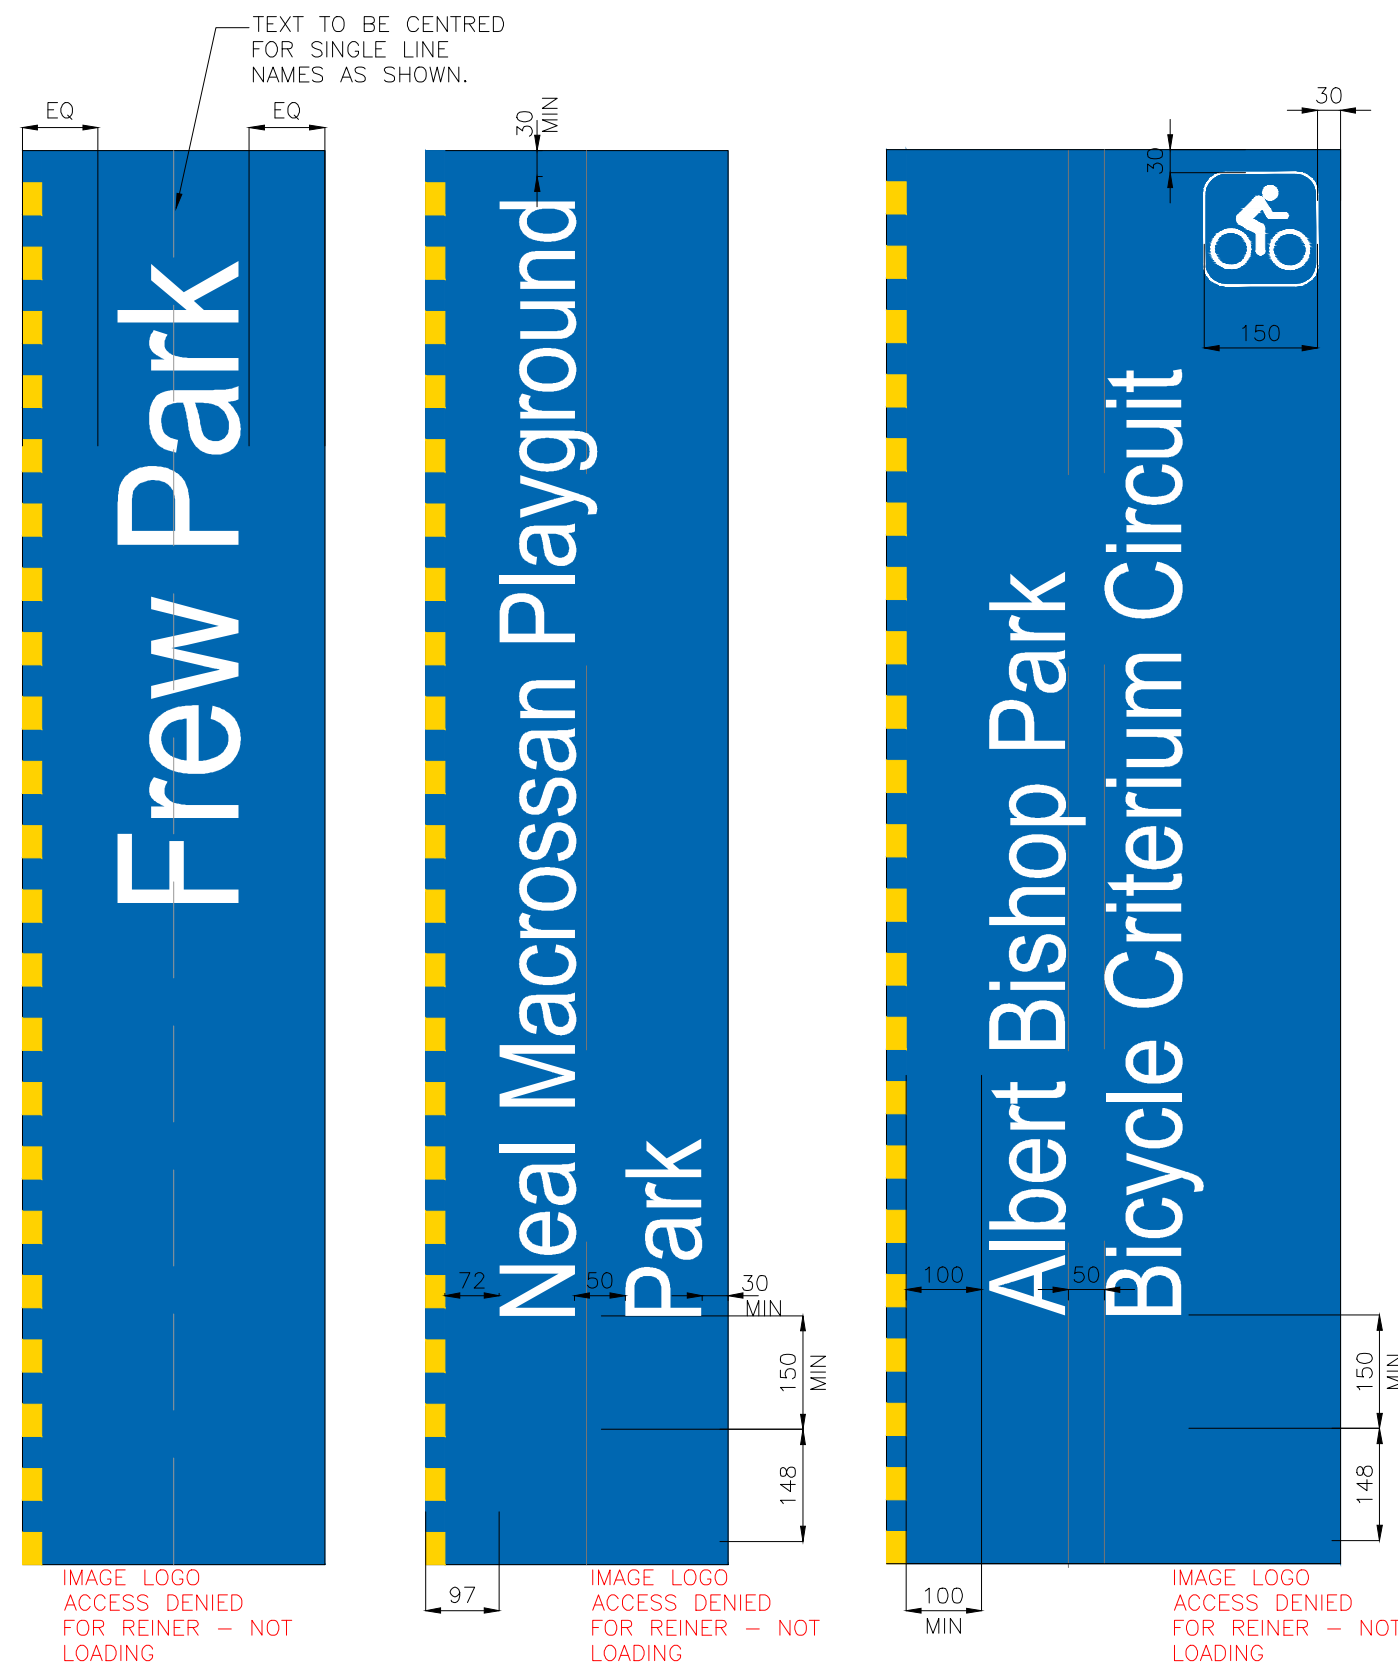


TYPICAL GRAPHIC LAYOUT – PARK NAME
SIGN – VERTICAL – ALTERNATIVE

| | | | | | | | | | | | | |
|-------|--|---------------|---------------|----------------|---|---------------------|---|------|---------|---|---------------|------------------|
| | | | | | DRAWING AUTHORISED FOR PUBLICATION | DESIGN | CPO – P&D | DATE | MAR '15 |  <div style="text-align: center;"> BRISBANE CITY COUNCIL STANDARD DRAWING PARK NAME SIGNAGE GRAPHIC SETOUT DETAILS SHEET 4 OF 6 </div> | SCALE 1:20 | |
| | | | | | Ingo Condric 2015.06.04 15:56:54+10'00' for ASSET ENGINEERING MANAGER STRATEGIC ASSET MANAGEMENT | DRAWN | CPO – P&D | DATE | MAR '15 | | DWG No. | BSD-10510 |
| | | | | | DESIGN APPROVED | CHECKED | CPS – NEWS | DATE | MAR '15 | | ORIGINAL SIZE | A3 |
| A | Drawing Converted From UMS Series March 2015 | MAR '15 | MAR '15 | MAR '15 | DANNY VAN DER WALLE SIGNATURE ON ORIGINAL APRIL 2014 | DRAWING FILENAME | BSD-10510 (A) Park Name Signage - Graphic Setout Details - Sheet 4 of 6.dwg | | | | REVISION | A |
| ISSUE | AMENDMENT | DRAWN DATE | CHK'D DATE | APPR'D DATE | SENIOR CO-ORDINATOR PARKS | ASSOCIATED PLANS | BSD-10510 SHEETS 1, 2, 3, & 5.dwg | | | | | |
| | | | | | | | | | | | | |


GENERAL GRAPHIC NOTES FOR SIGNAGE

- ALL DIMENSIONS IN MILLIMETRES (U.N.O.).
- REFER TO BSD - 10507 FOR PICTOGRAM SUITE DETAILS.
- REFER TO BSD - 10510 (SHEETS 1 AND 2) FOR STRUCTURAL NOTES.
- REFER TO BSD - 10510 (SHEET 3 OF 6) FOR GRAPHIC NOTES.
- REFER TO BSD - 10510 (SHEET 4 OF 6) GRAPHIC SETOUT DETAILS.
- REFER TO BSD - 10510 (SHEET 6 OF 6) FOR PARK NAME SIGN - VERTICAL - ALTERNATIVE - INSTALLATION NOTES.


| POST, FOOTING AND EMBEDMENT DETAILS | | | |
|-------------------------------------|--------------------------------------|---------|-----------|
| NUMBER OF POST | TERRAIN CATEGORY = 1.5 AND ABOVE | | |
| | POST (STEEL) DIAMETER x THICKNESS | FOOTING | EMBEDMENT |
| 2 | 88.9x3.2 CHS | 300 Dia | 900 |

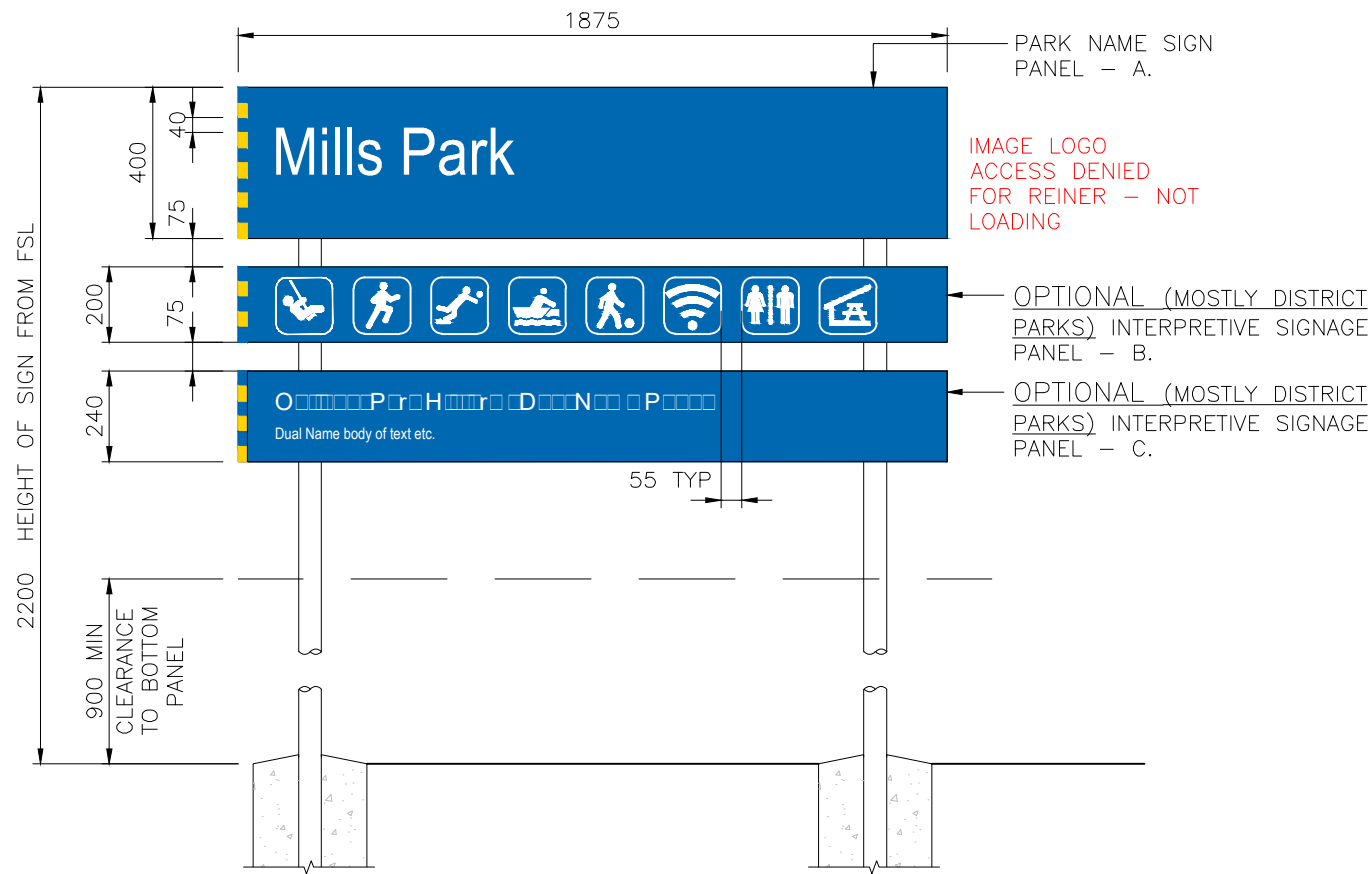

SECTIONAL ELEVATION
SCALE: 1:20

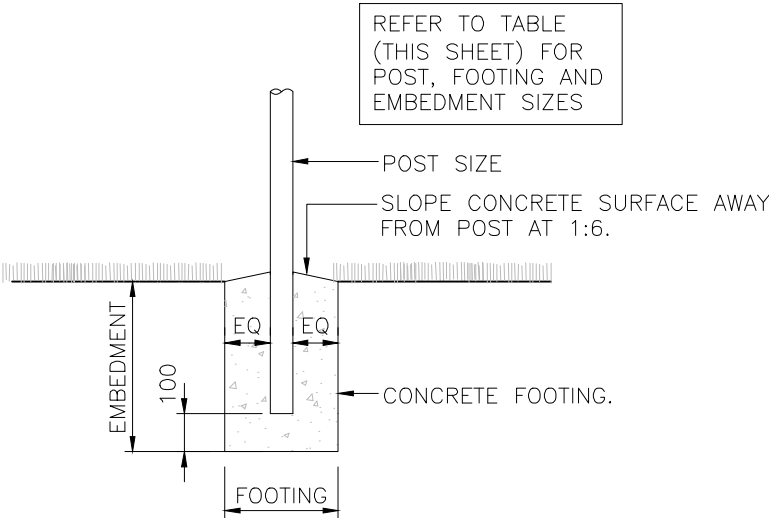


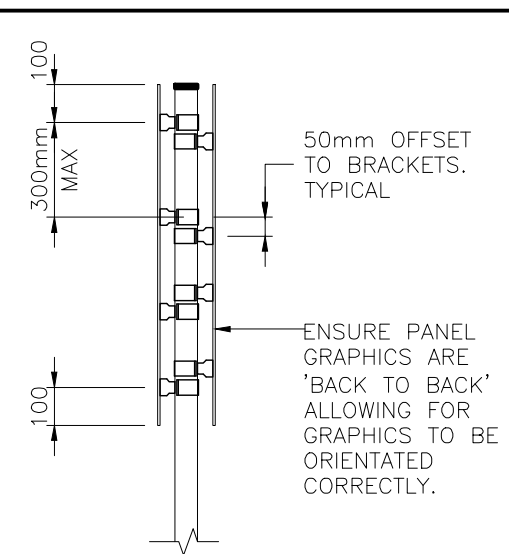
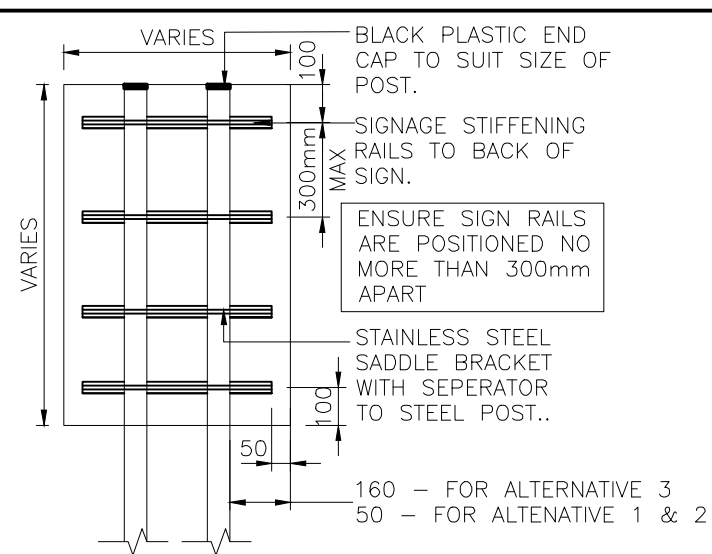
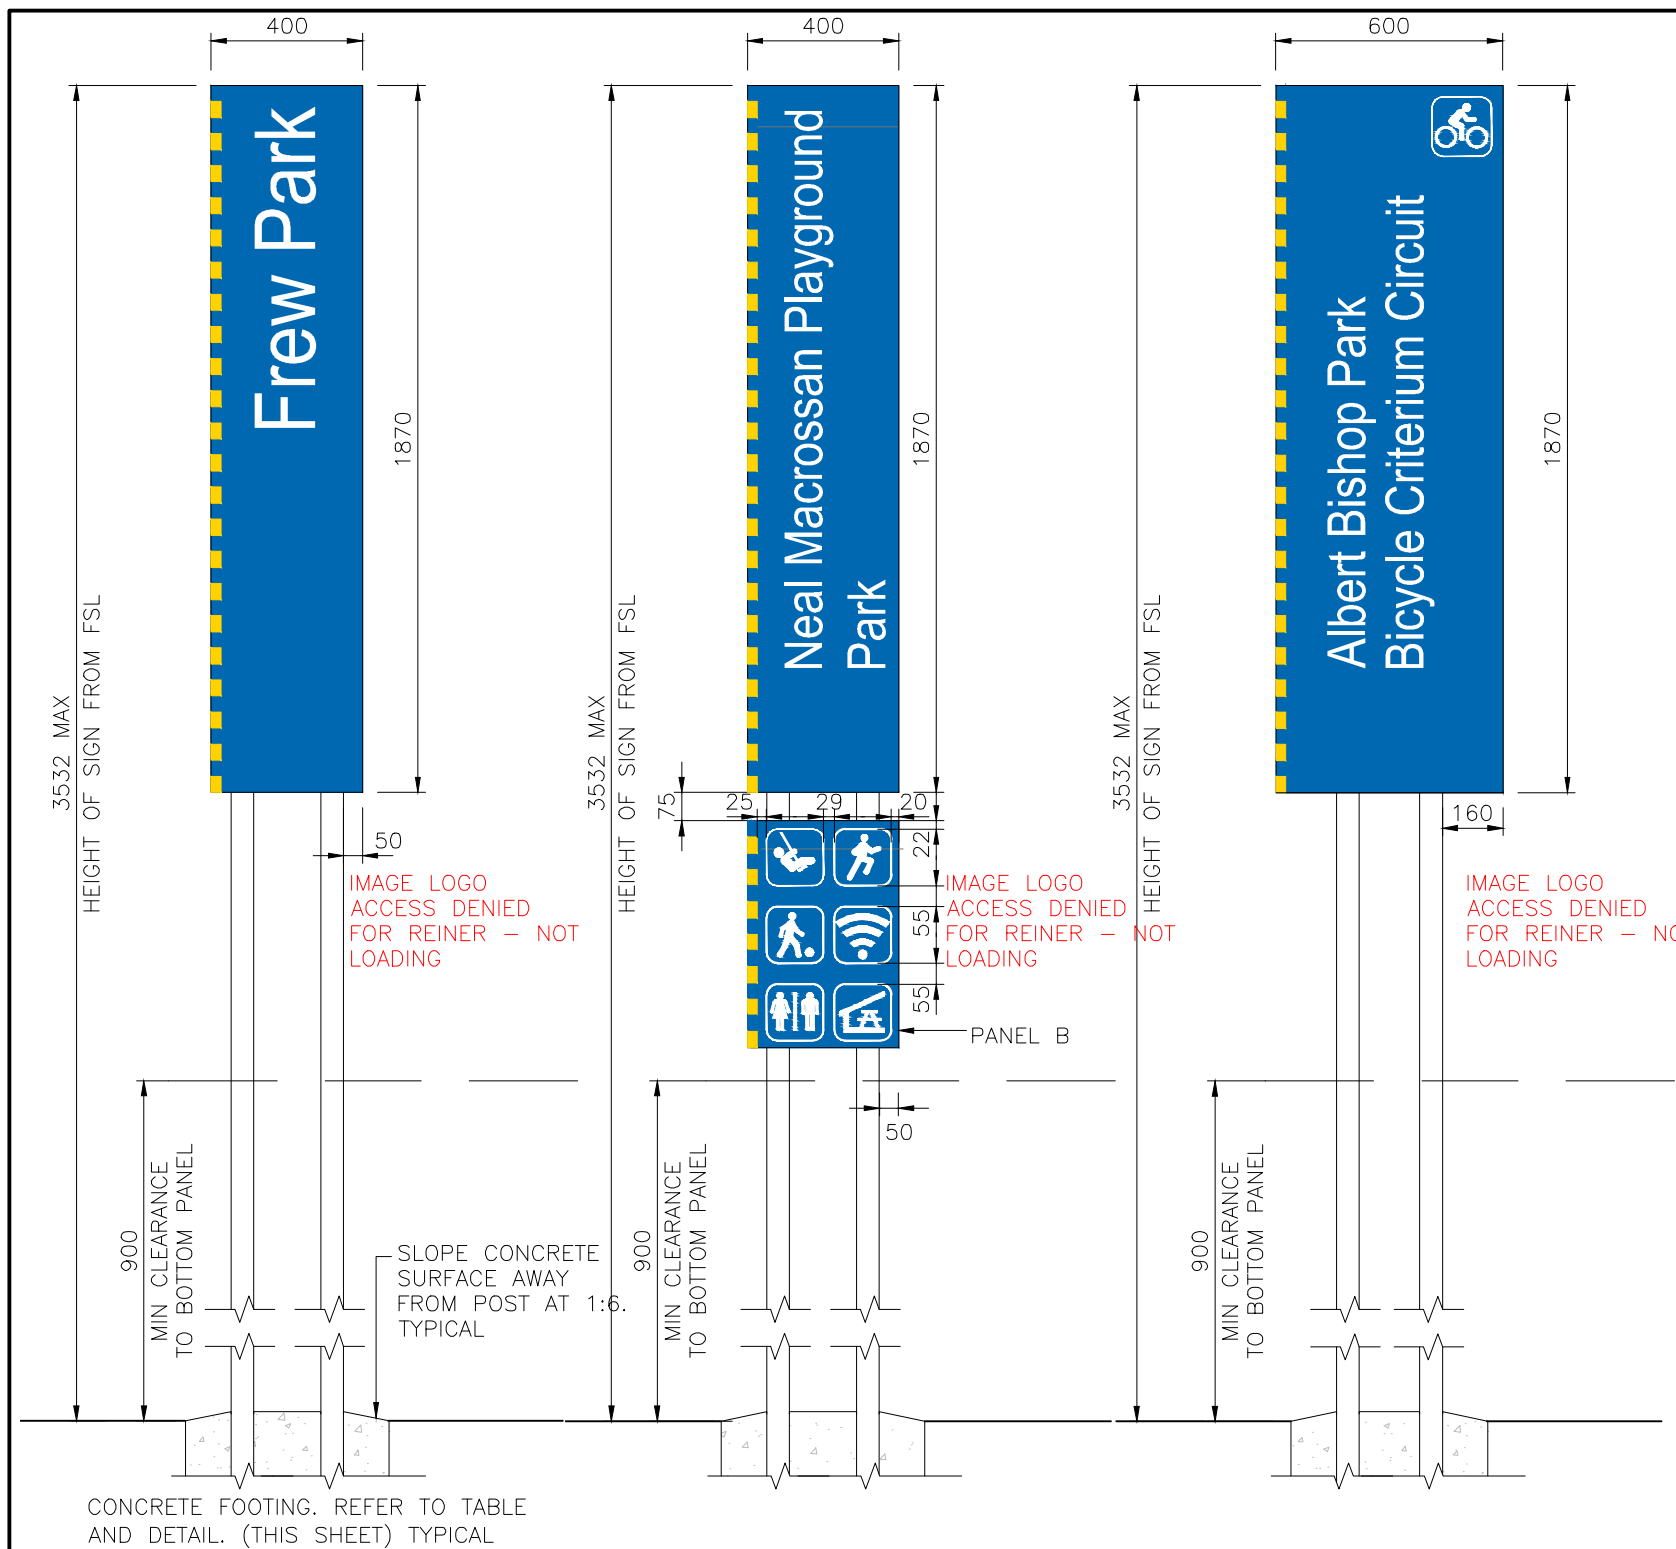
CONCRETE FOOTING DETAIL
SCALE: 1:20

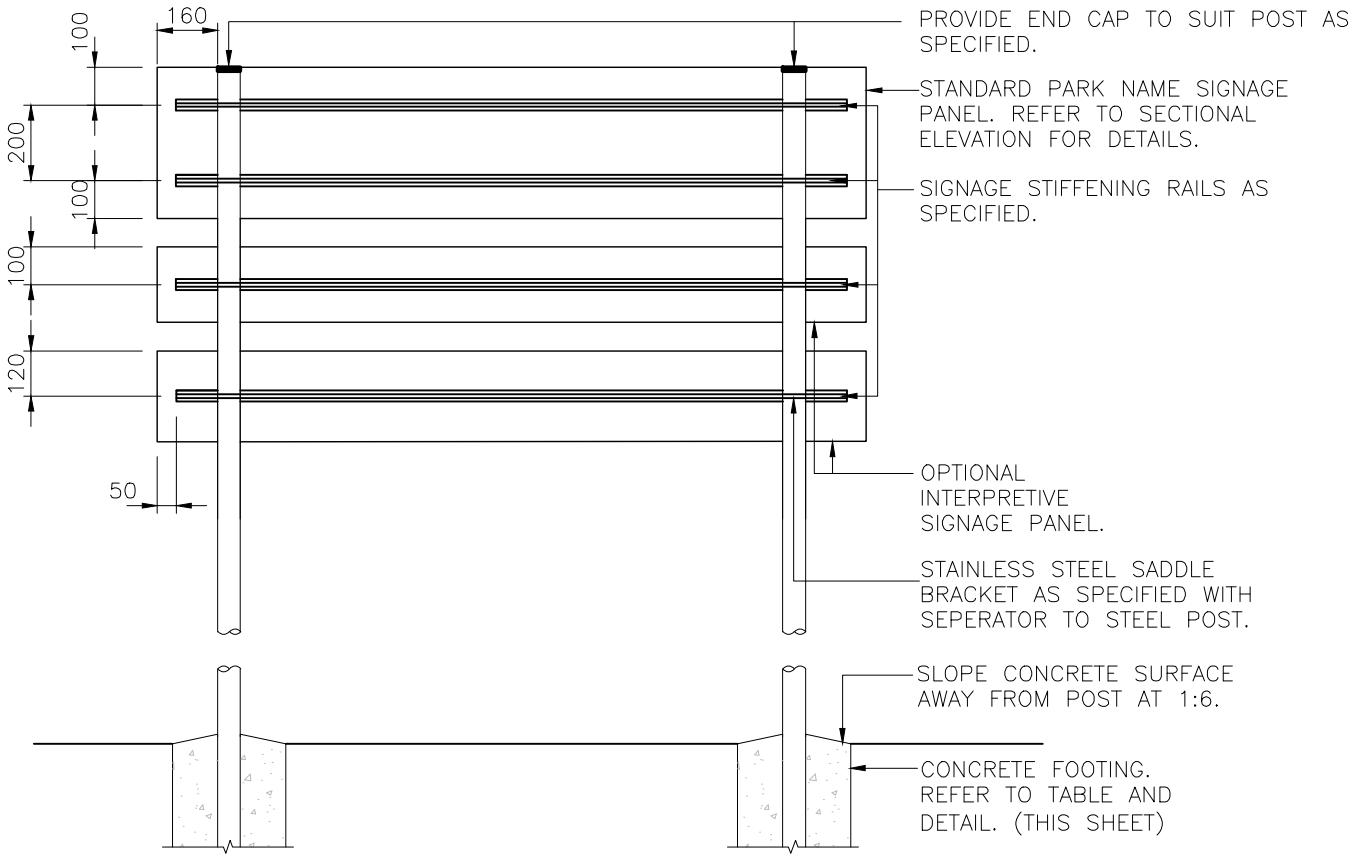

SIGNAGE FIXING DETAIL
SCALE: 1:20


| STRUCTURAL DESIGN CERTIFICATION | | |
|--|--|--|
| DESIGN | DESIGN CHECK | AUTHORISED FOR ISSUE |
| Zhuangzhi Hu RPEQ 13885 2015.03.20 11:46:21+10'00' | Lenita MendiaRPEQ 8950 2015.03.20 12:12:30 +10'00' | Bala Balakumar RPEQ 3963 2015.03.20 14:04:52+10'00' |
| BRISBANE CITY COUNCIL STANDARD DRAWING | | |
| PARK NAME SIGNAGE HORIZONTAL STANDARD SHEET 5 OF 6 | | SCALE 1:20 DWG No BSD-10510 ORIGINAL SIZE A3 REVISION A |

| | | | | | | | | | | |
|-------|--|---------------|---------------|----------------|---|---------------------|--|------|---------|---|
| | | | | | DRAWING AUTHORISED FOR PUBLICATION | DESIGN | CPD – P&D | DATE | MAR '15 |  |
| | | | | | Inga Condric 2015.06.04 15:57:35+10'00' | DRAWN | CPD – P&D | DATE | MAR '15 | |
| | | | | | for ASSET ENGINEERING MANAGER STRATEGIC ASSET MANAGEMENT | CHECKED | CPS – NEWS | DATE | MAR '15 | |
| | | | | | DESIGN APPROVED | DRAWING FILENAME | BSD-10510 (A) Park Name Signage - Horizontal Standard - Sheet 5 of 6.dwg | | | |
| A | Drawing Converted From UMS Series March 2015 | MAR '15 | MAR '15 | MAR '15 | DANNY VAN DER WALLE SIGNATURE ON ORIGINAL APRIL 2014 | ASSOCIATED PLANS | BSD-10510 SHEETS 1, 2, 3, 4 & 6.dwg | | | |
| ISSUE | AMENDMENT | DRAWN DATE | CHK'D DATE | APPR'D DATE | SENIOR CO-ORDINATOR PARKS | | | | | |
| | | | | | | | | | | |



DOUBLE (2) POST TO PANEL
FIXING DETAIL
SCALE: 1:20

DOUBLE (2) SIDED
SIGN POST DETAIL
SCALE: 1:20

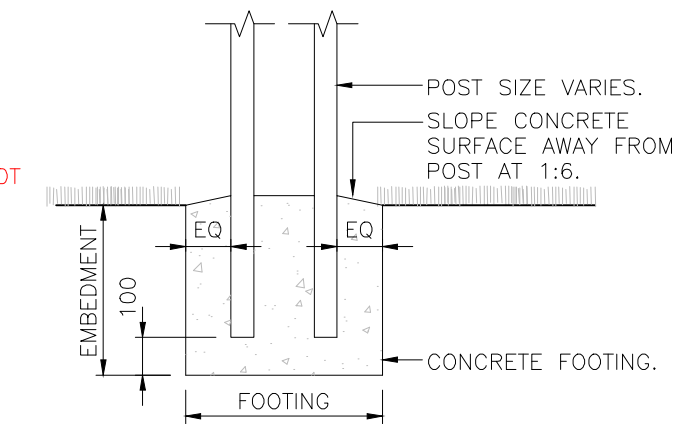

CONCRETE FOOTING DETAIL -
DOUBLE POST
SCALE: 1:20

REFER TO TABLE
(THIS SHEET) FOR
POST, FOOTING AND
EMBEDMENT SIZES

POST, FOOTING AND EMBEDMENT DETAILS

| SIGN TYPE | NUMBER OF POST | TERRAIN CATEGORY = 1.5 and above | | |
|-----------------|----------------|-----------------------------------|---------|-----------|
| | | POST (STEEL) DIAMETER x THICKNESS | FOOTING | EMBEDMENT |
| ALTERNATIVE 1 | 2 | 76.1x3.2 CHS | 450 Dia | 1000 |
| ALTERNATIVE 2,3 | 2 | 88.9x3.2 CHS | 450 Dia | 1100 |

STRUCTURAL DESIGN CERTIFICATION

| DESIGN | DESIGN CHECK | AUTHORISED FOR ISSUE |
|---|---|--|
| Zhuangzhi Hu RPEQ 13885 2015.03.20 11:46:45 +10'00' | Lenita Mendia RPEQ 8950 2015.03.20 12:11:29 +10'00' | Bala Balakumar RPEQ 3963 2015.03.20 14:05:27+10'00' |

BRISBANE CITY COUNCIL STANDARD DRAWING

PARK NAME SIGNAGE
VERTICAL ALTERNATIVE
SHEET 6 OF 6

| SCALE | |
|---------------|----------|
| DWG No. | 1:20 |
| BSD-10510 | |
| ORIGINAL SIZE | REVISION |
| A3 | A |

ALTERNATIVE 1
SCALE: 1:20

ALTERNATIVE 2
SCALE: 1:20


ALTERNATIVE 3
(SPECIFIC MAJOR PARK NODES ONLY)
SCALE: 1:20


GENERAL GRAPHIC NOTES FOR SIGNAGE

- ALL DIMENSIONS IN MILLIMETRES (U.N.O.).
- REFER TO BSD - 10507 FOR PICTOGRAM SUITE DETAILS.
- REFER TO BSD - 10510 (SHEETS 1 AND 2) FOR STRUCTURAL NOTES.
- REFER TO BSD - 10510 (SHEET 3 OF 6) FOR GRAPHIC NOTES.
- REFER TO BSD - 10510 (SHEET 4 OF 6) GRAPHIC SETOUT DETAILS.
- REFER TO BSD - 10510 (SHEET 5 OF 6) FOR PARK NAME SIGN - HORIZONTAL - STANDARD - INSTALLATION NOTES.


| ISSUE | AMENDMENT | DRAWN DATE | CHK'D DATE | APPR'D DATE |
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| A | Drawing Converted From UMS Series March 2015 | MAR '15 | MAR '15 | MAR '15 |

| DRAWING AUTHORISED FOR PUBLICATION | | | |
|------------------------------------|---|------|---------|
| DESIGN | CP0 - P&D | DATE | MAR '15 |
| DRAWN | CP0 - P&D | DATE | MAR '15 |
| CHECKED | CPS - NEWS | DATE | MAR '15 |
| DRAWING FILENAME | BSD-10510 (A) Park Name Signage - Vertical Alternative - Sheet 6 of 6.dwg | | |
| ASSOCIATED PLANS | BSD-10510 SHEETS 1, 2, 3, 4 & 5.dwg | | |

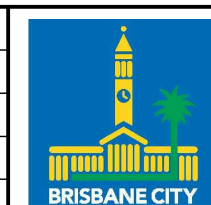


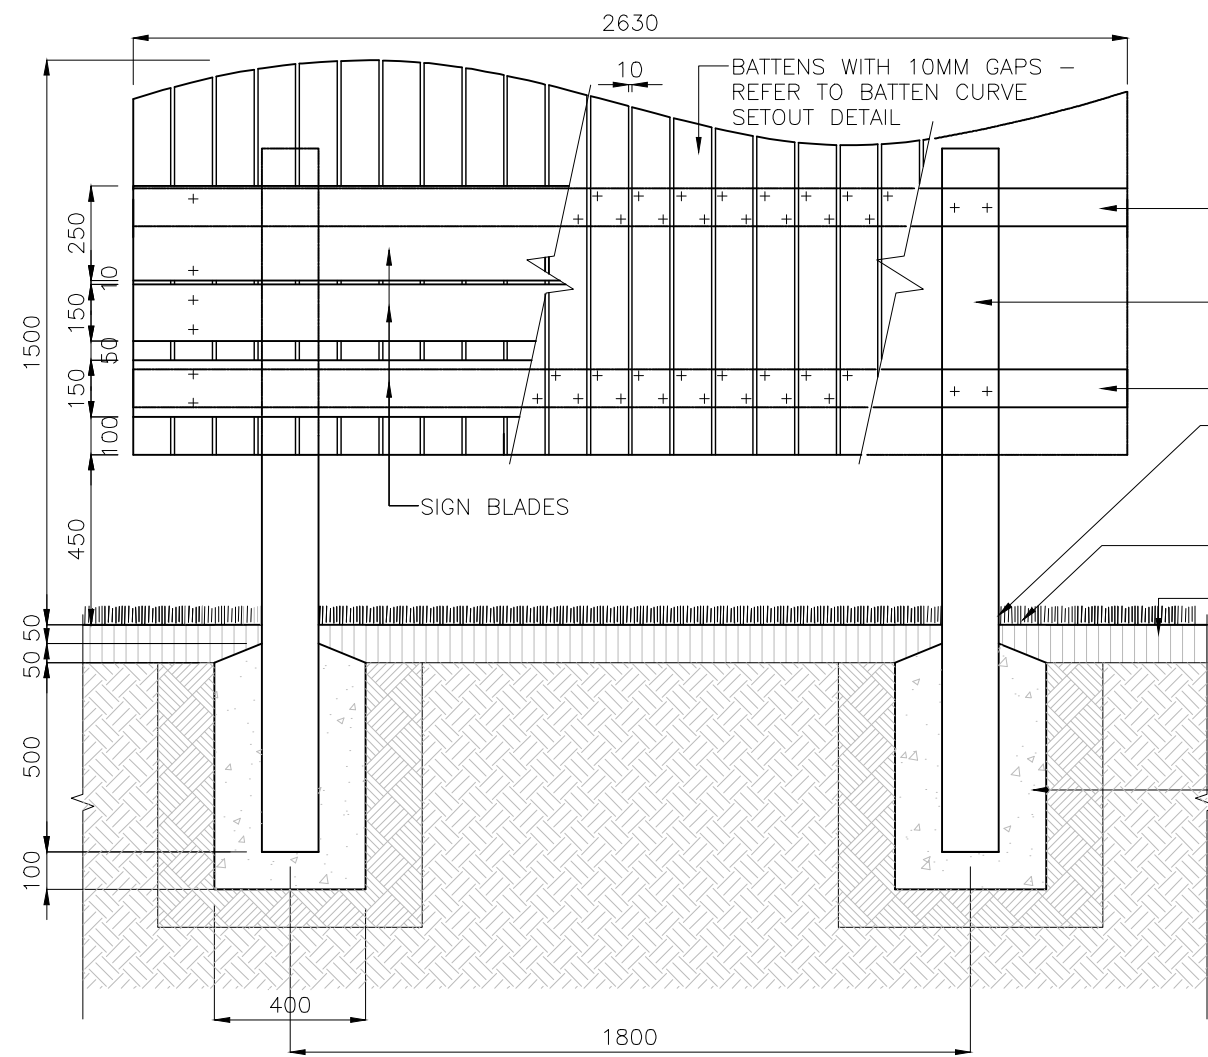


ELEVATION
SCALE 1: 20

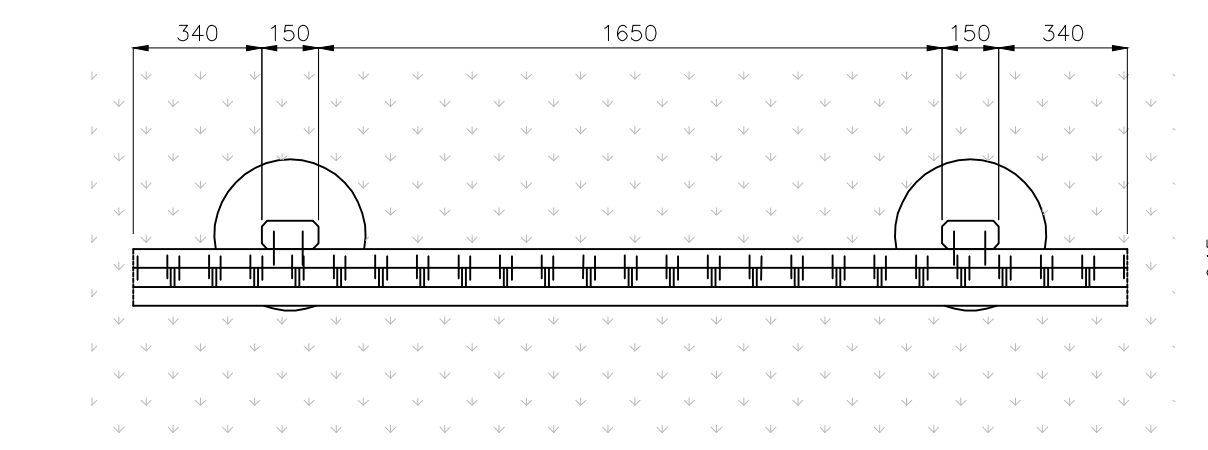

PLAN
SCALE 1: 20

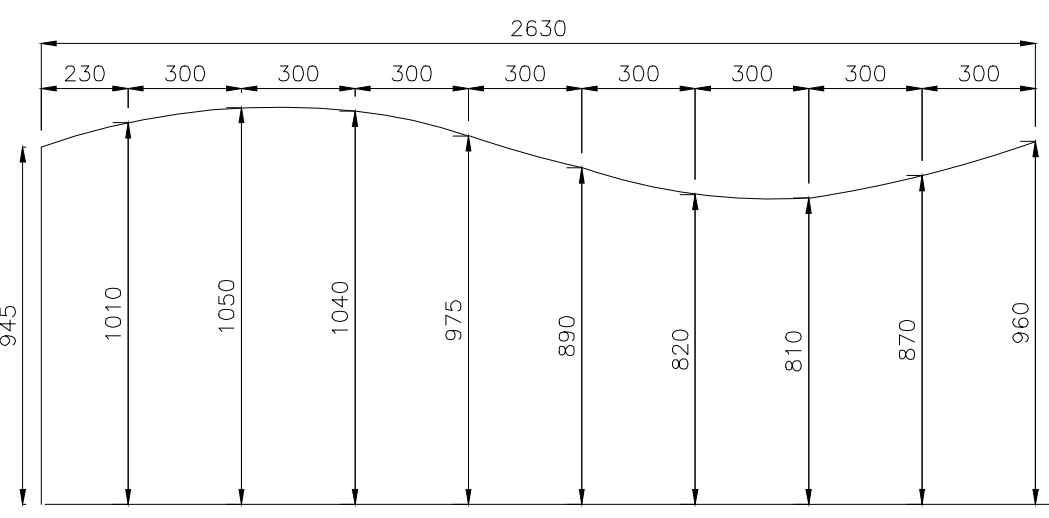

BATTEN CURVE SETOUT
SCALE 1: 20

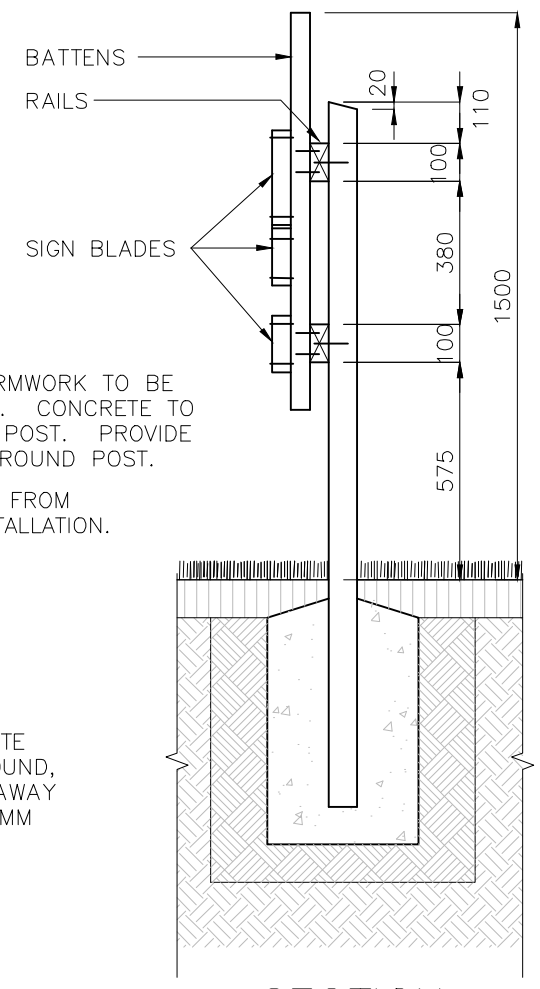

SECTION
SCALE 1: 20

GENERAL NOTES

- ENSURE THAT WORK IS IN ACCORDANCE WITH BRISBANE CITY COUNCIL ENVIRONMENTAL BEST PRACTICE NOTES.
- SITE SETOUT TO BE VERIFIED BY SUPERINTENDENT OR LANDSCAPE ARCHITECT PRIOR TO THE COMMENCEMENT OF CONSTRUCTION WORKS.
- VERIFY LOCATION OF ALL SERVICES AND EASEMENTS PRIOR TO THE COMMENCEMENT OF WORKS.
- WRITTEN DIMENSIONS TAKE PRECEDENCE OVER SCALED DISTANCES.
- VERIFY ALL DIMENSIONS ON SITE PRIOR TO CONSTRUCTION.
- STRUCTURES HAVE BEEN DESIGNED ON THE ASSUMPTION THAT THE MINIMUM ALLOWABLE BEARING CAPACITY FOR SOIL IS 100KPA AND TERRAIN CATEGORY = 2.5.
- IN EACH CASE ENGINEERING CERTIFICATION AND MODIFICATION AS NECESSARY WILL BE REQUIRED FOR PARTICULAR SOIL AND SITE CONDITIONS.
- THE COPYRIGHT OF THIS DRAWING REMAINS THE PROPERTY OF THE BRISBANE CITY COUNCIL.
- DIMENSIONS IN MILLIMETRES (UNO).

FOOTINGS

AS DETAILED.

TIMBER WORK

ALL TIMBER TO BE ACQ TREATED ROUGH SAWN SELECT GRADE HARDWOOD OF A SINGLE SPECIES.
ALL TIMBER IN CONTACT WITH GROUND TO BE PRESERVATIVE TREATED TO HAZARD CLASS H5 TO AS1604.1–2000 AND HAVE A DURABILITY CLASS 1 (IN GROUND) TO AS5604–2003.
ALL TIMBER TO BE FREE OF KNOTS, SPLINTERS, CRACKS OR ANY MAJOR DEFECT.
ALL EXPOSED EDGES TO BE ARRISSED 4MM.
POSTS TO BE 150X50MM
RAILS TO BE 100X50MM
BATTENS TO BE 100X38MM
SIGN BLADES TO BE 1NO 250X50MM AND 2NO 150X50MM.

SIGN BLADES

SIGN BLADES TO BE ROUTED TIMBER TO SIZES SHOWN. REFER TO BSD-10511–DESCRIPTIVE SIGN–NATURAL AREA–SHEET 3 OF 3–NAME LAYOUT FOR ROUTING OF LETTERING.

FIXINGS

ALL FIXINGS TO BE STAINLESS STEEL.
RAILS – TO BE FIXED TO POSTS WITH M10 HEX HEAD BOLTS WITH MATCHING NUTS AND WASHERS, RECESSED ON FRONT, 2 NO. PER POINT OF FIXING.
BATTENS – TO BE FIXED TO RAILS WITH BUGLE SCREWS, 2 NO. PER POINT OF FIXING.
SIGN BLADES – TO BE FIXED TO BATTENS WITH M8 CUPHEAD BOLTS, NUTS AND WASHERS, 2 NO. PER POINT OF FIXING.


FINISHES

TIMBER TO BE PRIMED AND THEN FINISHED WITH MINIMUM 2 NO. COATS OF DULUX 'PINE NEEDLE' COLOUR.
SELECTION IN ACCORDANCE WITH THE NATURAL AREAS DESIGN MANUAL COLOUR SCHEDULE.

| | | | | |
|-------|-----------------------|------------|------------|-------------|
| | | | | |
| B | Drawing Title Amended | FEB '16 | JUL '16 | JUL '16 |
| A | ORIGINAL ISSUE | DEC '14 | DEC '14 | DEC '14 |
| ISSUE | AMENDMENT | DRAWN DATE | CHK'D DATE | APPR'D DATE |

| |
|---|
| DRAWING AUTHORISED FOR PUBLICATION |
| Inga Condric 2015.06.04 15:29:08+10'00' |
| for ASSET ENGINEERING MANAGER STRATEGIC ASSET MANAGEMENT |
| DESIGN APPROVED |
| C. Wood |
| SENIOR CO-ORDINATOR NATURAL ENVIRONMENT ASSET SERVICES/BRISBANE INFRASTRUCTURE |

| | | | |
|------------------|---|------|---------|
| DESIGN | CP0 - P&D | DATE | DEC '14 |
| DRAWN | CP0 - P&D | DATE | DEC '14 |
| CHECKED | BI - FSG - AS | DATE | DEC '14 |
| DRAWING FILENAME | BSD-10511 (B) Descriptive sign - Natural area - Entry sign - Sheet 1 of 3.dwg | | |
| ASSOCIATED PLANS | BSD-10511-Sheets 2 & 3 | | |

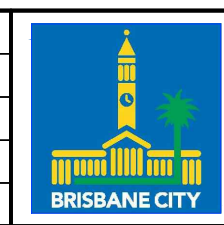

| | |
|---|---------------|
| BRISBANE CITY COUNCIL STANDARD DRAWING | |
| DESCRIPTIVE SIGN NATURAL AREA – ENTRY SIGN SHEET 1 OF 3 | |
| SCALE AS SHOWN | |
| DWG No. BSD-10511 | |
| ORIGINAL SIZE A3 | REVISION B |




- ENSURE THAT WORK IS IN ACCORDANCE WITH BRISBANE CITY COUNCIL ENVIRONMENTAL BEST PRACTICE NOTES.
- SITE SETOUT TO BE VERIFIED BY SUPERINTENDENT OR LANDSCAPE ARCHITECT PRIOR TO THE COMMENCEMENT OF CONSTRUCTION WORKS.
- VERIFY LOCATION OF ALL SERVICES AND EASEMENTS PRIOR TO THE COMMENCEMENT OF WORKS.
- WRITTEN DIMENSIONS TAKE PRECEDENCE OVER SCALED DISTANCES.
- VERIFY ALL DIMENSIONS ON SITE PRIOR TO CONSTRUCTION.
- STRUCTURES HAVE BEEN DESIGNED ON THE ASSUMPTION THAT THE MINIMUM ALLOWABLE BEARING CAPACITY FOR SOIL IS 100KPA AND TERRAIN CATEGORY = 2.5.
- IN EACH CASE ENGINEERING CERTIFICATION AND MODIFICATION AS NECESSARY WILL BE REQUIRED FOR PARTICULAR SOIL AND SITE CONDITIONS.
- THE COPYRIGHT OF THIS DRAWING REMAINS THE PROPERTY OF THE BRISBANE CITY COUNCIL.
- DIMENSIONS IN MILLIMETRES (UNO).

ALL TIMBER TO BE ACQ TREATED ROUGH SAWN SELECT
GRADE HARDWOOD OF A SINGLE SPECIES.
ALL TIMBER IN CONTACT WITH GROUND TO BE
PRESERVATIVE TREATED TO HAZARD CLASS H5 TO
AS1604.1-2000 AND HAVE A DURABILITY CLASS 1 (IN
GROUND) TO AS5604-2003.
ALL TIMBER TO BE FREE OF KNOTS, SPLINTERS, CRACKS
OR ANY MAJOR DEFECT.
ALL EXPOSED EDGES TO BE ARRISSED 4MM.
POSTS TO BE 150X50MM.
SIGN BLADES TO BE 1NO. 250X50MM AND 2NO.
150X50MM

SIGN BLADES TO BE ROUTED TIMBER TO SIZES SHOWN.
REFER TO BSD-10511-DESCRIPTIVE SIGN-NATURAL
AREA-SHEET 3 OF 3-NAME LAYOUT FOR ROUTING OF
LETTERING.


ALL FIXINGS TO BE STAINLESS STEEL.
SIGN BLADES - TO BE FIXED TO BATTENS WITH M8
CUPHEAD BOLTS, NUTS AND WASHERS, 2 NO. PER
POINT OF FIXING.

TIMBER TO BE PRIMED AND THEN FINISHED WITH
MINIMUM 2 NO. COATS OF DULUX 'PINE NEEDLE'
COLOUR.
SELECTION IN ACCORDANCE WITH THE NATURAL AREAS
DESIGN MANUAL COLOUR SCHEDULE.


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| | | | | | <div>DRAWING AUTHORISED FOR PUBLICATION</div> <div>Inga Condric 2015.06.05 07:47:36+10'00'</div> <div>for ASSET ENGINEERING MANAGER STRATEGIC ASSET MANAGEMENT</div> | DESIGN | CPO - P&D | DATE | DEC '14 |  | BRISBANE CITY COUNCIL STANDARD DRAWING | | |
| | | | | | | DRAWN | CPO - P&D | DATE | DEC '14 | | SCALE AS SHOWN | | |
| | | | | | | CHECKED | BI - FSG - AS | DATE | DEC '14 | | DWG No. BSD-10511 | | |
| B | Drawing Title Amended | FEB '16 | JUL '16 | JUL '16 | | <div>DESIGN APPROVED</div> <div>C. Wood</div> <div>SENIOR CO-ORDINATOR NATURAL ENVIRONMENT ASSET SERVICES/BRISBANE INFRASTRUCTURE</div> | DRAWING FILENAME | BSD-10511 (B) Descriptive sign - Natural area - Name sign - Sheet 2 of 3.dwg | | | DESCRIPTIVE SIGN NATURAL AREA – NAME SIGN SHEET 2 OF 3 | | |
| A | ORIGINAL ISSUE | DEC '14 | DEC '14 | DEC '14 | ASSOCIATED PLANS | | BSD-10511-Sheets 1 & 3 | | | | ORIGINAL SIZE A3 | REVISION B | |
| ISSUE | AMENDMENT | DRAWN DATE | CHK'D DATE | APPR'D DATE | | | | | | | | | |

NOTES


- FOR SPECIFICATIONS AND PLACEMENT OF SIGN BOARDS WITH NAME LAYOUT ON ENTRY SIGNS AND NAME SIGNS REFER TO:
- BSD-10511-DESCRIPTIVE SIGN-NATURAL AREA-SHEET 1 OF 3-ENTRY SIGN
 - BSD-10511-DESCRIPTIVE SIGN-NATURAL AREA-SHEET 2 OF 3-NAME SIGN
- NATURAL AREA LOGO AND BCC LOGO
- NATURAL AREA LOGO METAL PLATE AND BCC LOGO METAL PLATE TO HAVE A 5MM WIDE RECESSED BORDER AROUND.

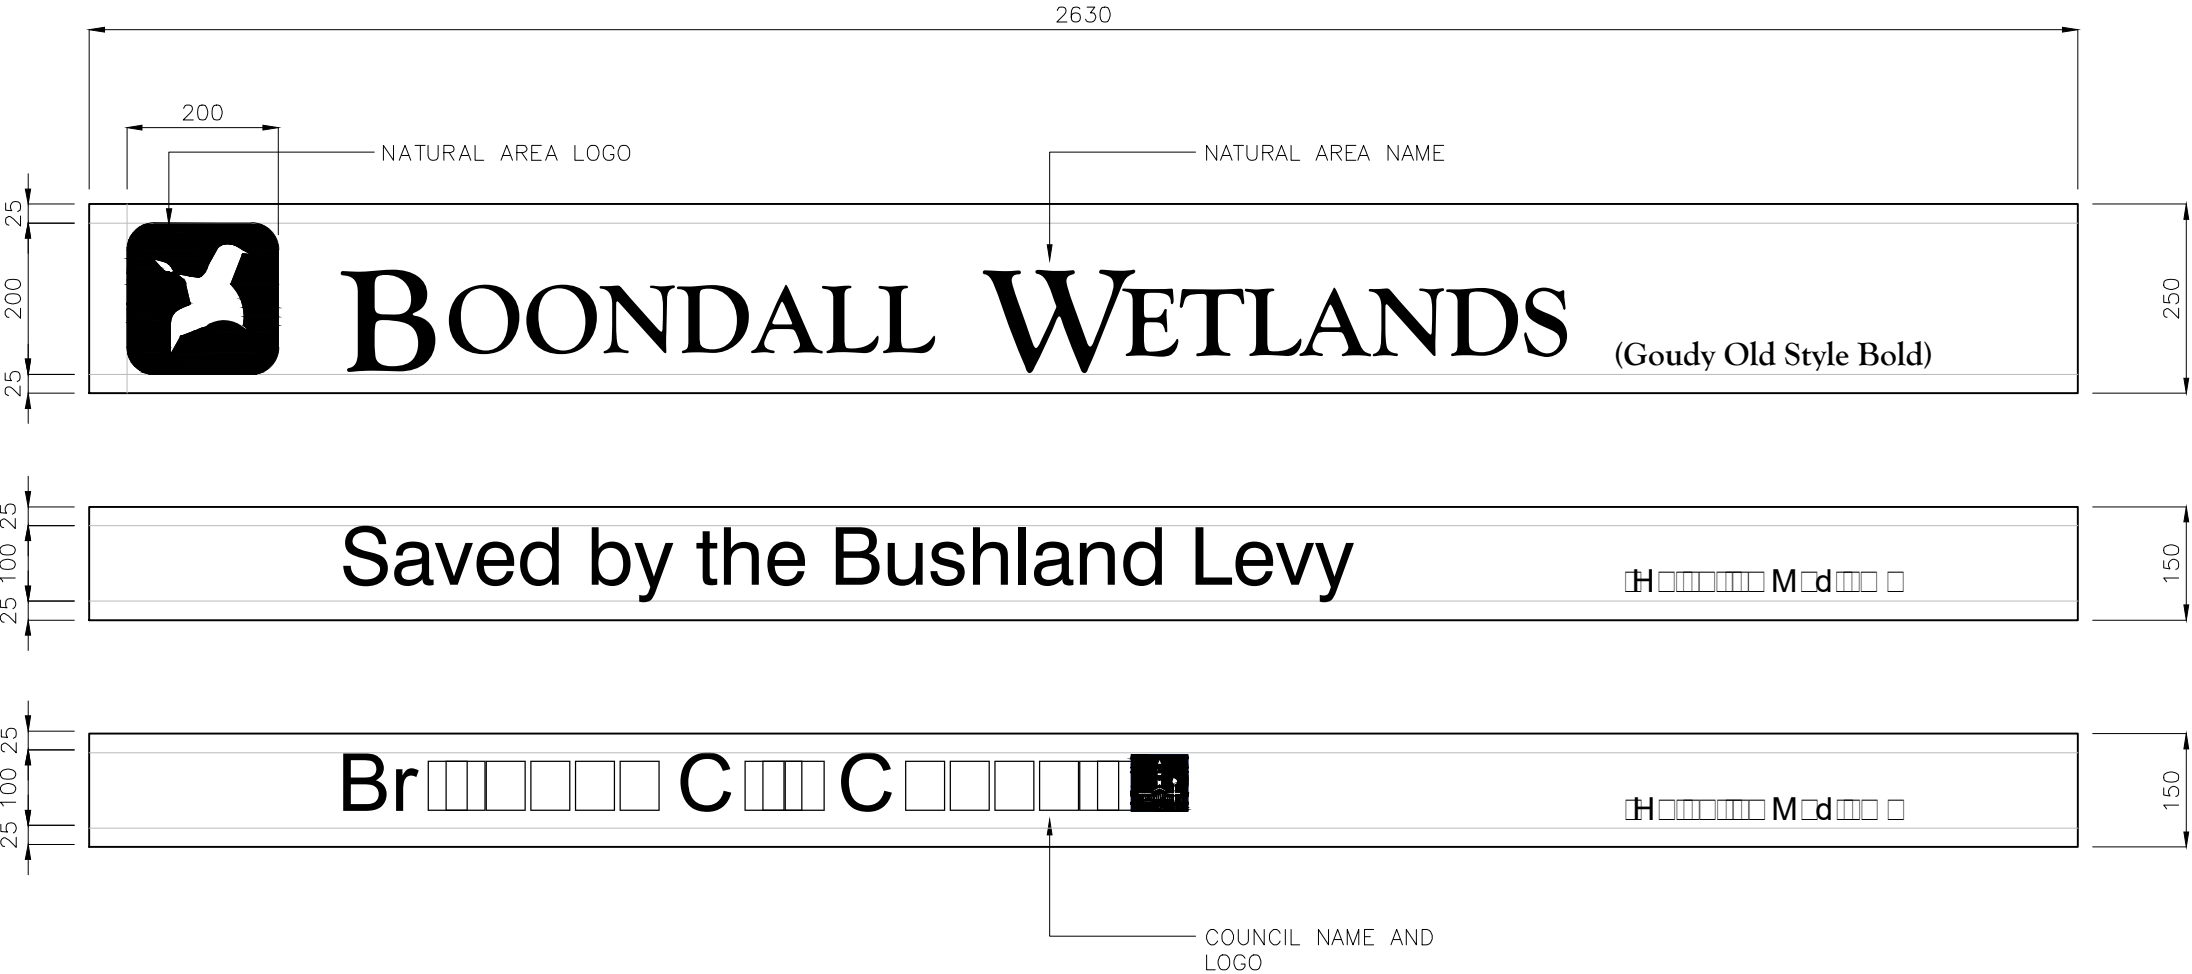


ELEVATION
SCALE 1:10

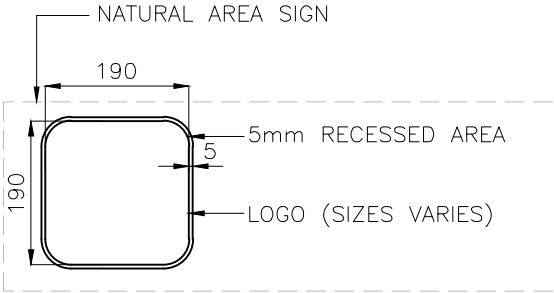


LOGO RECESS DETAIL
SCALE 1:10


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| | | | | | DRAWING AUTHORISED FOR PUBLICATION | | | | DESIGN | CP0 - P&D | DATE | DEC '14 |  | BRISBANE CITY COUNCIL STANDARD DRAWING | | | |
| | | | | | Inga Condric 2015.06.05 07:48:19+10'00' for ASSET ENGINEERING MANAGER STRATEGIC ASSET MANAGEMENT | | | | DRAWN | CP0 - P&D | DATE | DEC '14 | | DESCRIPTIVE SIGN – NATURAL AREA – SIGN LAYOUT SHEET 3 OF 3 | | | |
| | | | | | DESIGN APPROVED C.Wood SENIOR CO-ORDINATOR NATURAL ENVIRONMENT ASSET SERVICES/BRISBANE INFRASTRUCTURE | | | | CHECKED | BI - FSG - AS | DATE | DEC '14 | | | | | |
| B | Drawing Title Amended | FEB '16 | JUL '16 | JUL '16 | | | | | | | | | | DRAWING FILENAME | BSD-10511 (B) Descriptive sign - Natural area - Sign Layout - Sheet 3 of 3.dwg | | |
| A | ORIGINAL ISSUE | DEC '14 | DEC '14 | DEC '14 | | | | | ASSOCIATED PLANS | BSD-10511-Sheets 1 & 2 | | | | | | | |
| ISSUE | AMENDMENT | DRAWN DATE | CHK'D DATE | APPR'D DATE | | | | | | | | | | | | | |

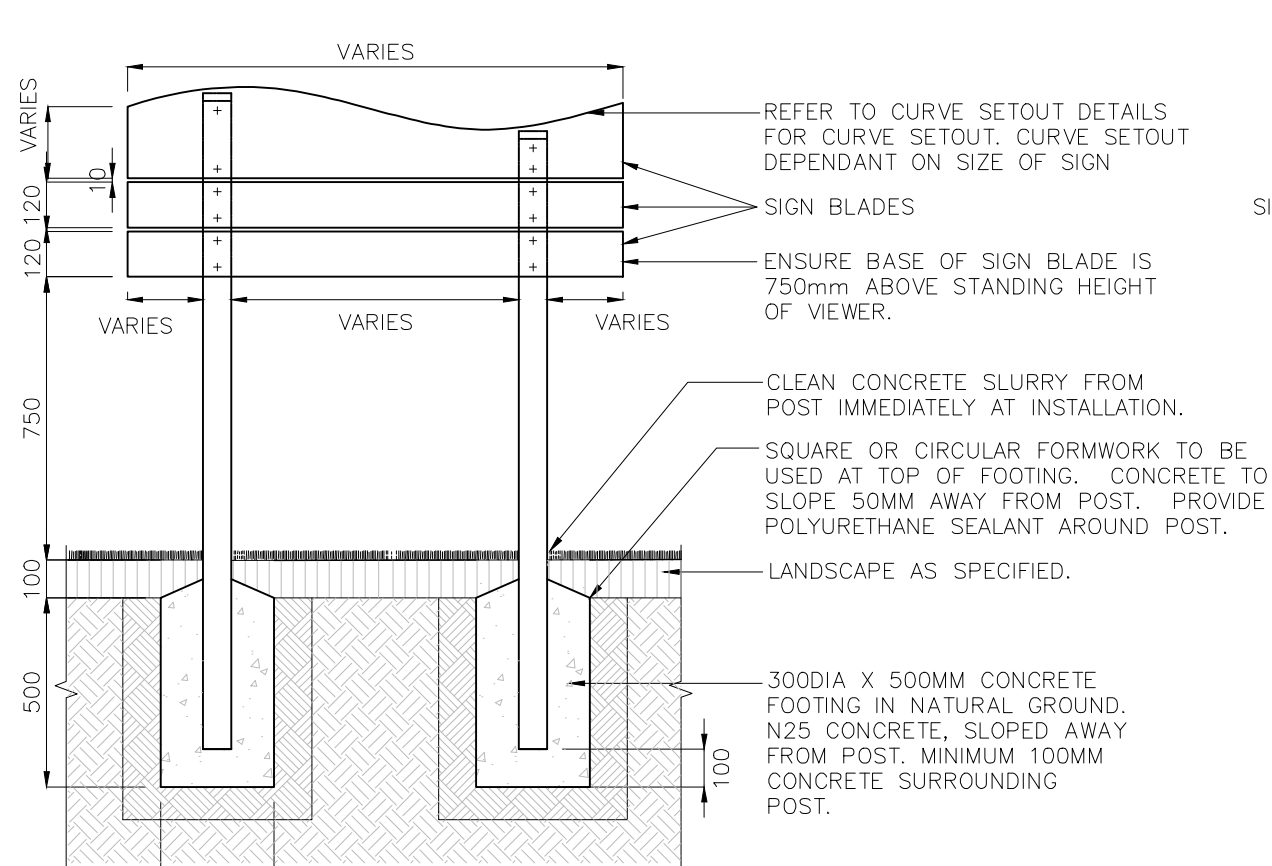


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SCALE: 1: 20

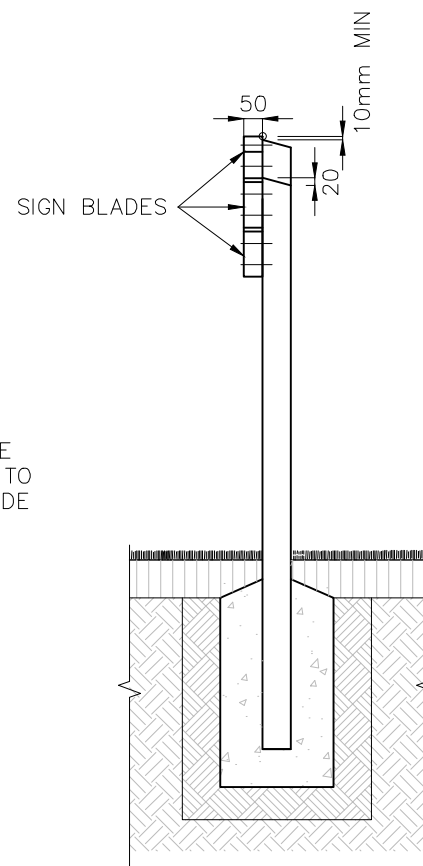


SECTION
SCALE: 1: 20

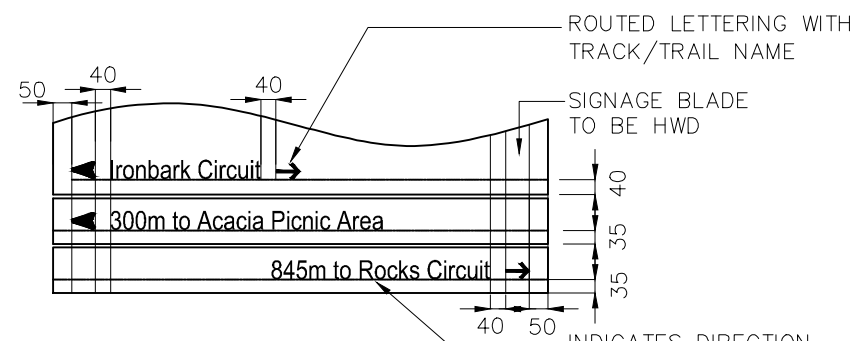


LETTERING LAYOUT
SCALE: 1: 20

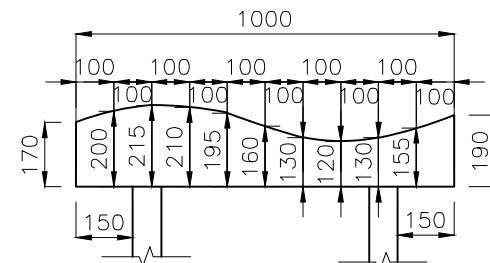


CURVE SETOUT 2
SCALE: 1: 20

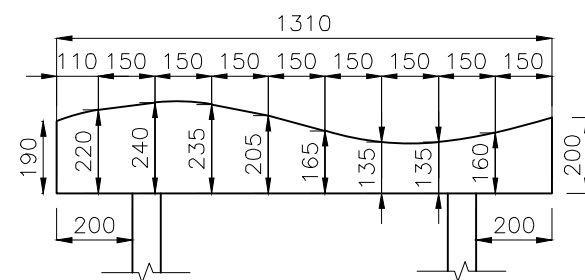

CURVE SETOUT 1
SCALE: 1: 20

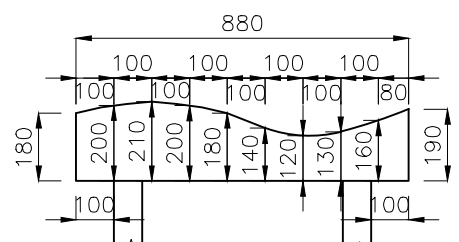

CURVE SETOUT 3
SCALE: 1: 20

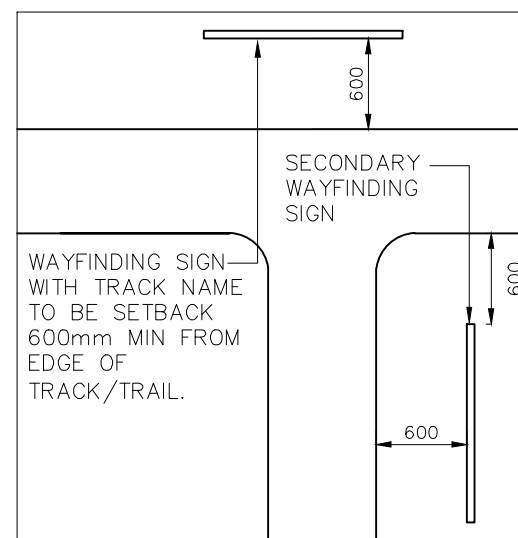

SIGN LOCATION PLAN
SCALE: 1: 50

GENERAL NOTES

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- DIMENSIONS IN MILLIMETRES (UNO).

FOOTINGS

AS DETAILED

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ALL TIMBER TO BE FREE OF KNOTS, SPLINTERS, CRACKS OR ANY MAJOR DEFECT.
ALL EXPOSED EDGES TO BE ARRISSED 4MM.
POSTS TO BE 75X75MM WITH CHAMFERED TOPS
SIGN BLADES TO BE 120X38MM STANDARD,
IF A LARGER BLADE IS NEEDED DUE TO INCREASE IN TEXT, THE STANDARD SIGN BLADE MAY BE SUBSTITUTED FOR A 240X38MM BLADE.
CURVED SIGN BLADE HEIGHT VARIES.

SIGN BLADES

SIGN BLADES TO BE ROUTED TIMBER TO SIZES SHOWN.
ROUTING OF LETTERING.
LETTERING TO BE HELVETICA FONT, 60MM IN HEIGHT.

FIXINGS

ALL FIXINGS TO BE STAINLESS STEEL.
SIGN BLADES – TO BE FIXED TO POSTS WITH 75MM BUGLE HEAD SCREWS.


FINISHES

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COLOUR SELECTION IN ACCORDANCE WITH THE NATURAL AREAS DESIGN MANUAL COLOUR SCHEDULE.


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| A | ORIGINAL ISSUE | DEC '14 | DEC '14 | DEC '14 |
| ISSUE | AMENDMENT | DRAWN DATE | CHK'D DATE | APPR'D DATE |

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|---|
| DRAWING AUTHORISED FOR PUBLICATION |
| Inga Cendric 2015.06.05 07:49:01+10'00' |
| for ASSET ENGINEERING MANAGER STRATEGIC ASSET MANAGEMENT |
| DESIGN APPROVED |
| C. Wood |
| SENIOR CO-ORDINATOR NATURAL ENVIRONMENT ASSET SERVICES/BRISBANE INFRASTRUCTURE |


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| DESIGN | CP0 - P&D | DATE | DEC '14 |
| DRAWN | CP0 - P&D | DATE | DEC '14 |
| CHECKED | BI - FSG - AS | DATE | DEC '14 |
| DRAWING FILENAME | BSD-10512 (A) Advisory sign - Natural area - Wayfinding.dwg | | |
| ASSOCIATED PLANS | | | |

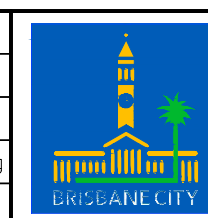


| | |
|---|---------------|
| BRISBANE CITY COUNCIL STANDARD DRAWING | |
| ADVISORY SIGN NATURAL AREA WAYFINDING | |
| SCALE AS SHOWN | |
| DWG No. BSD-10512 | |
| ORIGINAL SIZE A3 | REVISION A |

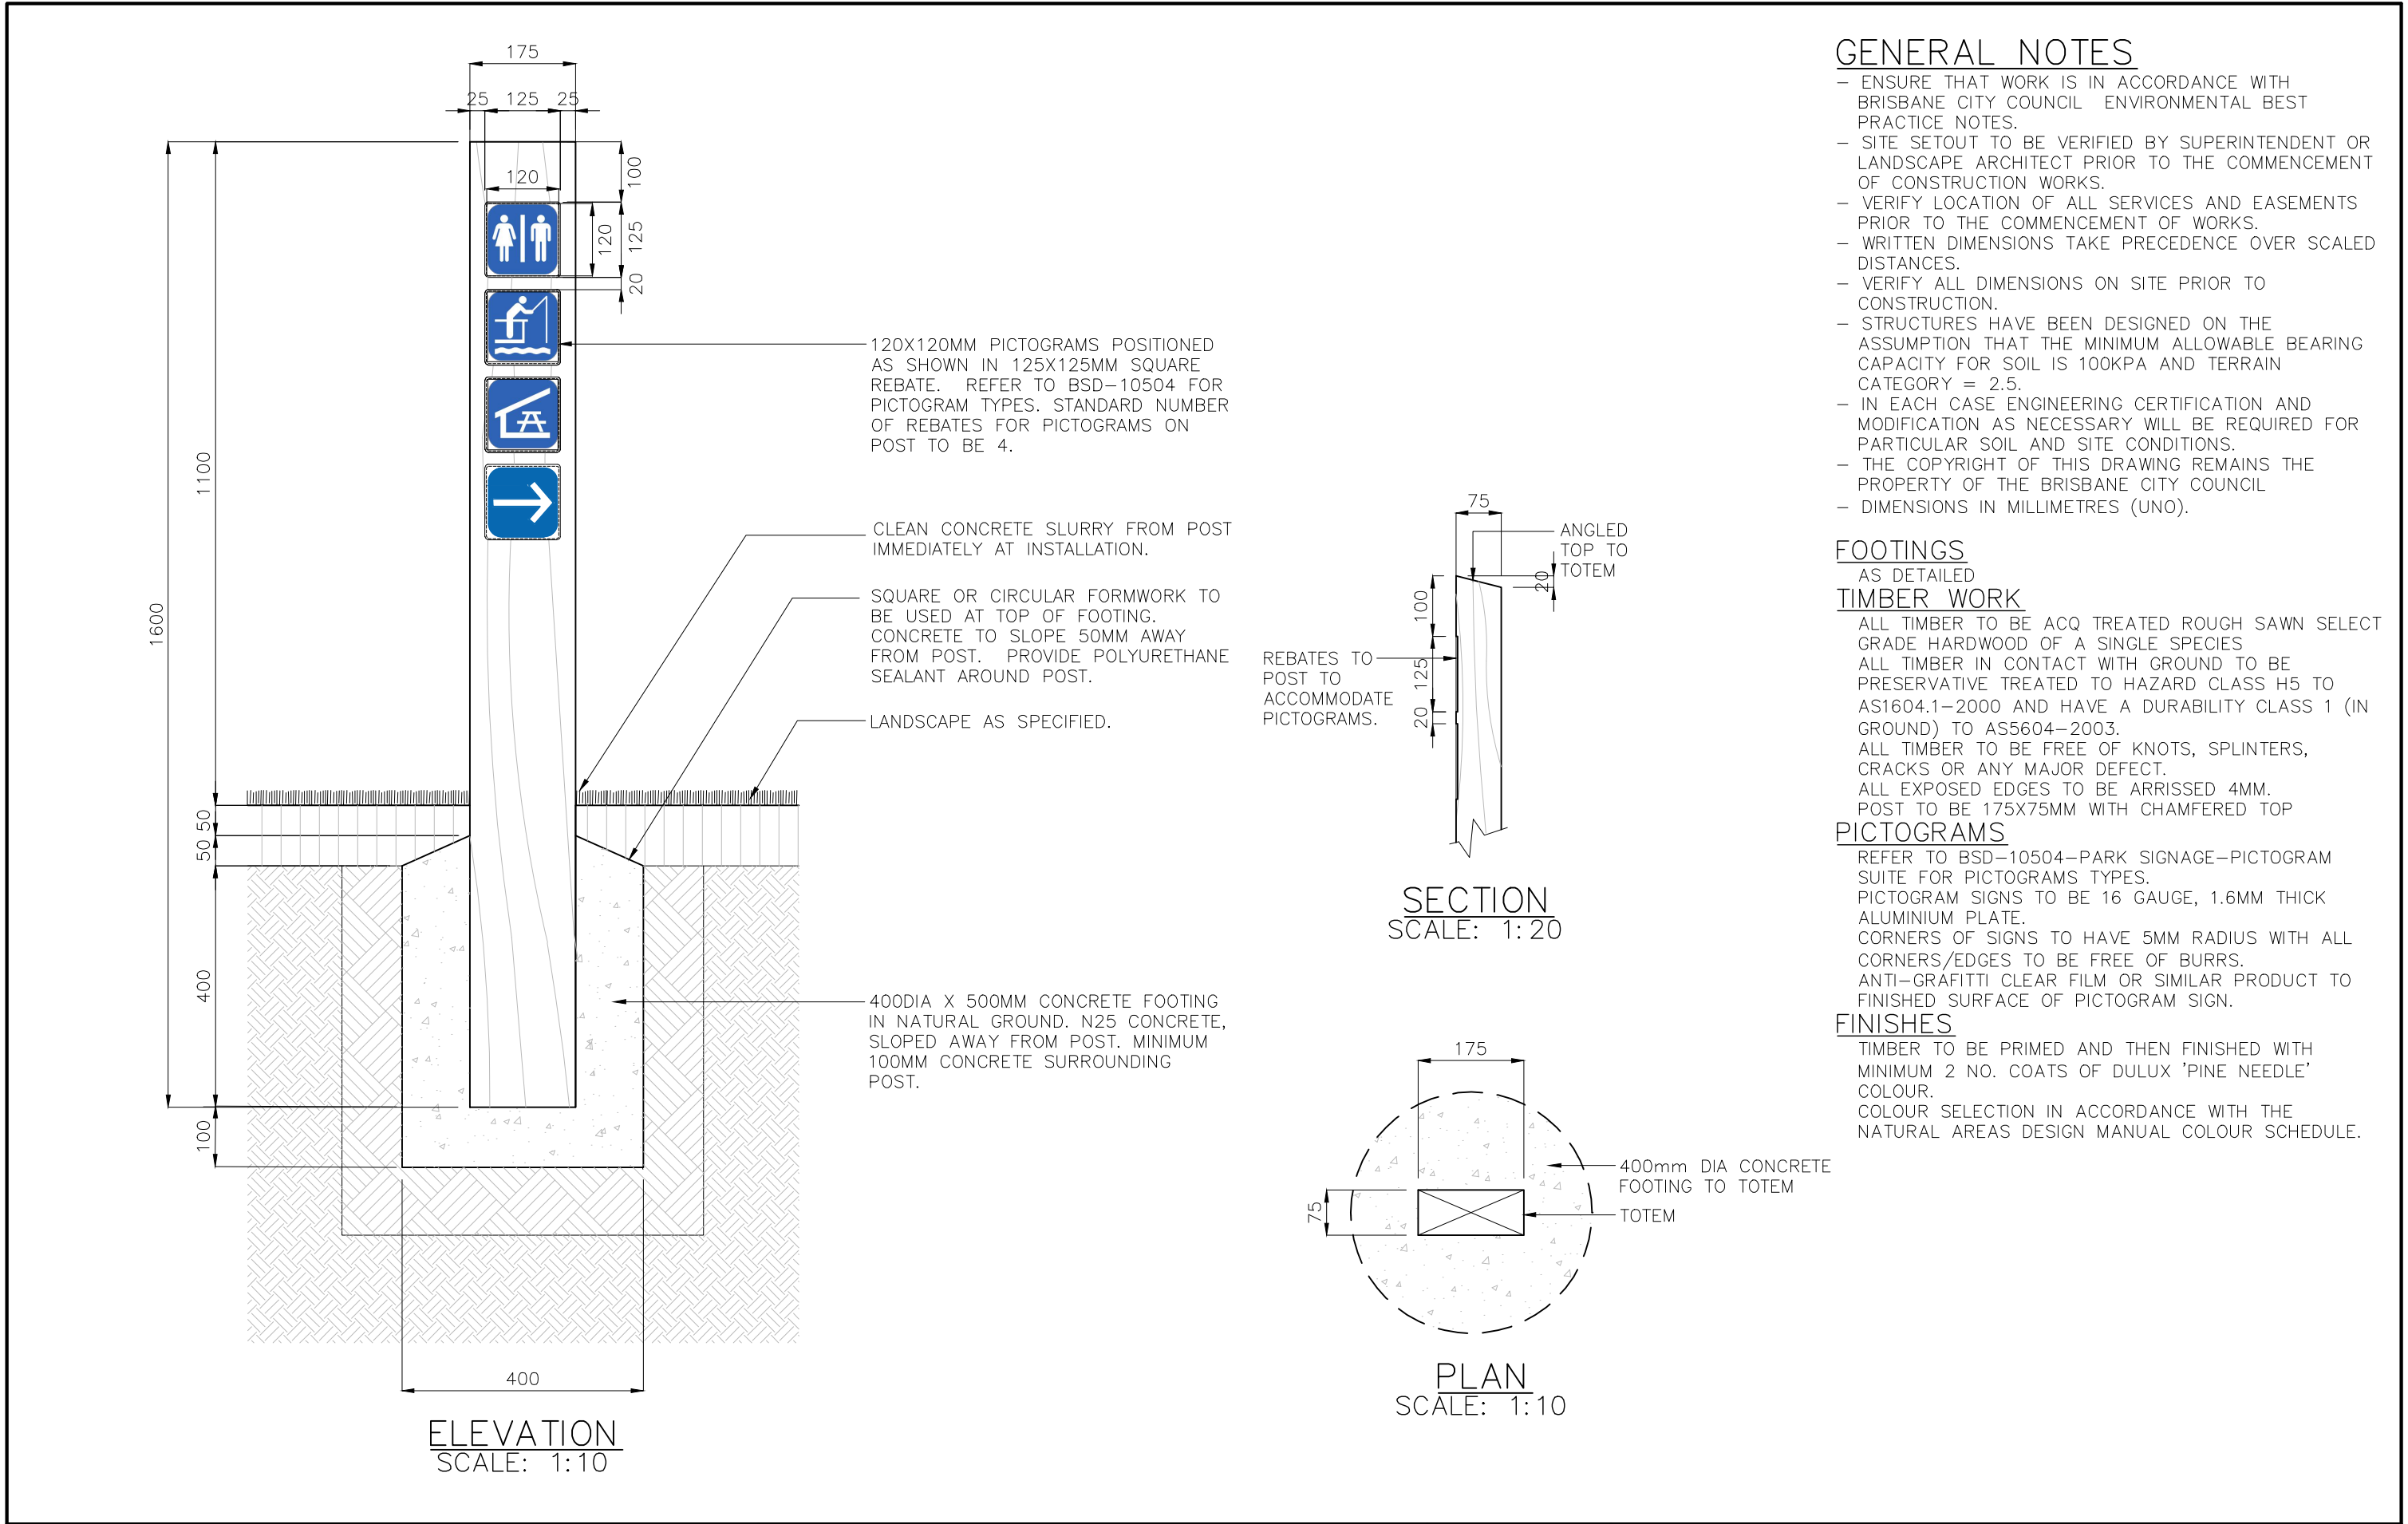


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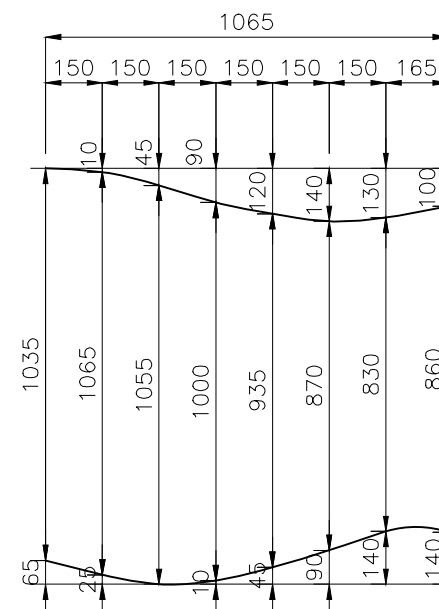
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GENERAL NOTES

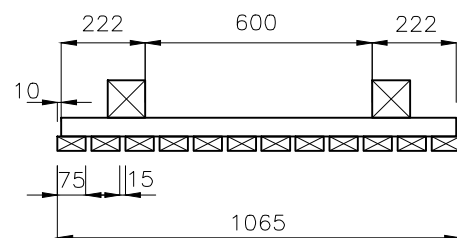- ENSURE THAT WORK IS IN ACCORDANCE WITH BRISBANE CITY COUNCIL ENVIRONMENTAL BEST PRACTICE NOTES.
- SITE SETOUT TO BE VERIFIED BY SUPERINTENDENT OR LANDSCAPE ARCHITECT PRIOR TO THE COMMENCEMENT OF CONSTRUCTION WORKS.
- VERIFY LOCATION OF ALL SERVICES AND EASEMENTS PRIOR TO THE COMMENCEMENT OF WORKS.
- WRITTEN DIMENSIONS TAKE PRECEDENCE OVER SCALED DISTANCES.
- VERIFY ALL DIMENSIONS ON SITE PRIOR TO CONSTRUCTION.
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- IN EACH CASE ENGINEERING CERTIFICATION AND MODIFICATION AS NECESSARY WILL BE REQUIRED FOR PARTICULAR SOIL AND SITE CONDITIONS.
- THE COPYRIGHT OF THIS DRAWING REMAINS THE PROPERTY OF THE BRISBANE CITY COUNCIL.
- DIMENSIONS IN MILLIMETRES (UNO).

FOOTINGS

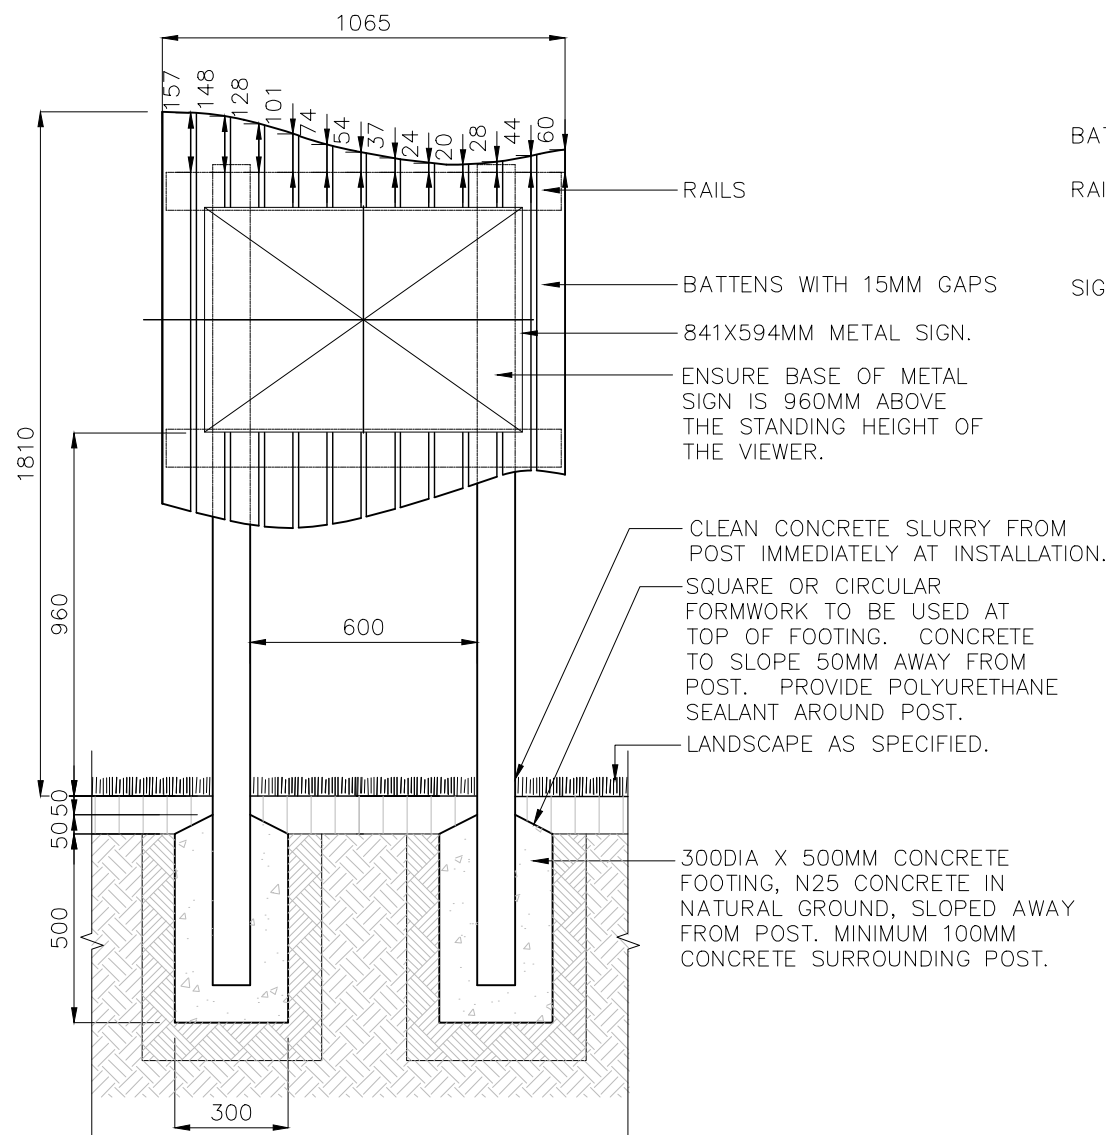AS DETAILED

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ALL TIMBER TO BE ACQ TREATED ROUGH SAWN SELECT GRADE HARDWOOD OF A SINGLE SPECIES.
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ALL TIMBER TO BE FREE OF KNOTS, SPLINTERS, CRACKS OR ANY MAJOR DEFECT.
ALL EXPOSED EDGES TO BE ARRISSED 4MM.
POSTS TO BE 100X100MM WITH CHAMFERED TOPS
RAILS TO BE 100X50MM
BATTENS TO BE 75X38MM

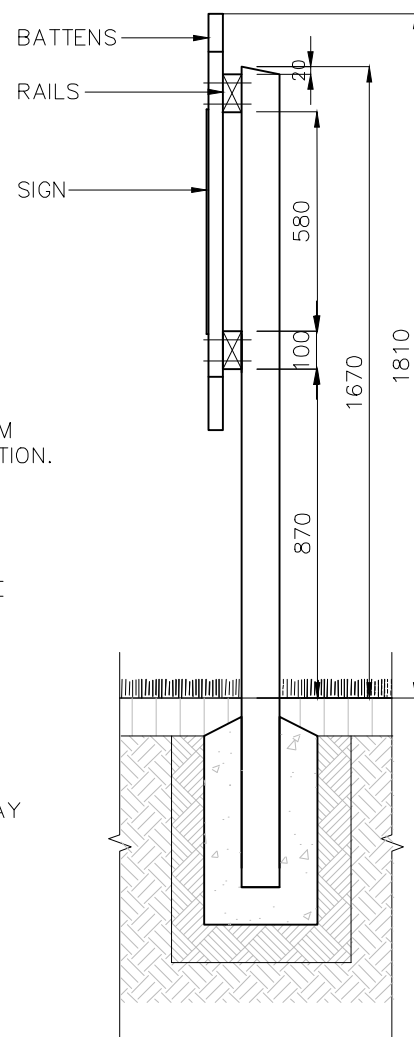SIGN

SIGN BLADES TO BE 16 GAUGE, 1.6MM THICK ALUMINIUM IMAGED PLATE.
CORNERS OF SIGNS TO HAVE 5MM RADIUS WITH ALL CORNERS/EDGES TO BE FREE OF BURRS.
ANTI-GRAFFITI CLEAR FILM OR SIMILAR PRODUCT TO FINISHED SURFACE OF SIGN.
CONTENT WILL BE SITE SPECIFIC AND DEPEND ON LOCATION AND INFORMATION NEEDED TO BE CONVEYED. REFER TO BSD-10503-PARK SIGNAGE-GRAPHIC NOTES FOR CLEAT AND BCC LOGO SPECIFICATIONS.

FIXINGS

ALL FIXINGS TO BE STAINLESS STEEL.
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FINISHES

TIMBER TO BE PRIMED AND THEN FINISHED WITH MINIMUM 2 NO. COATS OF DULUX 'PINE NEEDLE' COLOUR.
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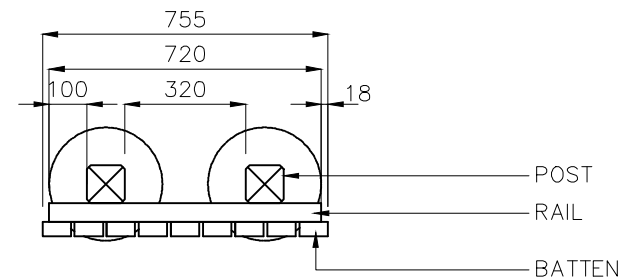
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| DRAWN | CP0 - P&D | DATE | DEC '14 |
| CHECKED | BI - FSG - AS | DATE | DEC '14 |
| DRAWING FILENAME | BSD-10515 BI Advisory sign - Natural area - A1 size Track commencement - Sheet 1 of 2.dwg | | |
| ASSOCIATED PLANS | BSD-10515-Sheet 2 | | |




BRISBANE CITY COUNCIL STANDARD DRAWING

ADVISORY SIGN - NATURAL AREA
A1 SIZE TRACK COMMENCEMENT
SHEET 1 OF 2


| | |
|---------------|-----------|
| SCALE | AS SHOWN |
| DWG No. | BSD-10515 |
| ORIGINAL SIZE | A3 |
| REVISION | B |




PLAN
SCALE 1: 20

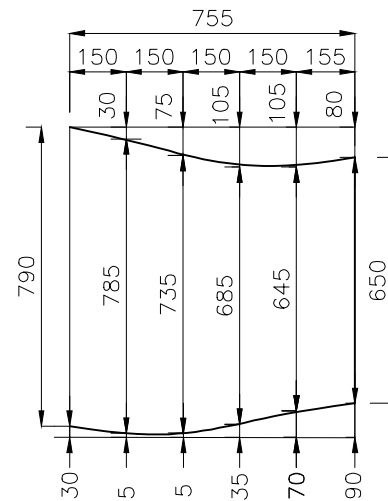

BATTEN CURVE SET OUT
SCALE 1: 20

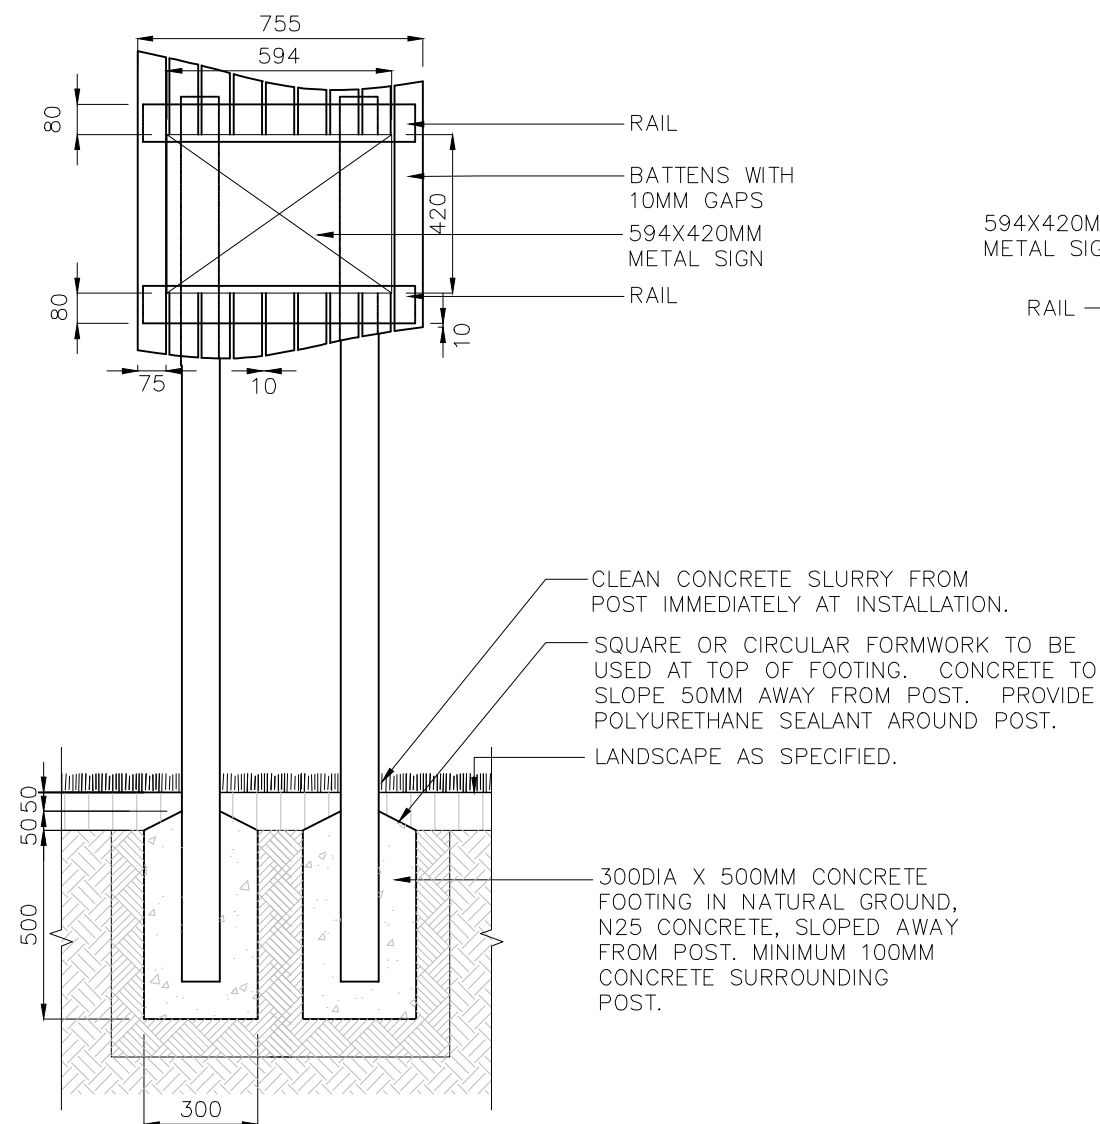

ELEVATION
SCALE 1: 20

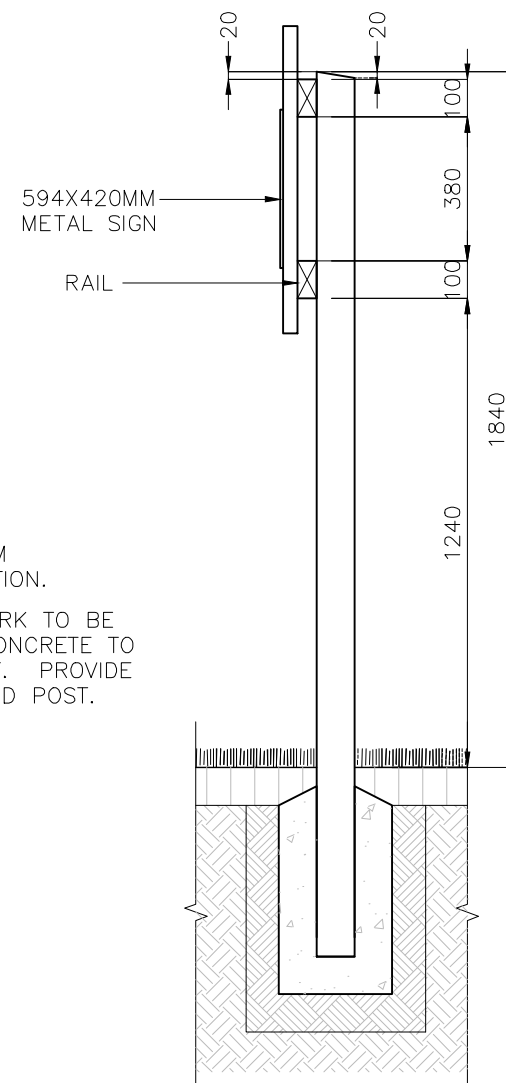

SECTION
SCALE 1: 20

GENERAL NOTES

- ENSURE THAT WORK IS IN ACCORDANCE WITH BRISBANE CITY COUNCIL ENVIRONMENTAL BEST PRACTICE NOTES.
- SITE SETOUT TO BE VERIFIED BY SUPERINTENDENT OR LANDSCAPE ARCHITECT PRIOR TO THE COMMENCEMENT OF CONSTRUCTION WORKS.
- VERIFY LOCATION OF ALL SERVICES AND EASEMENTS PRIOR TO THE COMMENCEMENT OF WORKS.
- WRITTEN DIMENSIONS TAKE PRECEDENCE OVER SCALED DISTANCES.
- VERIFY ALL DIMENSIONS ON SITE PRIOR TO CONSTRUCTION.
- STRUCTURES HAVE BEEN DESIGNED ON THE ASSUMPTION THAT THE MINIMUM ALLOWABLE BEARING CAPACITY FOR SOIL IS 100KPA AND TERRAIN CATEGORY = 2.5.
- IN EACH CASE ENGINEERING CERTIFICATION AND MODIFICATION AS NECESSARY WILL BE REQUIRED FOR PARTICULAR SOIL AND SITE CONDITIONS.
- THE COPYRIGHT OF THIS DRAWING REMAINS THE PROPERTY OF THE BRISBANE CITY COUNCIL.
- DIMENSIONS IN MILLIMETRES (UNO).

FOOTINGS

AS DETAILED TIMBER WORK

ALL TIMBER TO BE ACQ TREATED ROUGH SAWN SELECT GRADE HARDWOOD OF A SINGLE SPECIES.
ALL TIMBER IN CONTACT WITH GROUND TO BE PRESERVATIVE TREATED TO HAZARD CLASS H5 TO AS1604.1–2000 AND HAVE A DURABILITY CLASS 1 (IN GROUND) TO AS5604–2003.
ALL TIMBER TO BE FREE OF KNOTS, SPLINTERS, CRACKS OR ANY MAJOR DEFECT.
ALL EXPOSED EDGES TO BE ARRISSED 4MM.
POSTS TO BE 100X100MM WITH CHAMFERED TOPS
RAILS TO BE 100X50MM
BATTENS TO BE 75X38MM

SIGN


SIGN BLADES TO BE 16 GAUGE, 1.6MM THICK ALUMINIUM IMAGED PLATE.
CORNERS OF SIGNS TO HAVE 5MM RADIUS WITH ALL CORNERS/EDGES TO BE FREE OF BURRS.
ANTI–GRAFITTI CLEAR FILM OR SIMILAR PRODUCT TO FINISHED SURFACE OF SIGN.
CONTENT WILL BE SITE SPECIFIC AND DEPEND ON LOCATION AND INFORMATION NEEDED TO BE CONVEYED.
REFER TO BSD–10503–PARK SIGNAGE–GRAPHIC NOTES FOR CLEAT AND BCC LOGO SPECIFICATIONS.


FIXINGS

ALL FIXINGS TO BE STAINLESS STEEL.
RAILS – TO BE FIXED TO POSTS WITH M10 HEX HEAD BOLTS WITH MATCHING NUTS AND WASHERS, RECESSED ON FRONT, 2 NO. PER POINT OF FIXING.
BATTENS – TO BE FIXED TO RAILS WITH BUGLE SCREWS, 2 NO. PER POINT OF FIXING.
METAL SIGN – TO BE FIXED TO BATTENS WITH TORX HEAD VANDAL RESISTANT SCREWS.

FINISHES

TIMBER TO BE PRIMED AND THEN FINISHED WITH MINIMUM 2 NO. COATS OF DULUX ‘PINE NEEDLE’ COLOUR.
COLOUR SELECTION IN ACCORDANCE WITH THE NATURAL AREAS DESIGN MANUAL COLOUR SCHEDULE.

| | | | | | | | | | | | | | | | | | | | | |
|-------|-----------------------|---------------|---------------|----------------|---|--|--|--|---------------------|--|---|------|---------|---|--|--|--|--|----------------|--|
| | | | | | DRAWING AUTHORISED FOR PUBLICATION | | | | DESIGN | | CP0 - P&D | DATE | DEC '14 |  | BRISBANE CITY COUNCIL STANDARD DRAWING | | | | | |
| | | | | | Inga Cendric 2015.06.05 07:51:36+10'00' | | | | DRAWN | | CP0 - P&D | DATE | DEC '14 | | ADVISORY SIGN – NATURAL AREA A2 SIZE TRACK COMMENCEMENT SHEET 2 OF 2 | | | | | |
| | | | | | for ASSET ENGINEERING MANAGER STRATEGIC ASSET MANAGEMENT | | | | CHECKED | | BI - FSG - AS | DATE | DEC '14 | | | | | | SCALE AS SHOWN | |
| | | | | | DESIGN APPROVED | | | | DRAWING FILENAME | | BSD-10515 B) Advisory sign - Natural area - A2 size Track commencement - Sheet 2 of 2.dwg | | | | | | | | | |
| B | Drawing Title Amended | FEB '16 | JUL '16 | JUL '16 | C.Wood | | | | ASSOCIATED PLANS | | BSD-10515-Sheet 1 | | | | DWS No. BSD-10515 | | | | | |
| A | ORIGINAL ISSUE | DEC '14 | DEC '14 | DEC '14 | SENIOR CO-ORDINATOR NATURAL ENVIRONMENT ASSET SERVICES/BRISBANE INFRASTRUCTURE | | | | | | | | | | ORIGINAL SIZE A3 | | | | | |
| ISSUE | AMENDMENT | DRAWN DATE | CHK'D DATE | APPR'D DATE | | | | | | | | | | | REVISION B | | | | | |

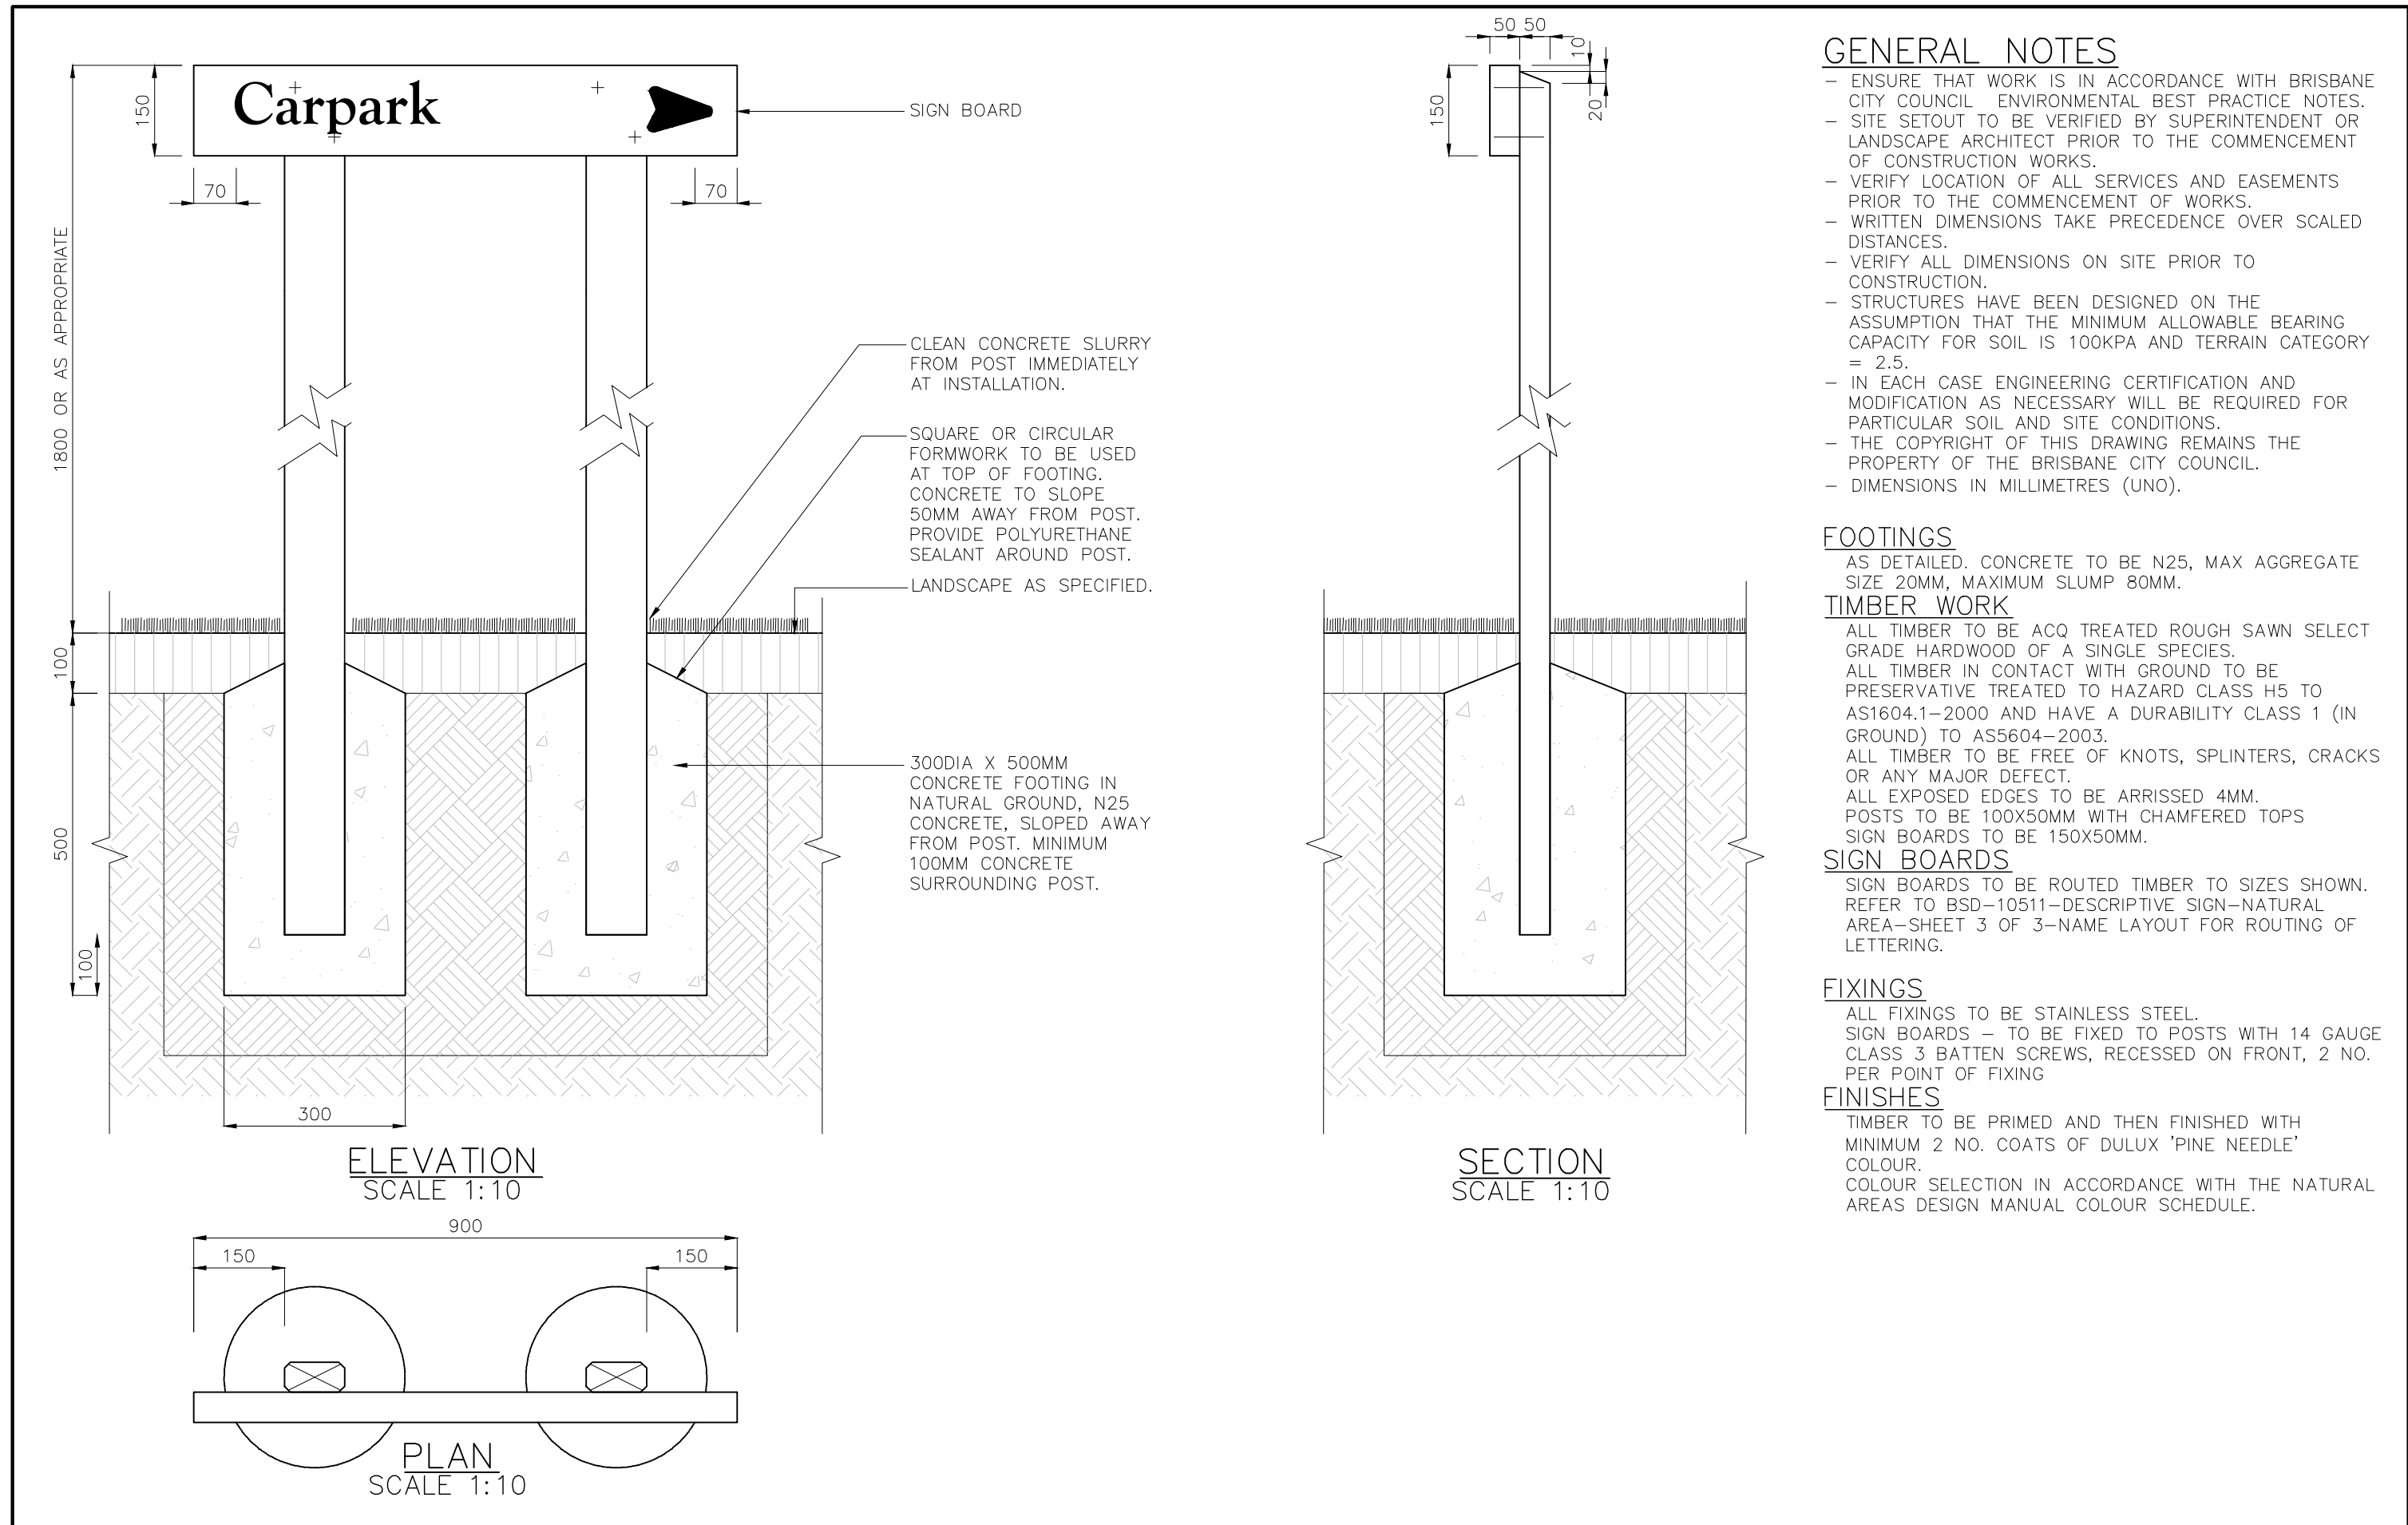

GENERAL NOTES

- ENSURE THAT WORK IS IN ACCORDANCE WITH BRISBANE CITY COUNCIL ENVIRONMENTAL BEST PRACTICE NOTES.
- SITE SETOUT TO BE VERIFIED BY SUPERINTENDENT OR LANDSCAPE ARCHITECT PRIOR TO THE COMMENCEMENT OF CONSTRUCTION WORKS.
- VERIFY LOCATION OF ALL SERVICES AND EASEMENTS PRIOR TO THE COMMENCEMENT OF WORKS.
- WRITTEN DIMENSIONS TAKE PRECEDENCE OVER SCALED DISTANCES.
- VERIFY ALL DIMENSIONS ON SITE PRIOR TO CONSTRUCTION.
- STRUCTURES HAVE BEEN DESIGNED ON THE ASSUMPTION THAT THE MINIMUM ALLOWABLE BEARING CAPACITY FOR SOIL IS 100KPA AND TERRAIN CATEGORY = 2.5.
- IN EACH CASE ENGINEERING CERTIFICATION AND MODIFICATION AS NECESSARY WILL BE REQUIRED FOR PARTICULAR SOIL AND SITE CONDITIONS.
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- DIMENSIONS IN MILLIMETRES (UNO).

FOOTINGS

AS DETAILED. CONCRETE TO BE N25, MAX AGGREGATE SIZE 20MM, MAXIMUM SLUMP 80MM.

TIMBER WORK

ALL TIMBER TO BE ACQ TREATED ROUGH SAWN SELECT GRADE HARDWOOD OF A SINGLE SPECIES.
ALL TIMBER IN CONTACT WITH GROUND TO BE PRESERVATIVE TREATED TO HAZARD CLASS H5 TO AS1604.1–2000 AND HAVE A DURABILITY CLASS 1 (IN GROUND) TO AS5604–2003.
ALL TIMBER TO BE FREE OF KNOTS, SPLINTERS, CRACKS OR ANY MAJOR DEFECT.
ALL EXPOSED EDGES TO BE ARRISSED 4MM.
POSTS TO BE 100X50MM WITH CHAMFERED TOPS
SIGN BOARDS TO BE 150X50MM.

SIGN BOARDS


SIGN BOARDS TO BE ROUTED TIMBER TO SIZES SHOWN. REFER TO BSD–10511–DESCRIPTIVE SIGN–NATURAL AREA–SHEET 3 OF 3–NAME LAYOUT FOR ROUTING OF LETTERING.

FIXINGS

ALL FIXINGS TO BE STAINLESS STEEL.
SIGN BOARDS – TO BE FIXED TO POSTS WITH 14 GAUGE CLASS 3 BATTEN SCREWS, RECESSED ON FRONT, 2 NO. PER POINT OF FIXING

FINISHES

TIMBER TO BE PRIMED AND THEN FINISHED WITH MINIMUM 2 NO. COATS OF DULUX 'PINE NEEDLE' COLOUR.
COLOUR SELECTION IN ACCORDANCE WITH THE NATURAL AREAS DESIGN MANUAL COLOUR SCHEDULE.

| | | | | | | | | | | | | | | | | | | |
|-------|----------------|---------------|---------------|----------------|---|--|--|--|---------------------|--|--|------|---------|---|--|--|--|--|
| | | | | | DRAWING AUTHORISED FOR PUBLICATION | | | | DESIGN | | CP0 - P&D | DATE | DEC '14 |  | BRISBANE CITY COUNCIL STANDARD DRAWING | | | |
| | | | | | Inga Cendric 2015.06.05 07:52:51+10'00" for ASSET ENGINEERING MANAGER STRATEGIC ASSET MANAGEMENT | | | | DRAWN | | CP0 - P&D | DATE | DEC '14 | | ADVISORY SIGN NATURAL AREA DIRECTIONAL | | | |
| | | | | | DESIGN APPROVED | | | | CHECKED | | BI - FSG - AS | DATE | DEC '14 | | | | | |
| | | | | | C. Wood | | | | DRAWING FILENAME | | BSD-10516 (A) Advisory sign - Natural area - Directional.dwg | | | | | | | |
| A | ORIGINAL ISSUE | DEC '14 | DEC '14 | DEC '14 | SENIOR CO-ORDINATOR NATURAL ENVIRONMENT ASSET SERVICES/BRISBANE INFRASTRUCTURE | | | | ASSOCIATED PLANS | | | | | | SCALE AS SHOWN Dwg No. BSD-10516 | | | |
| ISSUE | AMENDMENT | DRAWN DATE | CHK'D DATE | APPR'D DATE | | | | | | | | | | ORIGINAL SIZE A3 | REVISION A | | | |

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- DIMENSIONS IN MILLIMETRES (UNO).

FOOTINGS

AS DETAILED. CONCRETE TO BE N25, MAX AGGREGATE SIZE 20MM, MAX SLUMP 80MM.

SIGN

SIGN BACKING PLATE TO BE 5MM MS PLATE.
SIGN TO BE 16 GAUGE, 1.6MM THICK ALUMINIUM IMAGED PLATE.
CORNERS OF SIGNS TO HAVE 5MM RADIUS WITH ALL CORNERS/EDGES TO BE FREE OF BURRS.
ANTI-GRAFFITI CLEAR FILM OR SIMILAR PRODUCT TO FINISHED SURFACE OF SIGN.
CONTENT WILL BE SITE SPECIFIC AND DEPEND ON LOCATION AND INFORMATION NEEDED TO BE CONVEYED.
REFER TO BSD-10503-PARK SIGNAGE-GRAPHIC NOTES FOR CLEAT AND BCC LOGO SPECIFICATIONS.

FIXINGS

METAL SIGN – TO BE GLUED TO BACKING PLATE AND FIXED WITH RIVOTS.

FINISHES

WHERE STANDARD IS FOR USE IN A NON-MARINE ENVIRONMENT (UP TO 1KM FROM THE FORESHORE), THE FOLLOWING PROTECTION TREATMENT IS REQUIRED:


- HOT DIP GALVANISING: FERROUS OPEN SECTIONS TO AS4791;
- FERROUS HOLLOW SECTIONS TO AS4792.

WHERE STANDARD IS REQUIRED FOR USE WITHIN MARINE ENVIRONMENT, THE FOLLOWING PROTECTION TREATMENT IS REQUIRED:


- STEELWORK HOT DIP GALVANISING: 85 MICRONS (600G/M²) MIN;
- SWEEP ABRASIVE BLAST;
- STEELWORK FIRST COAT: EPOXY PRIMER 75 MICRONS MIN;
- STEELWORK SECOND COAT: TWO PACK ACRYLIC OR POLYURETHANE GLOSS 75 MICRONS MIN.

PAINT SYSTEMS TO BE IN ACCORDANCE WITH AS2312 AND IS DESIGNATED HDG600P6 AND HDG600P.

ALL JOINTS TO BE FULLY WELDED. WELDS TO BE 5 THICK C.F.W (CONTINUOUS FILLET WELDS) TO AS554.1.

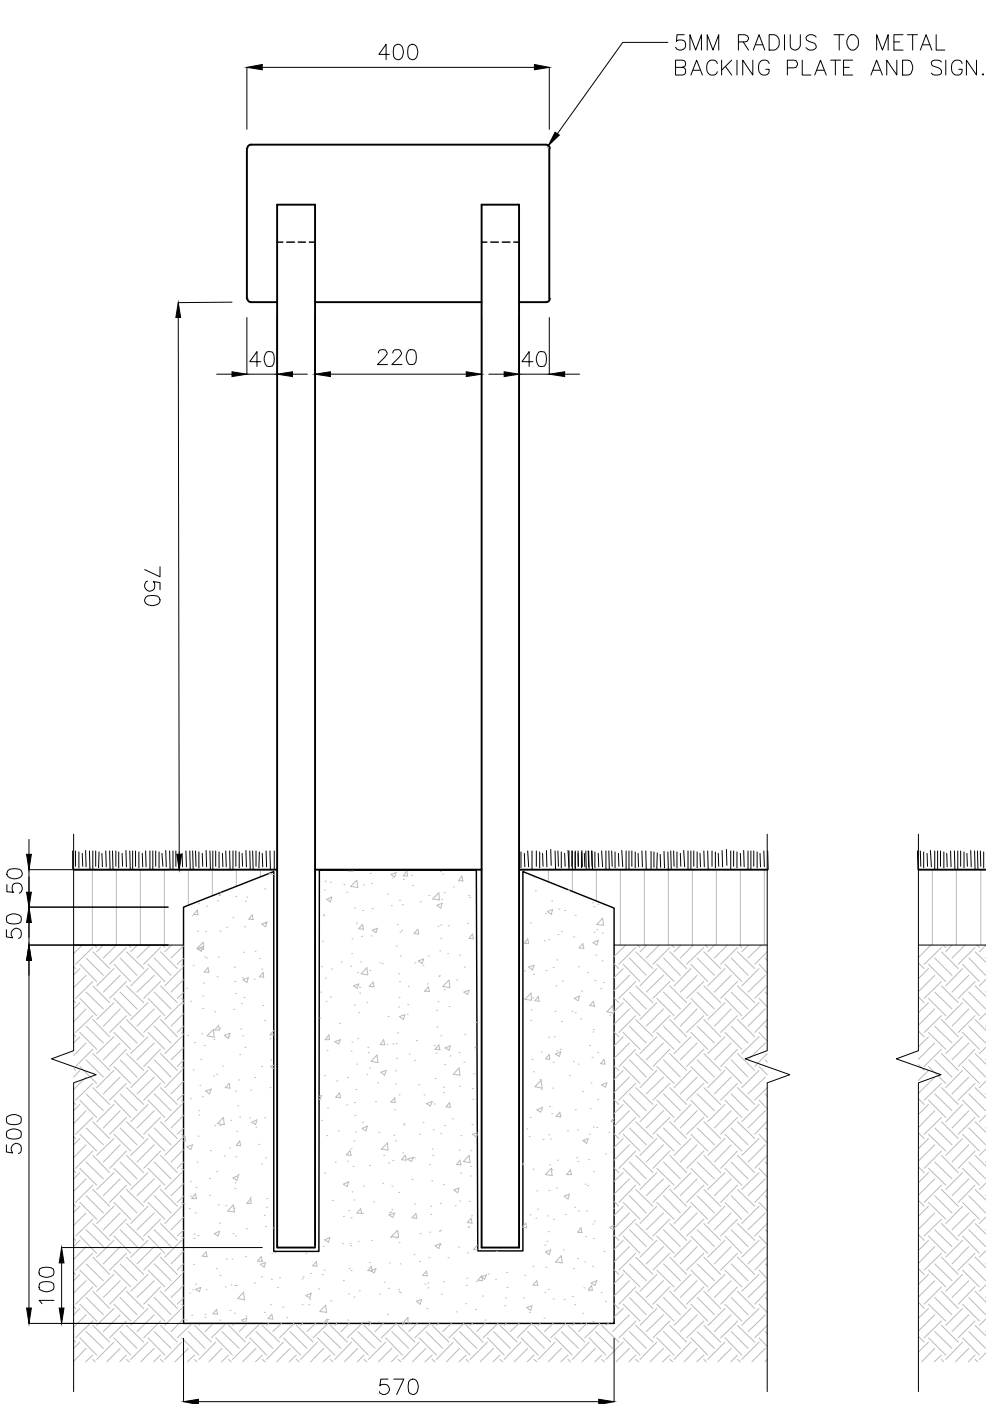


ELEVATION
SCALE 1:10

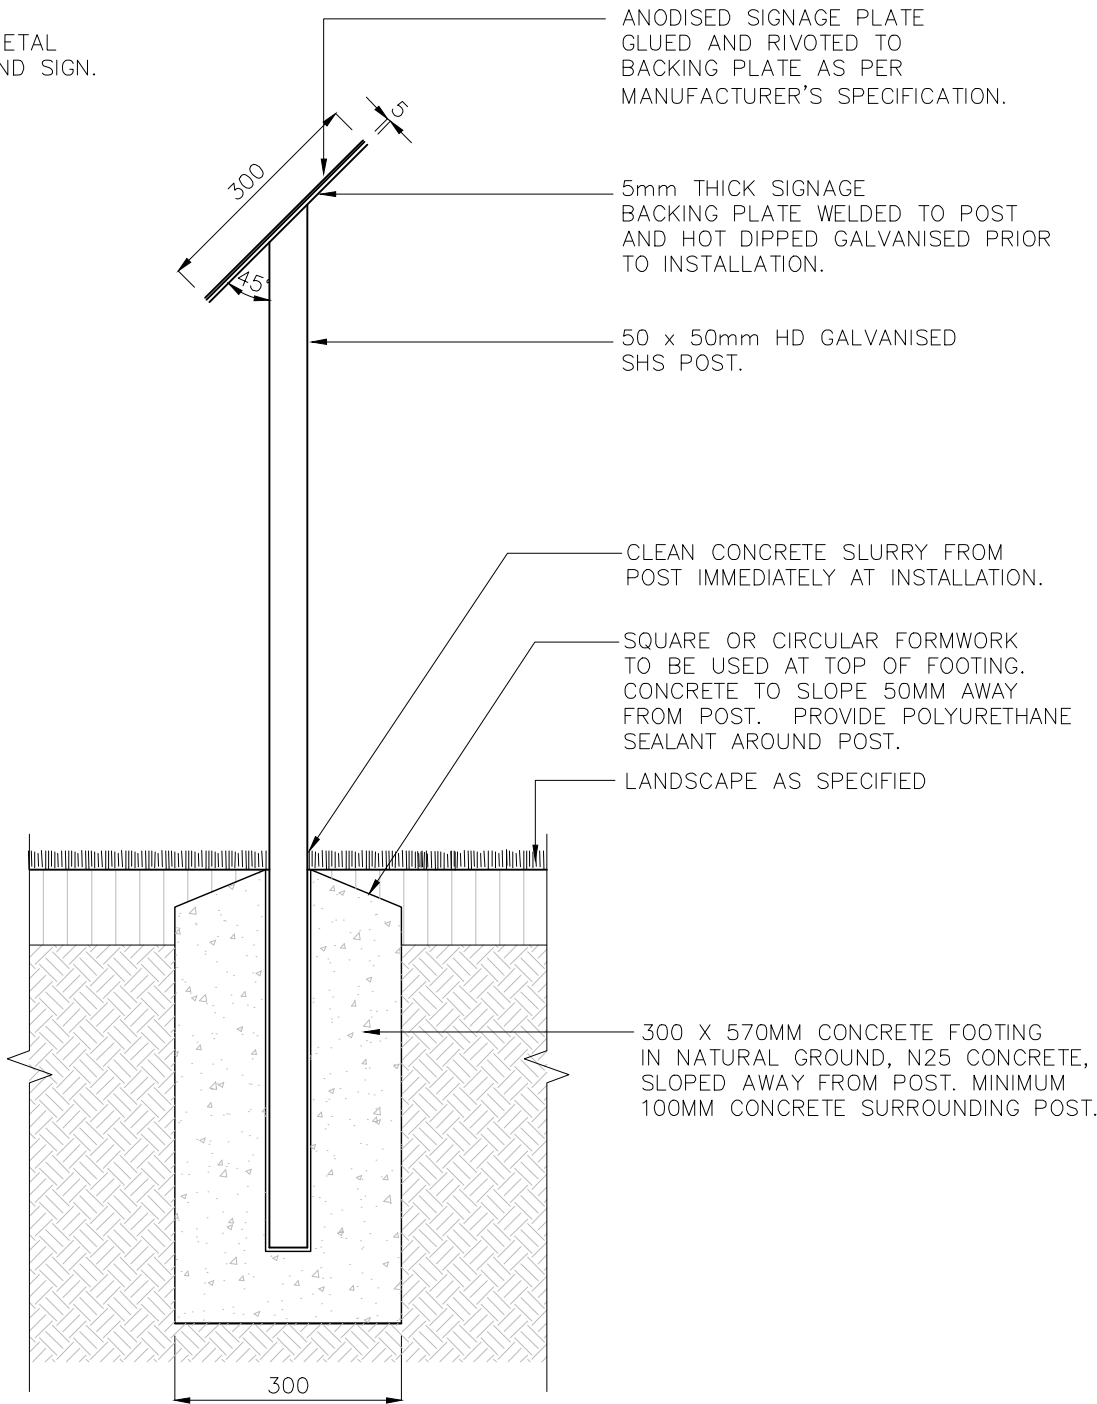

SECTION
SCALE 1:10


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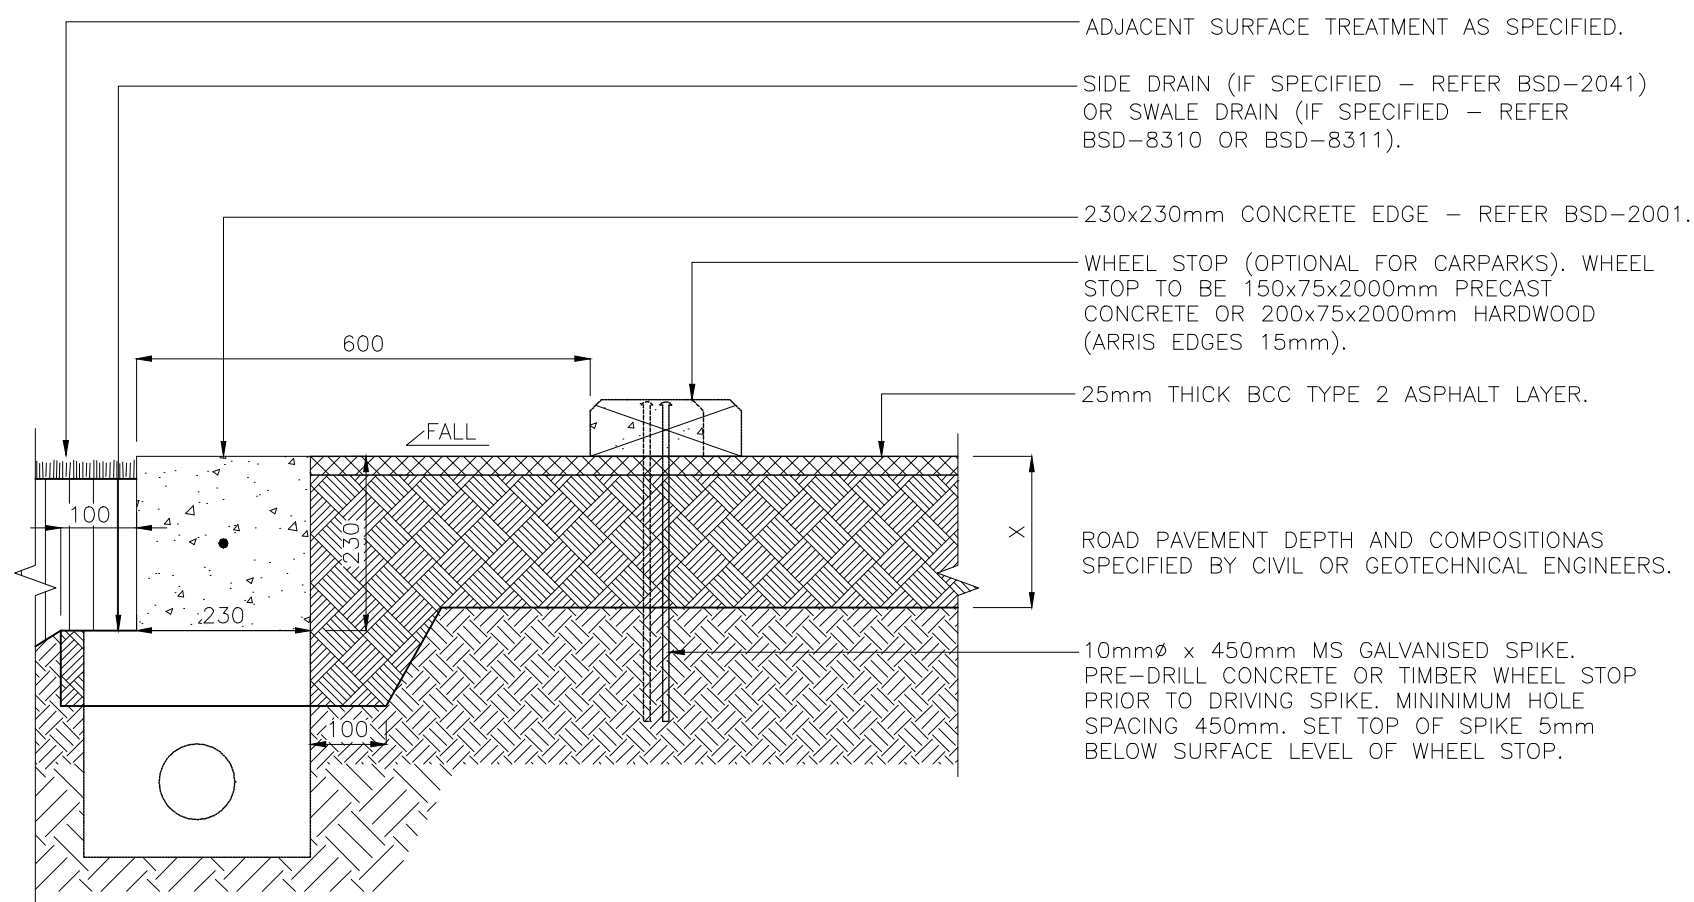

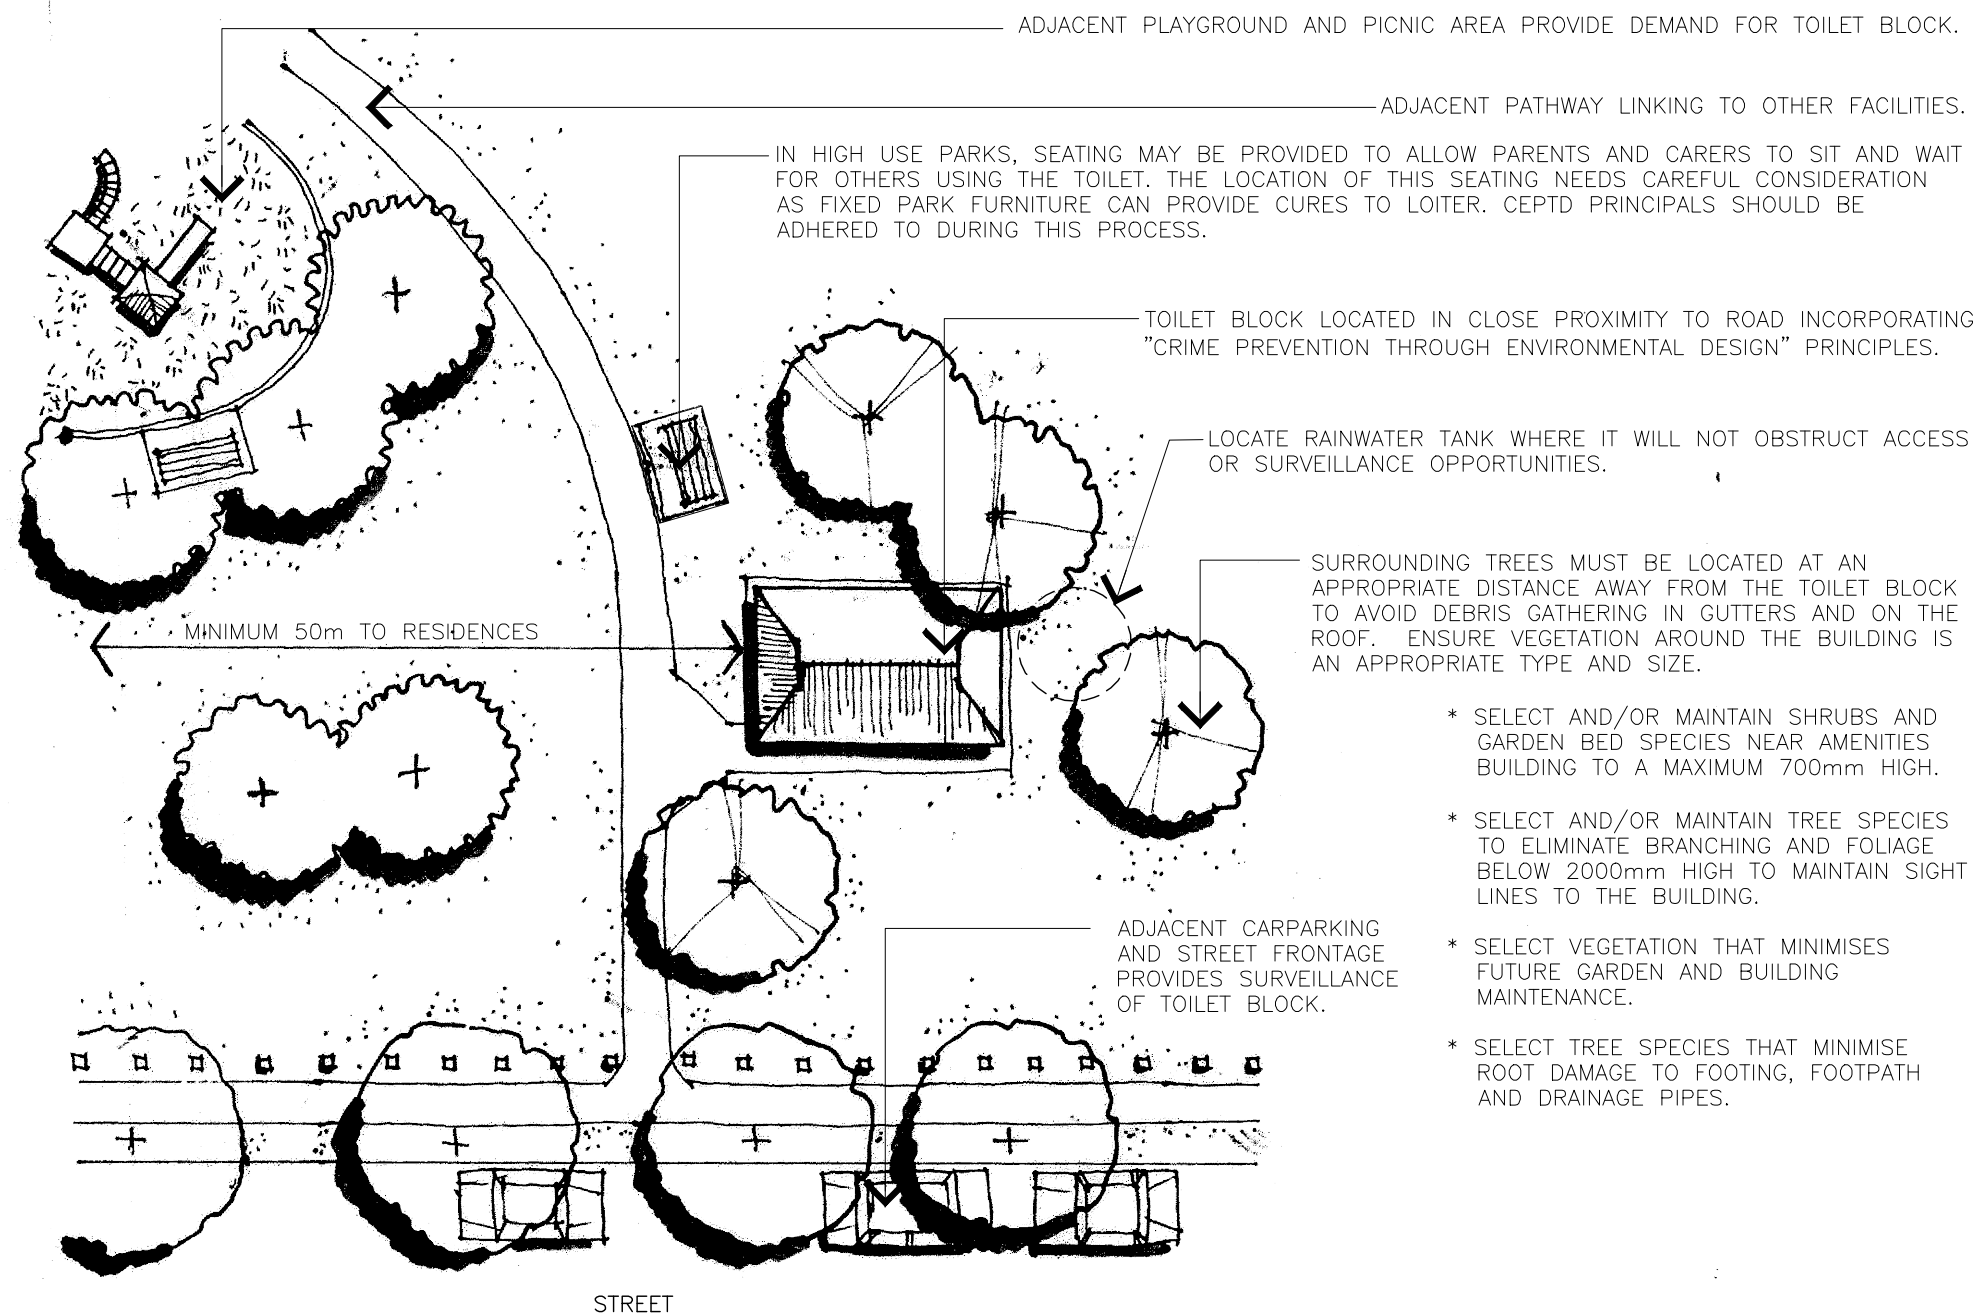
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- MATERIAL CHOICES ARE TO BE DETERMINED ON THE GROUNDS OF SUSTAINABILITY, LOW MAINTENANCE, VANDAL RESISTANCE, PRODUCT AVAILABILITY AND SUITABILITY TO THE CLIMATIC CONDITIONS. MATERIALS ARE TO BE LOCALLY SOURCED.
- WHERE SPECIFIED – SITE FURNITURE IS TO BE INCORPORATED AS PART OF INTEGRATED PICNIC SETTING NODE. REFER BSD-10003 FOR SUPPLIERS.
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- NOT PROVIDED WHERE ALTERNATIVE TOILET FACILITIES ARE AVAILABLE E.G. A 7 DAY A WEEK SHOPPING CENTRE NEARBY, A COMMUNITY BUILDING WITH TOILETS ETC.
- SITED MORE THAN 50m FROM NEAREST PRIVATE RESIDENCE OR SITED SO AS TO NOT CAUSE A NUISANCE TO NEIGHBOURS.
- REASONABLE PROXIMITY TO ONE OR MORE DEMAND SOURCES SUCH AS A CARPARK, PICNIC AREA, PLAYGROUND, BIKEWAY NETWORK, ETC.
- BUILT ON SUITABLE TERRAIN TO FACILITATE ACCESSIBILITY. CONTINUOUS ACCESSIBLE PATH OF TRAVEL FROM DEMAND SOURCES TO TOILET.
- CLOSE PROXIMITY TO A ROAD, GATE OR INTERNAL TRACK FOR SERVICING.
- FACING TOWARDS MOST ACTIVE SPACE.
- INCORPORATING "CRIME PREVENTION THROUGH ENVIRONMENTAL DESIGN" PRINCIPLES E.G. SURVEILLANCE POSSIBLE FROM A PUBLIC ROAD OR OTHER SITE OF REGULAR PEOPLE PRESENCE, NO CONCEALING VEGETATION.
- NOT OBSTRUCTING LINKS BETWEEN VISITOR NODES AND PARK FACILITIES.
- UNOBTRUSIVE IN THE LANDSCAPE.
- EXTERNAL SHELTER PROVIDED E.G. VERANDAHS.
- TOILET BLOCK TO COMPLY WITH AUSTRALIAN STANDARDS AND COUNCIL REQUIREMENTS FOR ACCESS & MOBILITY (AS 1428).
- REFER TO BRISBANE CITY COUNCIL'S "PUBLIC TOILET DESIGN GUIDELINES"
- RAINWATER TANK TO BE INSTALLED IN ACCORDANCE WITH DETAILED LANDSCAPE PLAN, AND PARKS CHAPTER OF INFRASTRUCTURE DESIGN PLANNING SCHEME POLICY.

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| | | | | | DRAWING AUTHORISED FOR PUBLICATION PAUL COTTON SIGNATURE ON ORIGINAL DATED 03/09/04 MANAGER INFRASTRUCTURE MANAGEMENT R.P.E.O. 2546 | DESIGN | Std Dwgs WG | DATE | OCT '13 |  | BRISBANE CITY COUNCIL STANDARD DRAWING | | |
| | | | | | DESIGN APPROVED LAUREN TEMPLEMAN SIGNATURE ON ORIGINAL DATED 31/08/04 | DRAWN | CPO - P&D | DATE | OCT '13 | | <div>TOILET BLOCK SITING PLAN</div> | SCALE 1:100 | |
| | | | | | | CHECKED | UMD - E&P & IMB | DATE | OCT '13 | | | DWG No. BSD-10701 | |
| A | Drawing Converted From UMS Series April 2014 | | | APR '14 | | APR '14 | APR '14 | DRAWING FILENAME BSD-10701 (A) Toilet block - siting plan.dwg | | | | ORIGINAL SIZE A3 | REVISION A |
| ISSUE | AMENDMENT | | | DRAWN DATE | CHK'D DATE | APPR'D DATE | ASSOCIATED PLANS SUPERSEDES UMS-752 | | | | | | |
| | | | | | PRICIPAL PROGRAM OFFICER PARKS | | | | | | | | |



ASPHALT INTERNAL ROAD/CARPARK – SECTION

GENERAL NOTES


- ENSURE PARK ELEMENTS ARE LOCATED AND CONSTRUCTED IN ACCORDANCE WITH DETAILED LANDSCAPE PLAN AND PARKS CHAPTER OF INFRASTRUCTURE DESIGN PLANNING SCHEME POLICY.
- MATERIAL CHOICES ARE TO BE DETERMINED ON THE GROUNDS OF SUSTAINABILITY, LOW MAINTENANCE, VANDAL RESISTANCE, PRODUCT AVAILABILITY AND SUITABILITY TO THE CLIMATIC CONDITIONS. MATERIALS ARE TO BE LOCALLY SOURCED.
- ENSURE MOWN HEIGHT OF GRASS (TURF) AREAS FINISHES FLUSH WITH CONCRETE EDGE.
- ENSURE GARDEN AREAS (MULCH) FINISH 25mm BELOW ADJACENT F.S.L's OF CONCRETE EDGE.
- PAVEMENT SURFACE TO BE BCC TYPE 2 ASPHALT. REFER BCC "REFERENCE SPECIFICATIONS FOR CIVIL ENGINEERING WORKS" S130 - SUPPLY OF DENSE GRADED ASPHALT.
- AUSTRALIAN STANDARDS SHALL BE IN ACCORDANCE WITH THE CURRENT EDITIONS OF THE REFERENCED AUSTRALIAN STANDARDS EXCEPT WHERE VARIED BY SPECIFICATIONS AND/OR DRAWINGS.
- CARPARKS TO COMPLY WITH AUSTRALIAN STANDARDS AND COUNCIL REQUIREMENTS FOR ACCESS & MOBILITY (AS 1428).
- REFER TO THE BRISBANE ACCESS AND INCLUSION PLAN 2012-2017 FOR FURTHER INFORMATION WHEN PLANNING AND DESIGNING THE BUILT ENVIRONMENT TO REASONABLY CONSIDER ACCESS AND INCLUSION FOR ALL WHERE APPROPRIATE.
- ALL DIMENSION IN MILLIMETRES (U.N.O.).

CONCRETE WORKS

- ALL CONCRETE, JOINTS AND SLIP RESISTANCE REQUIREMENTS TO COMPLY WITH "REFERENCE SPECIFICATIONS FOR CIVIL ENGINEERING WORK" - S150 ROADWORKS; 5.0 CONCRETE KERBS AND CHANNELS.
- ALL EXTRUDED CONCRETE EDGING TO BE MINIMUM GRADE N32 WITH Y12 REINFORCING, MIN. TOP COVER OF 50mm. CONCRETE SHALL BE NORMAL CLASS CONCRETE UNLESS SPECIFIED OTHERWISE. N32 SHALL MEAN NORMAL CLASS CONCRETE WITH A 28 DAY CHARACTERISTIC STRENGTH OF 32MPa. CONCRETE MIX SHALL BE APPROVED BY THE SUPERINTENDENT PRIOR TO PLACING.
- MAXIMUM AGGREGATE SIZE 20mm, MINIMUM SLUMP 80mm.
- ALL CEMENT TO BE TYPE GP OR GB TO AS 3972 UNLESS SPECIFIED OTHERWISE.
- ALL FORMWORK SHALL BE IN ACCORDANCE WITH SAA FORMWORK CODE AS 3610.
- ALL ROADS/CARPARKS AREAS TO HAVE 1:50 MINIMUM CROSSFALL.

TIMBER WORK NOTES

- TIMBER SHOULD BE SOURCED FROM LEGAL AND SUSTAINABLE SOURCES. TIMBERS ARE CONSIDERED ACCEPTABLE WHERE THERE IS A HIGH DEGREE OF CERTAINTY THAT THEY ARE FROM FORESTS, EITHER NATIVE OR PLANTATION, THAT ARE LEGALLY HARVESTED AND SUSTAINABLY MANAGED. THE CONTRACTOR IS TO SUBMIT EVIDENCE THAT THE TIMBER HAS BEEN OBTAINED FROM A LEGAL AND SUSTAINABLE SOURCE.
- ALL TIMBER TO BE ACQ PRESSURE TREATED OR TANALITH E (COPPER AZOL) TO AS 1608 TREATED ROUGH SAWN APPEARANCE GRADE HARDWOOD OF ONE SPECIES.
- ALL EXPOSED EDGES TO RECEIVE MIN. 5mm WIDE ARRIS.
- PRIOR TO INSTALLATION, ALL CUTS, EDGES, JOINTS TO RECEIVE LIBERAL COATINGS WITH AN APPROVED TIMBER PRESERVATIVE.
- ALL TIMBER IN CONTACT WITH GROUND TO BE PRESERVATIVE TREATED TO HAZARD CLASS H5 TO AS 1604 AND HAVE A DURABILITY CLASS 1 OR 2 TO AS 5604.
- ALL TIMBER TO BE FREE OF KNOTS, SPLINTERS, CRACKS OR ANY MAJOR DEFECT.
- TIMBER PRESERVATIVES – WHERE NO FINISH SPECIFIED, ALL TIMBER TO RECEIVE 3 No COATS OF CLEAR APPROVED TIMBER PRESERVATIVE SUCH AS COPPER NAPHTHENATE OIL (FOR ABOVE GROUND USE) AND COPPER NAPHTHENATE EMULSION (FOR BELOW GROUND USE).

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|-------|--|------------|------------|-------------|---|------------------|--|------|---------|---|--|-------------------------------|------------|------------------|--|------------|--|
| | | | | | <div>DRAWING AUTHORISED FOR PUBLICATION PAUL COTTON SIGNATURE ON ORIGINAL DATED 03/09/04 ----- MANAGER INFRASTRUCTURE MANAGEMENT R.P.E.Q. 2546 DESIGN APPROVED LAUREN TEMPLEMAN SIGNATURE ON ORIGINAL DATED 31/08/04 ----- PRINCIPAL PROGRAM OFFICER PARKS</div> | DESIGN | Std Dwgs WG | DATE | OCT '13 |  | BRISBANE CITY COUNCIL STANDARD DRAWING | | SCALE 1:10 | | | | |
| | | | | | | DRAWN | CP0 - P&D | DATE | OCT '13 | | DWG No. | BSD-10740 | | | | | |
| B | Drawing Title Amended, HWD Wheel Stop Length Amended | FEB '16 | JUL '16 | JUL '16 | | CHECKED | UMD - E&P & IMB | DATE | OCT '13 | | | | | | | | |
| A | Drawing Converted From UMS Series April 2014 | APR '14 | APR '14 | APR '14 | | DRAWING FILENAME | BSD-10740 (B) Internal asphalt road_car park.dwg | | | | | | | | | | |
| ISSUE | AMENDMENT | DRAWN DATE | CHK'D DATE | APPR'D DATE | | ASSOCIATED PLANS | SUPERSEDES UMS-748 | | | | | | | | | | |
| | | | | | | | | | | | | INTERNAL ASPHALT ROAD/CARPARK | | ORIGINAL SIZE A3 | | REVISION B | |